





Plant 1.0 MTPA ALUMINA REFINERY STREAM-5	Client NALCO	Contract Code NAL	Document ID 6695-ELT-G00-EC-0027	Contract No. 66-6695	
	TECHNICAL SPECIFICATIONS – ELECTRICAL INSTALLATION			 नेशनल एल्युमिनियम कम्पनी लिमिटेड National Aluminium Company Ltd.	
				Rev	00

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Remarks for AC2 : This marked-up drawings is hereby approved for fabrication / manufacturing and shall be re-submitted after revision. This drawing should be revised only to the extent of TKIS - India / Owner / Client comments. Any other changes made by you will not be considered unless clearly highlighted in covering letter asking for approval.																																																	
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Plant 1.0 MTPA ALUMINA REFINERY STREAM-5	Client NALCO	Contract Code NAL	Document ID 6695-ELT-G00-EC-0027	Contract No. 66-6695
	TECHNICAL SPECIFICATIONS – ELECTRICAL INSTALLATION			 नेशनल एल्युमिनियम कम्पनी लिमिटेड National Aluminium Company Ltd.
				Rev 00 Page 2 of 3

INDEX SHEET



The document Cover Sheet indicates revisions made in this document along with the purpose of issue of the revised document. The details of revisions made in the enclosures of this document are listed in the Table of Contents below and the enclosures listed therein are an integral part of this document.

Table of Contents:



Part	Size	Description	QAD Code	No. of Pages	Latest Rev.
-	A4	Index Sheet and Status of Revision	-	3	0
Part-I	A4	Installation Detail-Power	PIN-LEP-ELT-4001	26	0
Part-II	A4	Installation Detail-Earthing	PIN-LEP-ELT-4002	49	0
Part-III	A4	Installation Detail-Lighting	PIN-LEP-ELT-4003	55	0
Part-IV	A4	Installation Detail-Lightning Protection	PIN-LEP-ELT-4004	24	0
Part-V	A4	Installation Detail-Communication & Public Address	PIN-LEP-ELT-4010	24	0
Part-VI	A4	Installation Detail- Fire Alarm	PIN-LEP-ELT-4011	29	0

Notes:

- Typical Installation details given in this document are for reference only. These details shall give only a general guideline of how the installation is intended to be done.
- The complete supply and installation of all material included in the installation details is in the scope of **LSTK CONTRACTOR**. The installation details shall not be referred for any split of scope.
- Wherever there is mentioned '**CLIENT**', '**ELECTRICAL CONTRACTOR**', '**CIVIL CONTRACTOR**', 'etc in the installation details, it shall be read as '**LSTK CONTRACTOR**' **ONLY**. LSTK Contractor reserves the right to define scope of work internally between his electrical or civil contractor.
- Material indicated in the installation detail shall not be followed. For material of various equipment's & bulk items, LSTK Contractor shall refer to the project specific requirements indicated in the various technical specification included in Volume 4 section 06 of this tender. Accordingly installation details shall be updated by the LSTK Contractor.
- Requirement of quantities in installation detail are only for reference and shall be estimated by LSTK Contractor with respect to individual standards.
- Material for hardware/accessories shall be stainless steel.
- LSTK Contractor shall develop any additional detail not covered in this document but required for the installation of any equipment as per project requirement.



Plant 1.0 MTPA ALUMINA REFINERY STREAM-5	Client NALCO	Contract Code NAL	Document ID 6695-ELT-G00-EC-0027	Contract No. 66-6695
	ELECTRICAL INSTALLATION PART- I - INSTALLATION DETAIL-POWER			 नालको नेशनल एल्युमिनियम कम्पनी लिमिटेड National Aluminium Company Ltd.
				Rev 0 Page 1 of 8

INSTALLATION DETAIL-POWER

Plant 1.0 MTPA ALUMINA REFINERY STREAM-5	Client NALCO	Contract Code NAL	Document ID 6695-ELT-G00-EC-0027	Contract No. 66-6695
 thyssenkrupp	ELECTRICAL INSTALLATION PART- I - INSTALLATION DETAIL-POWER			 नेशनल एल्युमिनियम कम्पनी लिमिटेड National Aluminium Company Ltd.
				Rev 0 Page 2 of 8

LIST OF INSTALLATION STANDARDS

Sr. No.	Description	Typical No.	No. of Sheets	Rev
1	TYPICAL DETAILS FOR DIRECTLY BURIED CABLES	PCLB1	1	00
2	TYPICAL DETAILS FOR CABLES BURIED	PCLB2	1	00
3	TYPICAL DETAILS FOR CABLES LAID IN SAND FILLED BUILT-UP TRENCHES	PCLT1	2	00
4	TYPICAL DETAILS FOR CABLES LAID IN BUILT-UP TRENCHES WITH CABLE TRAY	PCLT2	2	00
5	CABLE MARKER	PCMG1	1	00
6	LOCAL CONTROL STATION ON BRICK/CONCRETE WALL	PCSC1	1	00
7	LOCAL CONTROL STATION ON SLEF-STANDING PEDESTAL	PCSP1	1	00
8	LOCAL CONTROL STATION ON STEEL PLATFORM/GRATING	PCSP2	1	00
9	LOCAL CONTROL STATION SUPPORTED FROM MOTOR FOUNDATION	PCSP3	1	00
10	LOCAL CONTROL STATION ON RAILING	PCSR1	1	00
11	LOCAL CONTROL STATION ON STEEL STRUCTURE	PCSS1	1	00
12	DISTRIBUTION BOARD/PANEL ($\leq 1000\text{MM}$) ON BRACKET, ON WALL/ CONCRETE COLUMN	PDBC1	1	00
13	DISTRIBUTION BOARD/PANEL ($\leq 1000\text{MM}$) ON BRACKET, ON STRUCTURAL COLUMN	PDBS1	1	00
14	DISTRIBUTION BOARD/ PANEL ON CONCRETE FLOOR, ON SELF STANDING PEDESTAL	PFPP1	1	00
15	DISTRIBUTION BOARD/ PANEL ON STEEL PLATFORM, ON SELF STANDING PEDESTAL	PFPP2	1	00
16	POWER & CONTROL CABLING FOR MOTORS, ROUTED ABOVE GROUND	PMAG1	1	00
17	POWER & CONTROL CABLING FOR MOTORS, ROUTED IN UNDERGROUND TRENCH	PMUG1	1	00
18	POWER & CONTROL CABLING FOR MOTORS, ROUTED IN UNDERGROUND TRENCH & CONDUITS	PMUG2	1	00
19	SOCKET OUTLET ON BRACKET, ON WALL/CONCRETE COLUMN	PSOC1	1	00
20	SOCKET OUTLET ON BRACKET, ON STRUCTURAL COLUMN	PSOS1	1	00
21	TYPICAL DETAILS OF CABLE TRAY SUPPORTING: TYPE-1	PCTS1	1	00
22	TYPICAL DETAILS OF CABLE TRAY SUPPORTING: TYPE-2	PCTS2	1	00
23	TYPICAL DETAILS OF CABLE TRAY SUPPORTING: TYPE-3	PCTS3	1	00
24	TYPICAL DETAILS OF CABLE TRAY SUPPORTING: TYPE-4	PCTS4	1	00
25	TYPICAL DETAILS OF CABLE TRAY SUPPORTING: TYPE-5	PCTS5	1	00
26	TYPICAL DETAILS OF CABLE TRAY SUPPORTING IN CELLAR	PCTS6	1	00
27	STANDARD STEEL SECTIONS: WEIGHT & DIMENSIONS	-	1	00

Plant 1.0 MTPA ALUMINA REFINERY STREAM-5	Client NALCO	Contract Code NAL	Document ID 6695-ELT-G00-EC-0027	Contract No. 66-6695		
 thyssenkrupp	ELECTRICAL INSTALLATION PART- I - INSTALLATION DETAIL-POWER			नालको  NALCO नेशनल एल्युमिनियम कम्पनी लिमिटेड National Aluminium Company Ltd.		
				Rev	0	Page

1. **General:**

- All the documents/drawings as indicated below shall be prepared by the LSTK Contractor as a part of detail Engineering.
- These notes shall be read and construed in conjunction with power layout drawings and Installation Standards - Power.
- Cable tray erection and cable laying shall be carried out as per Overall Cable Routing Layout, Power Layouts of individual units and Cable List.
- Routing of Power and control cables near the termination point shall suit the site conditions to facilitate easy maintenance, avoid damage during operation and maintain aesthetic appeal.
- Sealing compound shall be supplied and installed by the LSTK Contractor.



2. **Cable tray installation:**

- Installation of cable trays shall be carried out as detailed in layout drawings. Co-ordinates of cable trays shall be represented as distance of the tray centerline from a reference point.
- Cable tray shall be supported at intervals not exceeding 3 meters for horizontal run & 2 meters for vertical run.
- Cable tray supports and/ or insert plates shall be provided for supporting of Cable trays/ JB/ Socket outlets/ LCS/ SLDB using anchor fasteners.

3. **Cable laying :**

a. **Cable laying above ground:**

- Cables laid on trays below the slab shall be brought up through the slab, after drilling/ chipping at the required locations, pipes/ conduits shall be used for the slab crossings and the same shall be sealed adequately in an approved manner to prevent ingress of dust/ dirt and water after laying of cables.
- Wherever cables are not laid in the cable tray, same shall be laid in GI/ PVC conduits of suitable size up to the electrical equipment. If more than one cable is to be laid through GI/ PVC conduits, all the cables shall be tied together with nylon cable tie at every 300 mm interval while inserting the cables through conduit. The conduits laid on wall or structure shall be clamped with GI clamps at every 1000 mm. Further structural supporting arrangement wherever required shall be provided. Conduits shall be sealed with sealing compound at both ends.
- Cable drums shall be rolled only in the direction indicated on the side of the drum. The drum shall be braked to avoid overrunning. At no time shall a cable be handled in such a way that it takes up a radius less than its permissible installation bending radius.
- Unless otherwise permitted by the cable manufacturer and approved, minimum allowable bending radii shall comply with the following:
 - Wire armoured cables, 15 times the cable outside diameter.
 - Unarmoured thermoplastic insulated cables, 12 times the cable outside diameter.
- Cables shall not be pulled using the conductors. Maximum stresses stated by the cable manufacturer shall not be exceeded when laying or pulling any cables.
- Cables installed in cable ladders shall be:
 - Protected from mechanical damage or abrasion at entry or exit points.
 - Secured to ladder or tray using UV resistant heavy duty nylon cable ties at least every 1500 mm on horizontal runs and 900 mm on vertical runs.

Plant 1.0 MTPA ALUMINA REFINERY STREAM-5	Client NALCO	Contract Code NAL	Document ID 6695-ELT-G00-EC-0027	Contract No. 66-6695
 thyssenkrupp	ELECTRICAL INSTALLATION PART- I - INSTALLATION DETAIL-POWER			 नेशनल एल्यूमिनियम कंपनी लिमिटेड National Aluminium Company Ltd.
				Rev 0 Page 4 of 8

- vii. Single cables running outside cable ladders shall follow structural steel and be supported every 300 mm. Where necessary, additional brackets shall be installed to support cable drops to equipment.
- viii. Cables supported from catenary wires shall be secured using cable ties at intervals of not more than 1 m.
- ix. Where single core cables are used for three phase circuits, they shall be arranged in trefoil formation and clamped with non-magnetic cable clamps, or other approved type. Clamps shall be located at the following locations:
 - As close as possible to each cable termination.
 - At the start and finish of each bend.
 - At the midpoint of bends greater than 400 mm radius.
- x. Cables with an outside diameter up to 20 mm entering equipment such as motors, control stations and instruments shall have a looped coil prior to entering the equipment to relieve stress, allow future adjustment, and prevent water ingress.
- xi. Unless approved by Owner/Consultant, jointing of main supply cables shall not be permitted. Joints in lighting and power final sub-circuits are not permitted, except for looping purposes.



b. Cable Ducts

- i. Underground cable ducts shall be heavy duty rigid PVC conduit, or PVC pipe. Each duct system shall be complete with manholes and pull pits as necessary to facilitate installation and possible future replacement of cables.
- ii. The underground duct requirements shall be ascertained at an early stage and coordinated with the civil construction work. Where ducts run beneath roads or through foundations, at least 50% spare duct capacity shall be provided above the immediate requirements. Separate duct systems shall be provided for HV/LV power cables and communications cables.
- iii. At least one spare PVC covered draw wire shall be provided in each duct on completion of all cable laying/pulling. Ducts greater than or equal to 100 mm nominal diameter shall be provided with two spare draw wires.
- iv. Electrical services ducts carrying unarmoured cables, or armoured cables not installed on ladders, shall be saddled to masonry, concrete or steelworks via cable clamps to fixed supports at not more than 1 metre spacings. Supports shall be provided with 25% extra width to accommodate future cables.

c. Cable laying below ground:

- i. Cables laid underground through Hume pipes/ GI pipes shall have a clearance of 300 mm with utility lines, pipe lines, storm water drains to avoid interference. Hume pipes/ GI pipes shall be closed at both ends by sealing compound.
- ii. Cables laid in trenches without cable trays shall be laid in layers separated by sand and trenches shall be filled with sand if indicated in layout drawings. The trenches shall then be covered as per details shown in layout drawings.
- iii. Cables emerging from trenches for termination on equipment shall be protected by local GI pipes up to a height of 300 mm above the finished floor/ pavement level. Pipes shall be fixed on the trench wall and shall be sealed with compound.
- iv. Trenches shall be of adequate depth to provide the following minimum cover over any direct buried cable or underground duct:

Application	Minimum cover
Bare or PVC-covered earth cables	600 mm
Cables with active conductors	750 mm

Plant 1.0 MTPA ALUMINA REFINERY STREAM-5	Client NALCO	Contract Code NAL	Document ID 6695-ELT-G00-EC-0027	Contract No. 66-6695		
 thyssenkrupp	ELECTRICAL INSTALLATION PART- I - INSTALLATION DETAIL-POWER			नालको  NALCO नेशनल एल्युमिनियम कम्पनी लिमिटेड National Aluminium Company Ltd.		
				Rev	0	Page

Cables below roads and rail crossings	1000 mm
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- v. Direct buried cables (except bare earth conductors) shall be packed with screened fine sand, free from stone or chemically active material, to a finished thickness of at least 75 mm of packing on all sides. Mechanical protection covers with minimum width 150 mm shall be provided on top of the packing along the full length of direct buried cables. Trenches shall be backfilled and compacted in 300 mm thick layers, and formed to a crowned surface.
- vi. An orange PVC marker tape, marked "Danger Electrical Cables" or equivalent, with a minimum width of 150 mm shall be laid continuously along the route of the cables at a depth of 300 mm below ground level. The marker tape may be incorporated with the cable protection cover.
- vii. Cables leaving the ground shall be protected by galvanised steel water pipe or rigid PVC conduit of adequate diameter secured in position, extending from 400 mm below ground level to a minimum height of 100 mm. PVC conduit used for this purpose shall be treated for exposure to direct sunlight or be painted with a water-based acrylic paint and also shall be sealed with compound.

d. Clamping :

- i. Single core power cables for 3 phase supply laid on cable trays or on ground shall be clamped in trefoil formation, using pressure cast aluminium trefoil clamps at every 1000 mm interval. Additional clamps shall be used wherever cables change their direction of run.
- ii. Multicore cables laid on cable trays shall be tied individually with nylon tie at each rung or by 25 x 3 mm aluminium clamps at every 1000 mm interval on horizontal run and at every 600 mm interval on vertical run.

4. Cable Markers :

Above-ground cable route markers indicating the direction of buried cables shall be installed over the cables before and after road or railway crossings, at both ends and each change of direction and at 25 m intervals in between. Cable joint markers shall be installed over each buried joint. Cable markers shall be constructed of precast concrete slabs with corrosion-resistant metal (e.g. stainless steel) inserts recording the direction of the cable route or the position of cable joints.

5. Cable Tags :

Cables shall be tagged as detailed in the termination diagrams and cable schedules. Cable tags shall be proprietary non-metallic labels with numbers which are clear and indelible and fixed:

To each end of the cable.

Before and after points where its route cannot easily be followed, e.g., where a cable passes through walls and floors, under roads and pipelines.

At both ends of any straight through joint.

6. Sealing



All cables and cable ducts passing through walls and floors shall be sealed.

Sealing shall be suitable for:

- Filling of voids.
- Weatherproofing.
- Fire rating, (as required).
- Preventing migration of hazardous gas to non-hazardous areas. (where applicable)

7. Cable Core Identification and Looming

Core number ferrules as detailed on the drawings shall be fitted to each end of all cores of control and instrumentation cables. Adhesive and 'C' type ferrules are not acceptable. Where core

Plant 1.0 MTPA ALUMINA REFINERY STREAM-5	Client NALCO	Contract Code NAL	Document ID 6695-ELT-G00-EC-0027	Contract No. 66-6695		
 thyssenkrupp	ELECTRICAL INSTALLATION PART- I - INSTALLATION DETAIL-POWER			नालको  NALCO नेशनल एल्युमिनियम कम्पनी लिमिटेड National Aluminium Company Ltd.		
				Rev	0	Page

diameters are too small for the ferrule, a tight sleeve shall be installed between the core and the ferrule.

Cores of each cable shall be neatly loomed together using lacing or nylon cable ties. Cores of different cables shall not be loomed together.

8. Cable Termination

Competent and experienced cable jointers shall be employed for carrying out cable termination work with a high standard of workmanship. Connection of cables and cable termination shall be carried out in accordance with cable manufacturer's instructions or as directed by Engineer-In-Charge.



All HV cable joints shall be carried out in the presence of the Engineer-In-Charge or his authorized representative, unless this requirement is waived in writing.

a. Termination of Power & Control Cables

- i. Armoured cables shall be terminated with double compression type cable glands. Unarmoured cables shall be terminated by single compression type cable glands.
- ii. Cable glands shall be used on all cable terminations. Glands shall be selected for application as hazardous or non-hazardous.
- iii. Each cable gland shall be effectively bonded to the local earth busbar.
Gland plates shall be:
 - a. Tapped where terminating armoured type cable glands for cables in or entering hazardous areas.
 - b. Separately earthed via an earth strip.
 - c. Non ferrous where glanding single core cables.
 - d. Have unused entries plugged.
- iv. When armoured cables are used, the armour shall be prepared in a manner suitable for the type of cable glands. Armour shall be securely clamped and bonded to the body of the gland. Armour shall be properly cleaned and petroleum conducting jelly applied to the armour as well as clamping surfaces.
- v. When cable glands are fixed onto a sheet metal enclosure with a slip hole, a bonding/ earthing washer and a heavy check nut shall be used to ensure effective bonding of the cable gland with the enclosure. Paint shall be removed around the holes to ensure firm earth contact when the check nut is tightened.
- vi. Wherever gland plates are supplied undrilled, drilling and tapping (if required) of gland plates of equipment shall be carried out by the LSTK Contractor as part of cable termination work. In MCCs and Switchgear panels holes shall be drilled for spare feeders also. Further sufficient number of spare holes of required sizes shall be provided in all gland plates in consultation with Engineer-In-Charge. All unused holes shall be plugged properly in an approved manner as indicated by Engineer-In-Charge using metallic plug at top and bottom fastened by bolt and nut to make panel dust and vermin proof.

b. Prevention of Strain at Termination

- i. Special attention shall be given to ensure that the cable is adequately supported so that there is no strain on the termination or connection of conductors. Control cables entering control panel/ switchgear shall be bunched together and tied with nylon cords to keep them in position at the terminal block.
- ii. In case of small sized cables slight allowance shall be kept for the movement of motor without any strain on termination, particularly for belt coupled motors. Extra length of cables shall also be provided on trays for allowing re-terminations.
- iii. Cables terminated on equipment which is subject to vibrations shall be provided with strain relief clamps where the support for the cable is derived from the equipment. As far as possible the

Plant 1.0 MTPA ALUMINA REFINERY STREAM-5	Client NALCO	Contract Code NAL	Document ID 6695-ELT-G00-EC-0027	Contract No. 66-6695		
 thyssenkrupp	ELECTRICAL INSTALLATION PART- I - INSTALLATION DETAIL-POWER			नालको  NALCO नेशनल एल्युमिनियम कम्पनी लिमिटेड National Aluminium Company Ltd.		
				Rev	0	Page

support from the equipment shall be avoided and a separate independent support shall be provided.

c. HV End Termination

- HV cables of 11 & 6.6 kV grade and above shall be terminated with termination kits suitable for the voltage grade and type of application.
- Manufacturer's recommended procedure for termination of XLPE cable shall be adhered to. Termination shall be done by certified and experienced cable jointer familiar with the technique of termination of special cable termination kits.
- Armour shall be bonded to earth terminal provided inside the cable box using tinned copper braid.
- Cables shall be supported adequately at the entry to cable box/ equipment so that load of cable does not come on cable gland and terminals.
- Unless otherwise specified, all HV cables shall be terminated in air insulated cable boxes with glands using heat shrink termination kits. All HV terminations into terminal boxes shall be fully shrouded using heat shrink boots. Each phase conductor shall be fitted with a minimum of three weather sheds for protection against tracking.

d. Straight through Joints



- Jointing of cables shall be done with extreme care and manufacturer's instructions shall be strictly followed. Earth continuity wire shall be plumbed and/ or clamped. Compound should be filled according to the instructions of manufacturer of terminating kit/ cable. Joints made in trench or on racks shall be properly supported. Wherever joints are made in cables directly buried in the ground, brick masonry work shall be done around the joint box and filled with sand and thereafter covered with earth, at no extra cost.
- A tent should be used in all circumstances where jointing work is being done outdoor, for protection against rain and to prevent dust from being blown into exposed joint and jointing materials.
- Extreme care shall be taken to maintain proper phase sequence while terminating at equipment ends.
- Record of connection details shall be maintained.
- Conductor shall be shaped properly while terminating and no sharp bend shall be given. Where number of cables are connected in parallel, proper tests shall be carried out for identification before connecting so that no cross connection is made. No phase crossing shall be allowed for making the connection.
- All cables shall be meggered before and after termination and IR values recorded.

9. Equipment :


- LCS shall be mounted near the motor on the nearest column/ structure. In case free standing, location to be finalised at site to suit site condition.
- NGR enclosure shall be insulated from ground. Armour of cables shall not be connected to NGR enclosure.
- Junction boxes, Socket outlets & LCS shall be mounted at 1.2 meter elevation measured from finished floor level to the bottom of the equipment unless otherwise specified.

10. Miscellaneous :

- Cable tray covers shall be provided for outdoor ladder type cable trays exposed to sun in Slurry Area . Only top most cable tray shall be covered.
- Fabrication & painting of cable tray supports/ cable supports shall be done as described in Installation Specification.

Plant 1.0 MTPA ALUMINA REFINERY STREAM-5	Client NALCO	Contract Code NAL	Document ID 6695-ELT-G00-EC-0027	Contract No. 66-6695	
 thyssenkrupp	ELECTRICAL INSTALLATION PART- I - INSTALLATION DETAIL-POWER			 नालको नेशनल एल्युमिनियम कम्पनी लिमिटेड National Aluminium Company Ltd.	
				Rev	0

- c. For motors 45 kW & above, cables from main cable tray to individual consumer shall be routed through suitable size cable tray and for other motors cables shall be routed through steel channel used for LCS / main cable tray support.
- d. 'RTD/BTD' cable shall be routed through instrumentation 'IS/IF' cable tray. 'RTD/BTD' cables shall be tapped from instrumentation 'IS/IF' cable tray & routed through 50/100mm cable tray up to the respective motor.

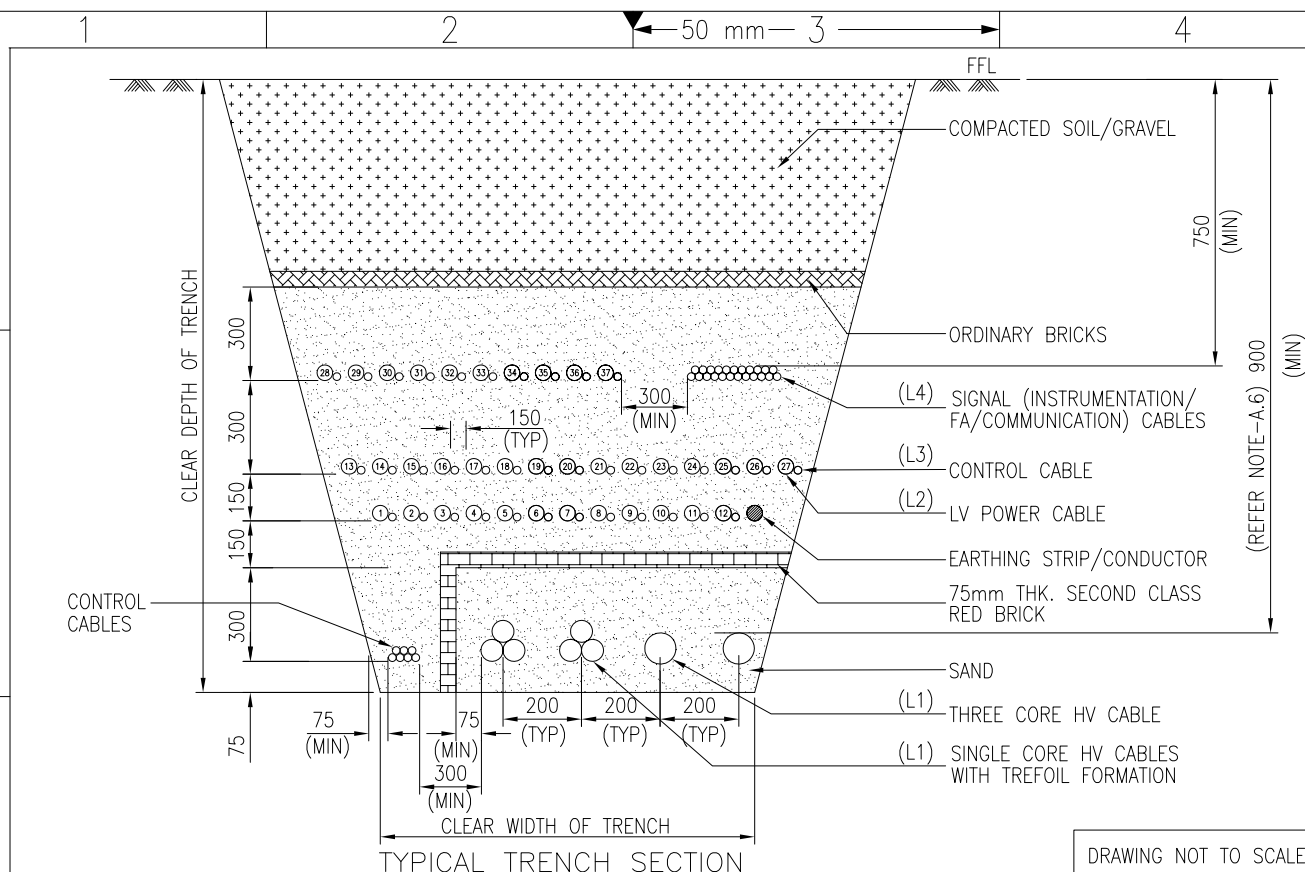

A) INSTALLATION NOTES:

- 1) ALL DIMENSIONS ARE IN MM UNLESS NOTED OTHERWISE.
- 2) RIVER SAND SHALL BE SIEVED & FREE FROM STONES.
- 3) APPROVAL SHALL BE OBTAINED FROM SITE ENGINEER BEFORE SAND FILLING AND PROCEEDING FOR SUBSEQUENT LAYER OF CABLES.
- 4) EARTHING CABLE/STRIP CAN BE INSTALLED IN ANY OF THE LAYER. LAYER WITH LV CABLES IS PREFERRED.
- 5) CERAMIC TILES/BRICKS SHALL BE OF APPROPRIATE VOLTAGE GRADE.
- 6) AS PER IS:1255, ALL HV CABLES >11KV SHALL BE INSTALLED AT A DEPTH OF 1050MM.

B) ENGINEERING NOTES:

- 1) HORIZONTAL SPACING SHOWN BETWEEN SIMILAR VOLTAGE GRADE CABLES (HV-HV, LV-LV) IS INDICATIVE ONLY. ACTUAL SPACING SHALL BE DECIDED DURING ENGINEERING CONSIDERING GROUPING OF CABLES, DE-RATING FACTOR ETC.
- 2) LAYER CONFIGURATIONS SHALL BE PROJECT SPECIFIC. E.G. LAYER 1 CAN BE HV CABLES WITH LV CABLES OR HV CABLES WITH ASSOCIATED CONTROL CABLES. HOWEVER, PARTITION METHOD & MINIMUM CLEARANCES SHALL BE MAINTAINED AS INDICATED.
- 3) IN CASE LAYER-2 IS ENVISAGED AS HT LAYER, CLEAR VERTICAL DISTANCE BETWEEN LAYER-1 & LAYER-2 SHALL BE MINIMUM 150MM. IN SUCH CASE, NOTE A.6 SHALL BE OBSERVED CONSIDERING LAYER-1.
- 4) THERMAL RESISTIVITY OF SAND SHALL BE OF KNOWN VALUE. RECOMMENDED VALUE SHALL BE CORRESPONDING TO DE-RATING FACTOR OF 1 OR HIGHER. SAME SHALL BE INFORMED TO CIVIL/ELECTRICAL CONTRACTOR DEPENDING ON SCOPE OF SUPPLY.

C) NOTES FOR CIVIL COORDINATION


- 1) CLEAR DEPTH OF TRENCH SHALL BE DECIDED BASED ON NO. OF CABLE LAYERS, WATER TABLE, CABLE ROUTING LAYOUT, UNDERGROUND COORDINATION ETC.
- 2) SCOPE MATRIX SHALL BE FINALIZED WITH CIVIL (PROJECT SPECIFIC). SAMPLE IS INDICATED BELOW

ACTIVITY DESCRIPTION	BY
SUPPLY OF SAND, BRICKS/TILES	CI
EXCAVATION, INSTALLATION OF SAND, BRICKS/TILES & BACK FILLING	EL

SEQUENCE OF LAYERS

(L1) LAYER-1	HV CABLES LAYER & ASSOCIATED CONTROL CABLES
(L2) LAYER-2	LV CABLES 1ST LAYER
(L3) LAYER-3	LV CABLES 2ND LAYER
(L4) LAYER-4	SIGNAL CABLES (MULTI-LAYER) & LV CABLES 3RD LAYER WITH SPACING



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		NTS									
Date							Description				
Name							INSTALLATION STANDARDS - POWER				
Drawn							TYPICAL DETAILS FOR DIRECTLY				
Prepared							BURIED CABLES (PCLB1)				
Checked											
Approved											

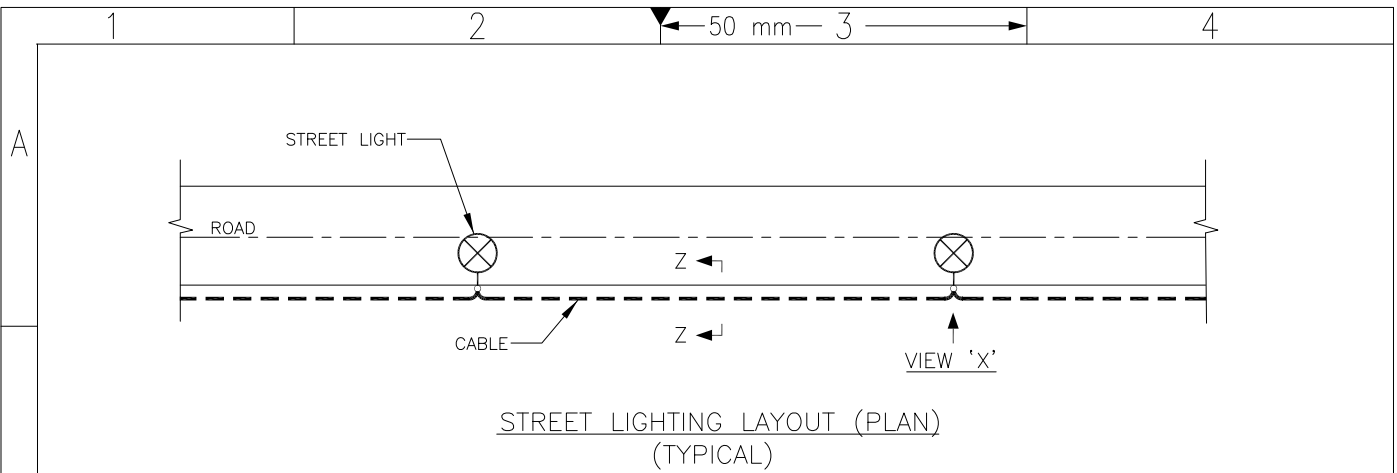

SCOPE MATRIX SHALL BE FINALIZED WITH CIVIL (PROJECT SPECIFIC).
SAMPLE IS INDICATED BELOW.

ACTIVITY DESCRIPTION	BY
SUPPLY OF SAND, BRICKS/TILES,	CI
INSTALLATION OF SAND, BRICKS/TILES AND CABLES	EL


**NOTE & TABLE TO
BE REFERRED &
REMOVED BEFORE
RELEASE OF THIS
DOCUMENT**

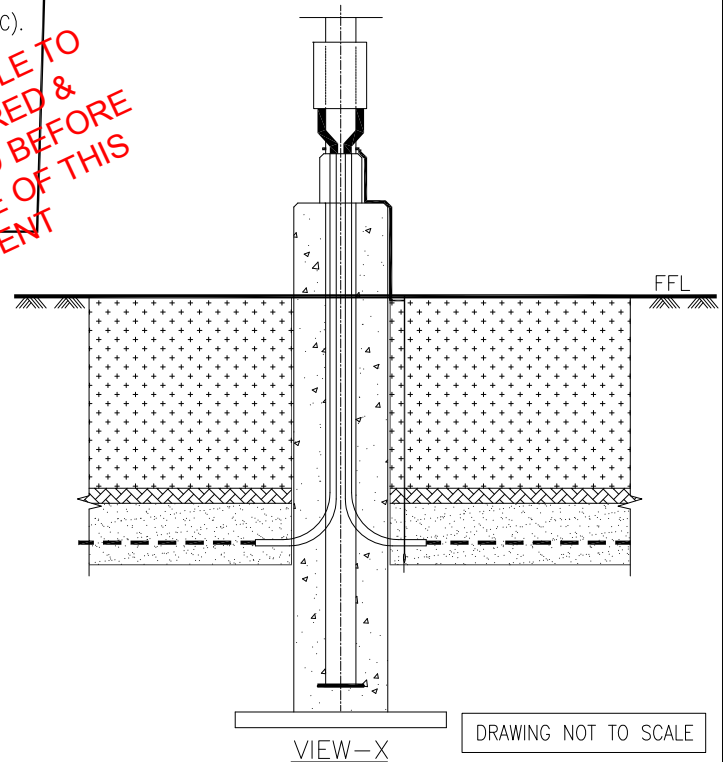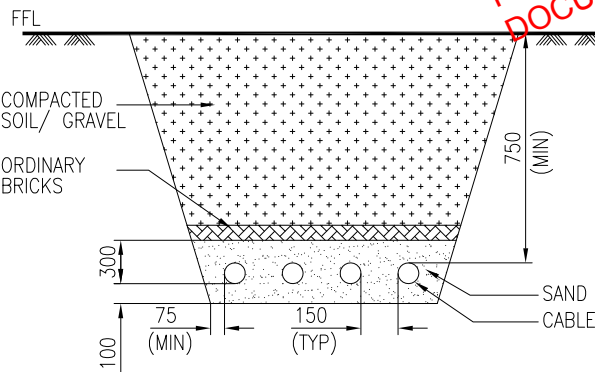

NOTES

- 1) ALL DIMENSIONS ARE IN MM UNLESS NOTED OTHERWISE.
- 2) RIVER SAND SHALL BE SIEVED & FREE FROM STONES.
- 3) APPROVAL SHALL BE OBTAINED FROM SITE ENGINEER BEFORE SAND FILLING AND PROCEEDING FOR BRICK INSTALLATION/BACKFILLING.
- 4) EARTHING CABLE/STRIP CAN BE LAID ALONG WITH STREET LIGHTING CABLES.
- 5) SPACING SHOWN IS INDICATIVE ONLY. ACTUAL SPACING SHALL BE DECIDED DURING ENGINEERING CONSIDERING NO. OF CABLES, DE-RATING FACTOR ETC.

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Date							Description				
19.07.2017 KRP							INSTALLATION STANDARDS – POWER				
19.07.2017 MLD							TYPICAL DETAILS FOR DIRECTLY BURIED				
19.07.2017 RPM							CABLES (STREET LIGHTING)				
19.07.2017 RPM							(PCLB2)				

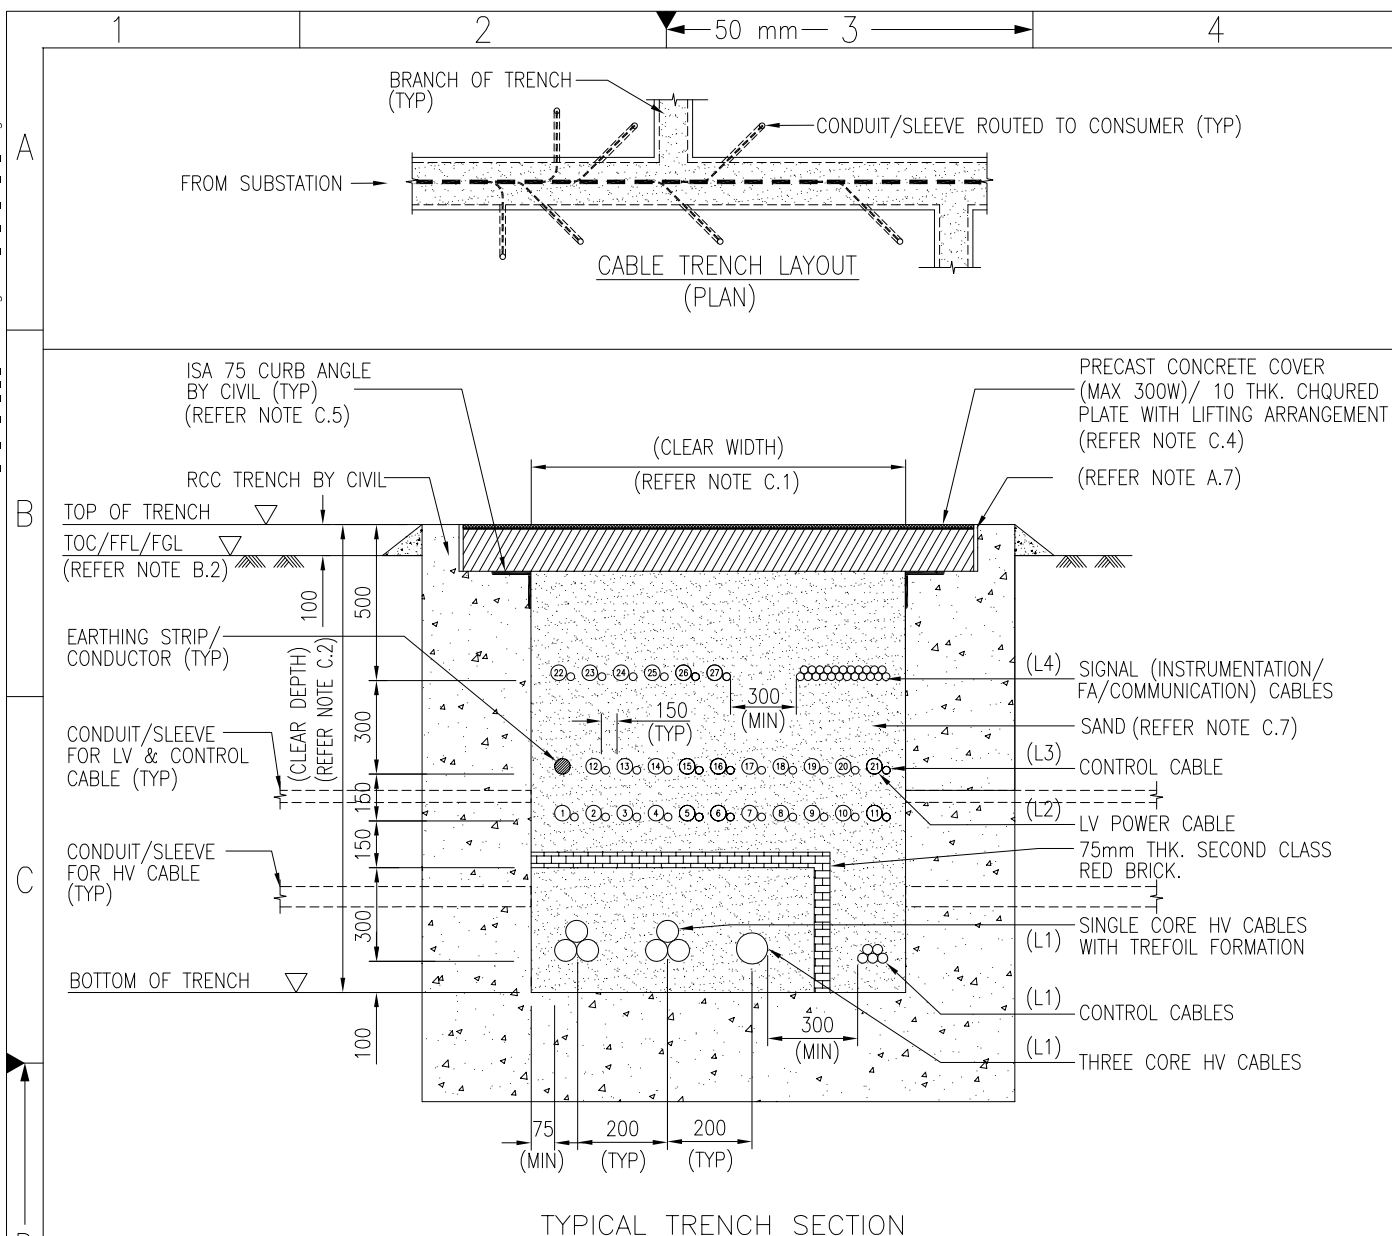


TYPICAL TRENCH SECTION

SEQUENCE OF LAYERS	
(L1) LAYER-1	HV CABLES LAYER & ASSOCIATED CONTROL CABLES
(L2) LAYER-2	LV CABLES 1ST LAYER
(L3) LAYER-3	LV CABLES 2ND LAYER
(L4) LAYER-4	SIGNAL CABLES (MULTI-LAYER) & LV CABLES 3RD LAYER WITH SPACING

DRAWING NOT TO SCALE

FOR RELEVANT NOTES, REFER SHEET 2 OF 2.

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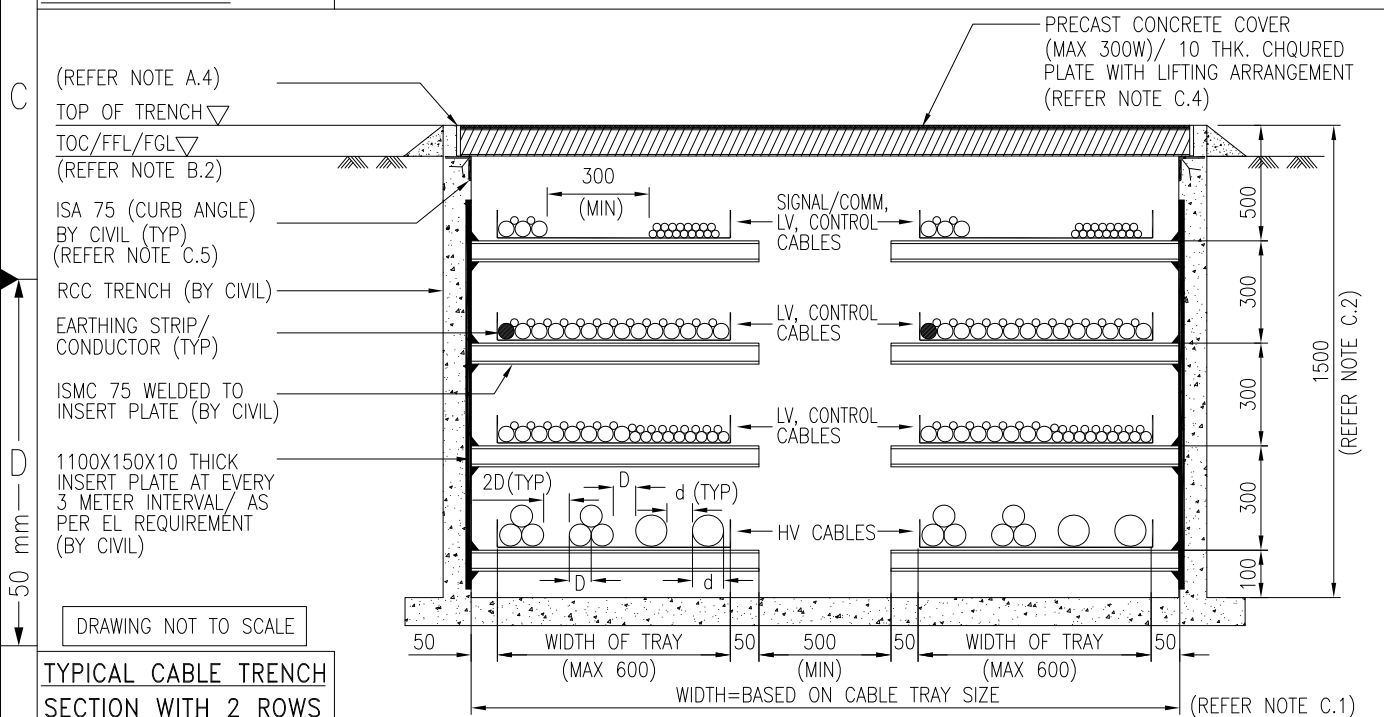
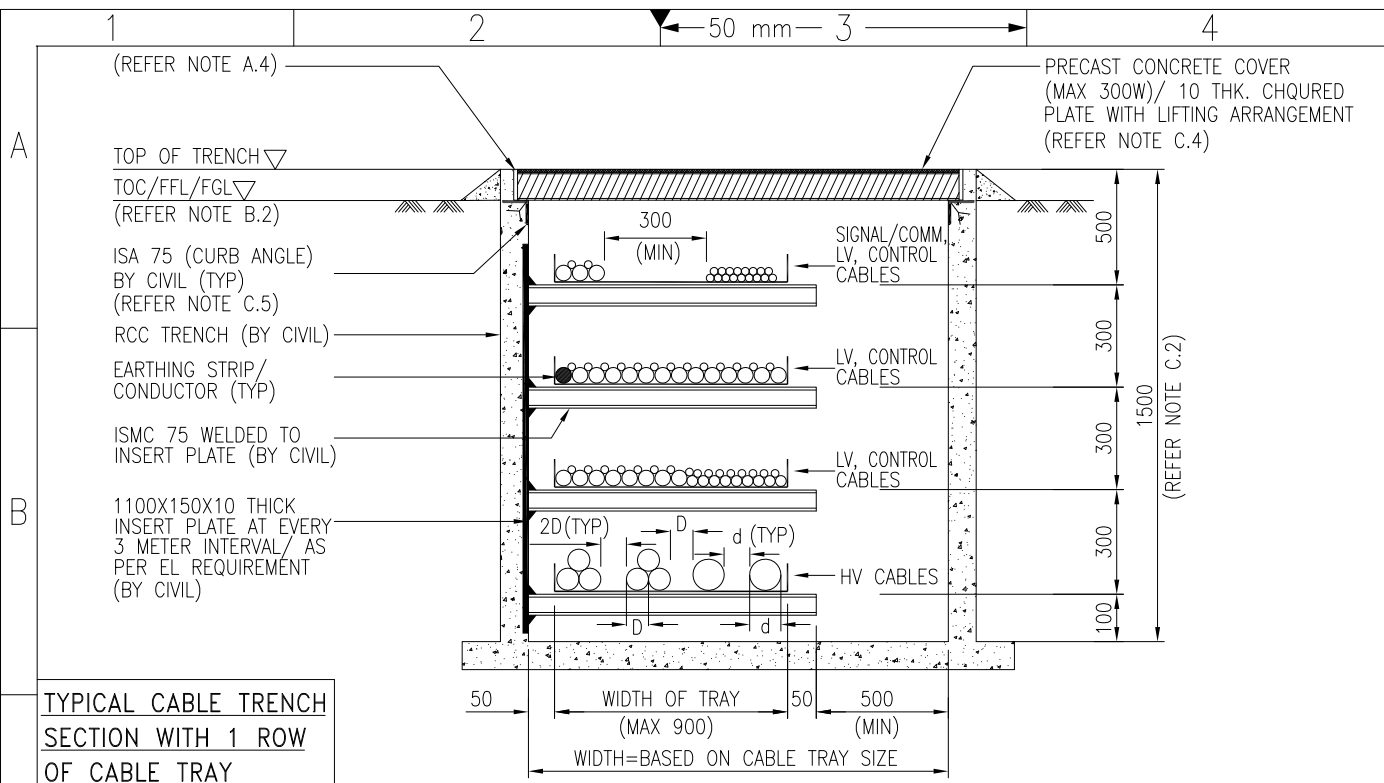
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	Date	Name	Description INSTALLATION STANDARDS – POWER TYPICAL DETAILS FOR CABLES LAID IN SAND FILLED BUILT-UP TRENCHES (PCLT1)
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Prepared	19.07.2017	MLD	
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A	<p>A) INSTALLATION NOTES:</p> <ol style="list-style-type: none"> 1) ALL DIMENSIONS ARE IN MM UNLESS NOTED OTHERWISE. 2) RIVER SAND SHALL BE SIEVED & FREE FROM STONES. 3) APPROVAL SHALL BE OBTAINED FROM SITE ENGINEER BEFORE SAND FILLING AND PROCEEDING FOR SUBSEQUENT LAYER OF CABLES. 4) EARTHING CABLE/STRIP CAN BE INSTALLED IN ANY OF THE LAYER. LAYER WITH LV CABLES IS PREFERRED. 5) CERAMIC TILES/BRICKS SHALL BE OF APPROPRIATE VOLTAGE GRADE. 6) ALL THE TRENCH OPENINGS/PIPE SLEEVES SHALL BE EFFECTIVELY SEALED AFTER CABLE LAYING IN ORDER TO AVOID INGRESS OF WATER. 7) THE REMOVABLE CONCRETE COVERS SHALL BE SEALED WITH MASTIC ASPHALT FILLER/BITUMEN TO PREVENT INGRESS OF WATER/HYDROCARBONS IN CABLE TRENCH. 																										
	<p>B) ENGINEERING NOTES:</p> <ol style="list-style-type: none"> 1) HORIZONTAL SPACING SHOWN BETWEEN SIMILAR VOLTAGE GRADE CABLES (HV–HV, LV–LV) IS INDICATIVE ONLY. ACTUAL SPACING SHALL BE DECIDED DURING ENGINEERING CONSIDERING GROUPING OF CABLES, DE-RATING FACTOR ETC. 2) TOP OF TRENCH SHALL BE 100mm ABOVE FINISHED GRADE LEVEL (FGL) IN CASE OF UNPAVED AREAS AND SHALL BE FLUSHED WITH FINISHED FLOOR LEVEL/TOP OF CONCRETE (FFL/TOC) IN CASE OF PAVED AREAS. 																										
B	<p>C) NOTES FOR CIVIL COORDINATION</p> <ol style="list-style-type: none"> 1) GENERALLY, CLEAR WIDTH OF TRENCH SHALL BE RESTRICTED TO 1500MM. FOR WIDER/LARGE WIDTHS, MULTIPLE TRENCHES WITH RCC PARTITIONS SHALL BE DESIGNED. 2) CLEAR DEPTH OF TRENCH SHALL BE DECIDED BASED ON NO. OF CABLE LAYERS, WATER TABLE, CABLE ROUTING LAYOUT, UNDERGROUND COORDINATION ETC. ALSO, CIVIL SHALL BE CONSULTED BEFORE FINALIZATION OF TRENCH (CLEAR) DIMENSIONS. 3) SCOPE MATRIX SHALL BE FINALIZED WITH CIVIL (PROJECT SPECIFIC). SAMPLE IS INDICATED BELOW. 																										
C	<table border="1" style="width: 100%; border-collapse: collapse;"> <thead> <tr> <th style="width: 80%;">ACTIVITY DESCRIPTION</th> <th style="width: 20%;">BY</th> </tr> </thead> <tbody> <tr> <td>CLEAR DEPTH & WIDTH OF TRENCH</td> <td>EL</td> </tr> <tr> <td>TRENCH DESIGN</td> <td>CI</td> </tr> <tr> <td>SUPPLY OF SAND, BRICKS/TILES, PRECAST CONCRETE COVERS, CHEQUERED PLATES WITH LIFTING ARRANGEMENT, SLEEVES, SEALING MATERIAL REQUIRED AT SLEEVE OPENINGS, TRENCH COVERS ETC.</td> <td>CI</td> </tr> <tr> <td>INSTALLATION OF SAND, BRICKS/TILES AND CABLES</td> <td>EL</td> </tr> <tr> <td>INSTALLATION OF PRECAST CONCRETE COVERS AND CHEQUERED PLATES, SLEEVES, SEALING MATERIAL REQUIRED AT SLEEVE OPENINGS, TRENCH COVERS ETC.</td> <td>CI</td> </tr> </tbody> </table>			ACTIVITY DESCRIPTION	BY	CLEAR DEPTH & WIDTH OF TRENCH	EL	TRENCH DESIGN	CI	SUPPLY OF SAND, BRICKS/TILES, PRECAST CONCRETE COVERS, CHEQUERED PLATES WITH LIFTING ARRANGEMENT, SLEEVES, SEALING MATERIAL REQUIRED AT SLEEVE OPENINGS, TRENCH COVERS ETC.	CI	INSTALLATION OF SAND, BRICKS/TILES AND CABLES	EL	INSTALLATION OF PRECAST CONCRETE COVERS AND CHEQUERED PLATES, SLEEVES, SEALING MATERIAL REQUIRED AT SLEEVE OPENINGS, TRENCH COVERS ETC.	CI												
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<ol style="list-style-type: none"> 4) IN CERTAIN AREAS (E.G. SUBSTATION), 10mm THICK CHEQUERED PLATES (BY CIVIL) WITH LIFTING ARRANGEMENT CAN BE USED. IT SHALL BE DECIDED DURING ENGINEERING CONSIDERING LOCATION OF TRENCH, VEHICLE MOVEMENT ETC. 5) CURB ANGLE SHALL BE PROVIDED BY CIVIL ALONG THE LENGTH OF TRENCH. IT IS REQUIRED WHEREVER INSTALLATION OF CHEQUERED PLATES (AS COVER) IS ENVISAGED. 6) DUE CONSIDERATION SHALL BE GIVEN TO VEHICLE/FORK LIFT MOVEMENT WHILE DECIDING TRENCH LOCATION. CIVIL SHALL DESIGN THE TRENCH, TRENCH COVER ACCORDINGLY. 7) THERMAL RESISTIVITY OF SAND SHALL BE OF KNOWN VALUE. RECOMMENDED VALUE SHALL BE CORRESPONDING TO DE-RATING FACTOR OF 1 OR HIGHER. SAME SHALL BE INFORMED TO CIVIL/EL CONTRACTOR DEPENDING ON SCOPE OF SUPPLY. 																											
<p style="color: red; font-size: 24pt; transform: rotate(-15deg); opacity: 0.5;">NOTE B) & C) TO BE REFERRED & REMOVED BEFORE RELEASE OF THIS DOCUMENT. ALSO REFERENCE OF NOTES B) & C) TO BE REMOVED FROM SHEET 1 OF 2</p>																											
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<table border="1" style="width: 100%; border-collapse: collapse;"> <tr> <td style="width: 10%;">Date</td> <td style="width: 10%;">Name</td> <td style="width: 80%;">Description</td> </tr> <tr> <td>Drawn</td> <td>19.07.2017 KRP</td> <td rowspan="4">INSTALLATION STANDARDS – POWER TYPICAL DETAILS FOR CABLES LAID IN SAND FILLED BUILT-UP TRENCHES (PCLT1)</td> </tr> <tr> <td>Prepared</td> <td>19.07.2017 MLD</td> </tr> <tr> <td>Checked</td> <td>19.07.2017 RPM</td> </tr> <tr> <td>Approved</td> <td>19.07.2017 RPM</td> </tr> </table>			Date	Name	Description	Drawn	19.07.2017 KRP	INSTALLATION STANDARDS – POWER TYPICAL DETAILS FOR CABLES LAID IN SAND FILLED BUILT-UP TRENCHES (PCLT1)	Prepared	19.07.2017 MLD	Checked	19.07.2017 RPM	Approved	19.07.2017 RPM													
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FOR RELEVANT NOTES & PLAN VIEW, REFER SHEET 2 OF 2.

Code		Contract No.		Document ID				Part		Rev.	
00		19.07.2017		KRP		MLD		19.07.2017		RPM	
Rev.		Date		Name		Date		Name		Date	
19.07.2017		19.07.2017		19.07.2017		19.07.2017		19.07.2017		19.07.2017	
KRP		MLD		RPM		RPM		RPM		RPM	
Drawn/Prepared		Checked		Approved		Description		Acc. Code		Status	
19.07.2017		19.07.2017		19.07.2017		19.07.2017		19.07.2017		19.07.2017	
KRP		MLD		RPM		RPM		RPM		RPM	
19.07.2017		19.07.2017		19.07.2017		19.07.2017		19.07.2017		19.07.2017	
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19.07.2017		19.07.2017		19.07.2017		19.07.2017		19.07.2017		19.07.2017	
KRP		MLD		RPM		RPM		RPM		RPM	
19.07.2017		19.07.2017		19.07.2017		19.07.2017		19.07.2017		19.07.2017	
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KRP		MLD		RPM		RPM		RPM		RPM	
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KRP		MLD		RPM		RPM		RPM		RPM	
19.07.2017		19.07.2017		19.07.2017		19.07.2017		19.07.2017		19.07.2017	
KRP		MLD		RPM		RPM		RPM		RPM	
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KRP		MLD		RPM		RPM		RPM		RPM	
19.07.2017		19.07.2017		19.07.2017		19.07.2017		19.07.2017		19.07.2017	
KRP		MLD		RPM		RPM		RPM		RPM	
19.07.2017		19.07.2017		19.07.2017		19.07.2017		19.07.2017		19.07.2017	
KRP		MLD		RPM		RPM		RPM		RPM	
19.07.2017		19.07.2017		19.07.2017		19.07.2017		19.07.2017		19.07.2017	
KRP		MLD		RPM		RPM		RPM		RPM	
19.07.2017		19.07.2017		19.07.2017		19.07.2017		19.07.2017		19.07.2017	
KRP		MLD		RPM		RPM		RPM		RPM	
19.07.2017		19.07.2017		19.07.2017		19.07.2017		19.07.2017		19.07.2017	
KRP		MLD		RPM		RPM		RPM		RPM	
19.07.2017		19.07.2017		19.07.2017		19.07.2017		19.07.2017		19.07.2017	
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KRP		MLD		RPM		RPM		RPM		RPM	
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KRP		MLD		RPM		RPM		RPM		RPM	
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KRP		MLD		RPM		RPM		RPM		RPM	
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KRP		MLD		RPM		RPM		RPM		RPM	
19.07.2017		19.07.2017									

1	2	3	4
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BRANCH OF TRENCH (TYP)

FROM SUBSTATION →

CABLE TRENCH LAYOUT (PLAN)

FOR SECTIONAL VIEWS, REFER SHEET 1 OF 2.

A) INSTALLATION NOTES:

- 1) ALL DIMENSIONS ARE IN MM UNLESS NOTED OTHERWISE.
- 2) EARTHING CABLE/STRIP CAN BE INSTALLED IN ANY OF THE CABLE TRAY. TIER WITH LV CABLES IS PREFERRED.
- 3) ALL THE TRENCH OPENINGS/PIPE SLEEVES SHALL BE EFFECTIVELY SEALED AFTER CABLE LAYING IN ORDER TO AVOID INGRESS OF WATER.
- 4) THE REMOVABLE CONCRETE COVERS SHALL BE SEALED WITH MASTIC ASPHALT FILLER/BITUMEN TO PREVENT INGRESS OF WATER/HYDROCARBONS IN CABLE TRENCH.

B) ENGINEERING NOTES:

- 1) HORIZONTAL SPACING SHOWN BETWEEN SIMILAR VOLTAGE GRADE CABLES (HV-HV, LV-LV) IS INDICATIVE ONLY. ACTUAL SPACING SHALL BE DECIDED DURING ENGINEERING CONSIDERING GROUPING OF CABLES, DE-RATING FACTOR ETC.
- 2) TOP OF TRENCH SHALL BE 100mm ABOVE FINISHED GRADE LEVEL (FGL) IN CASE OF UNPAVED AREAS AND SHALL BE FLUSHED WITH FINISHED FLOOR LEVEL/TOP OF CONCRETE (FFL/TOC) IN CASE OF PAVED AREAS.

C) NOTES FOR CIVIL COORDINATION

- 1) GENERALLY, CLEAR WIDTH OF TRENCH SHALL BE RESTRICTED TO 1500MM. FOR TWO ROWS OF CABLE TRAYS, CLEAR WIDTH SHALL BE RESTRICTED TO 2000MM. FOR WIDER/LARGE WIDTHS, MULTIPLE TRENCHES WITH RCC PARTITIONS SHALL BE DESIGNED.
- 2) CLEAR DEPTH OF TRENCH SHALL BE DECIDED BASED ON NO. OF CABLE LAYERS, WATER TABLE, CABLE ROUTING LAYOUT, UNDERGROUND COORDINATION ETC. ALSO, CIVIL SHALL BE CONSULTED BEFORE FINALIZATION OF TRENCH (CLEAR) DIMENSIONS.
- 3) SCOPE MATRIX SHALL BE FINALIZED WITH CIVIL (PROJECT SPECIFIC). SAMPLE IS INDICATED BELOW.

ACTIVITY DESCRIPTION	BY
CLEAR DEPTH & WIDTH OF TRENCH	EL
TRENCH DESIGN	CI
SUPPLY & INSTALLATION OF INSERT PLATES, TRAY SUPPORTS, PRECAST CONCRETE COVERS/ CHEQUERED PLATES, SLEEVES, SEALING MATERIAL REQUIRED AT SLEEVES OPENINGS, TRENCH COVERS ETC.	CI
INSTALLATION OF TRAYS, CABLES	EL

- 4) IN CERTAIN AREAS (E.G. SUBSTATION), 10mm THICK CHEQUERED PLATES (BY CIVIL) WITH LIFTING ARRANGEMENT CAN BE USED. IT SHALL BE DECIDED DURING ENGINEERING CONSIDERING LOCATION OF TRENCH, VEHICLE MOVEMENT ETC.
- 5) CURB ANGLE SHALL BE PROVIDED BY CIVIL ALONG THE LENGTH OF TRENCH. IT IS REQUIRED FOR FOLLOWING PURPOSES:
 - 1) WHEREVER INSTALLATION OF CHEQUERED PLATES (AS COVER) IS ENVISAGED.
 - 2) WHEREVER PANEL FRAME INSTALLATION IS ENVISAGED. IN THIS CASE, SIZE OF CURB ANGLE SHALL BE MODIFIED SUITABLY.
- 6) DUE CONSIDERATION SHALL BE GIVEN TO VEHICLE/FORK LIFT MOVEMENT WHILE DECIDING TRENCH LOCATION. CIVIL SHALL DESIGN THE TRENCH, TRENCH COVER ACCORDINGLY.

NOTE B) & C) TO BE REFERRED & REMOVED BEFORE RELEASE OF THIS DOCUMENT.

ALSO REFERENCE OF NOTES B) & C) TO BE REMOVED FROM SHEET 1 OF 2

Code	Contract No.	Document ID	Part	Rev.
00	19.07.2017	KRP	MLD	19.07.2017
Rev.	Date	Name	Date	Name
Drawn/Prepared	Checked	Approved		

Store Location: Server/Share

Store Location: Folder

Store Name: PCLT2

Pro. Unit: TON Group: Type of Document: Sheet: 2 / 2

Con. Unit: Scale: Order No.:

NTS

thyssenkrupp

Date	Name	Description
Drawn	19.07.2017 KRP	INSTALLATION STANDARDS – POWER TYPICAL DETAILS FOR CABLES LAID IN BUILT-UP TRENCHES WITH CABLE TRAY (PCLT2)
Prepared	19.07.2017 MLD	
Checked	19.07.2017 RPM	
Approved	19.07.2017 RPM	

1	2	3	4
ITEM	DESCRIPTION	MATERIAL	QTY.
1	80 x 80 x10 THK PLATE	CAST IRON	1 NO.
2	250 x 80 x10 THK PLATE	CAST IRON	1 NO.
3	ISA 75 (75X75X6mm)	CAST IRON	1 METER
4	HEXAGONAL HEAD BOLT M10 X 30mm LONG, THREADS UPTO HEAD, WITH SUITABLE NUTS & WASHERS (REFER NOTE-3)	H.D.G.I.	4 SETS
5	100 x 100 x 6 THK PLATE	CAST IRON	1 NO.
6	CONCRETE BLOCK	CONCRETE (GRADE M20)	AS REQUIRED

SIGN 'A'

SIGN 'B'

DRAWING NOT TO SCALE

NOTES

- ALL DIMENSIONS ARE IN 'mm' UNLESS OTHERWISE SPECIFIED.
- STEEL SECTIONS SHALL BE PREFABRICATED & PAINTED BEFORE INSTALLATION. AREA AFFECTED DUE TO SITE WELDING SHALL BE CLEANED AND PAINTED.
- THESE DETAILS SHALL BE VERIFIED WITH ORDERED EQUIPMENT DRAWING.
- LETTERING & SYMBOLS SHALL BE EMBOSSED ON THE PLATE. THE PLATE SHALL BE PAINTED YELLOW. THE LETTERS & SYMBOLS SHALL BE PAINTED IN RED. ALSO, 'X' (VOLTAGE GRADE OF THE CABLE) SHALL BE INDICATED APPROPRIATELY.
- CABLE MARKER SHALL BE PROVIDED EVERY 30 METERS (AS PER OISD-147)/ 200 METERS (AS PER IS-1255) AND AT POINTS OF TURNING, INTERSECTION & CABLE JOINT.

Code		Contract No.		Document ID		Part		Rev.	
				PIN-LEP-ELT-4001				00	
00	19.07.2017	KRP	MLD	19.07.2017	RPM	19.07.2017	RPM	ISSUED AS STANDARD	
Rev.	Date	Name		Date	Name	Date	Name	Description	Acc. Code
		Drawn/Prepared			Checked		Approved		

BAR-Code		Store Location: Server/Share	
		Store Location: Folder	
		Store Name PCMG1	
Pro. Unit	TON	Group	Type of Document
Con. Unit	Scale	Order No.	Sheet 1 / 1
NTS		thyssenkrupp	

Date	Name	Description
Drawn	19.07.2017 KRP	INSTALLATION STANDARDS – POWER CABLE MARKER (PCMG1)
Prepared	19.07.2017 MLD	
Checked	19.07.2017 RPM	
Approved	19.07.2017 RPM	

1200

FFL/TOG

BRICK/CONCRETE WALL

CONTROL CABLE

FRONT VIEW

VIEW-A

'DETAIL-1'

FFL/TOG


VIEW-A

DETAIL-1

CABLE ENTRY


DRAWING NOT TO SCALE

- 1) ALL DIMENSION ARE IN 'mm' UNLESS OTHERWISE STATED.
- 2) STEEL SECTIONS SHALL BE PREFABRICATED & PAINTED BEFORE INSTALLATION.
- 3) THESE DETAILS SHALL BE VERIFIED WITH ORDERED EQUIPMENT DRAWING.
- 4) SUPPLY & INSTALLATION OF STEEL IS NOT PART OF THIS INSTALLATION ARRANGEMENT. SAME IS COVERED ELSEWHERE.
- 5) CANOPY COVERED FROM 3 SIDES SHALL BE PROVIDED FOR LOCAL CONTROL STATION INSTALLED OUTDOOR.

BAR-Code	Store Location: Server/Share			
	Store Location: Folder			
	Store Name pcsc1			
	Pro. Unit	TON	Group	Type of Document
				Sheet 1 / 1
	Con. Unit	Scale	Order No.	 thyssenkrupp
		NTS		

	Date	Name	Description
Drawn	19.07.2017	KRP	INSTALLATION STANDARDS – POWER
Prepared	19.07.2017	MLD	LOCAL CONTROL STATION ON
Checked	19.07.2017	RPM	BRICK/CONCRETE WALL
Approved	19.07.2017	RPM	(PCSC1)

1		2		3		4	
ITEM	DESCRIPTION		MATERIAL	QTY.	SUPPLY BY	INSTALLATION BY	
A	1	LOCAL CONTROL STATION	PROJ. SPEC.	1 NO.	CLIENT	ELECTRICAL CONTRACTOR	
	2	ISMC 100	M.S. PAINTED	AS REQUIRED	REFER NOTE-4		
	3	150 x 150 x10 THK PLATE	M.S. PAINTED	1 NO.	REFER NOTE-4		
	4	25 x 3mm THK. FLAT	M.S. PAINTED	1 METER	REFER NOTE-3 & 4		
	5	HEXAGONAL HEAD BOLT M10 X 30mm LONG, THREADS UPTO HEAD, WITH SUITABLE NUTS & WASHERS (REFER NOTE-3)	H.D.G.I.	4 SETS	ELECTRICAL CONTRACTOR	ELECTRICAL CONTRACTOR	
B	6	ANCHOR FASTENER M10 x 75 LONG WITH SUITABLE NUT & WASHER	GALVANISED STEEL / SS	4 NOS.	ELECTRICAL CONTRACTOR	ELECTRICAL CONTRACTOR	
	7	CABLE TIE	PLASTIC	AS REQUIRED	ELECTRICAL CONTRACTOR	ELECTRICAL CONTRACTOR	
	8	EDGE PROTECTION FOR CABLE	RUBBER	1 NO.	ELECTRICAL CONTRACTOR	ELECTRICAL CONTRACTOR	
	9	200x200x100 (LxWxH)mm PEDESTAL	CONCRETE (GRADE M20)	AS REQUIRED	ELECTRICAL CONTRACTOR	ELECTRICAL CONTRACTOR	
	10	CANOPY COVERED FROM 3 SIDES (REFER NOTE-5)	PROJ. SPEC.	1 NO.	ELECTRICAL CONTRACTOR	ELECTRICAL CONTRACTOR	
	11	HEXAGONAL HEAD BOLT M6 X 25mm LONG, THREADS UPTO HEAD, WITH SUITABLE NUTS & WASHERS (FOR CANOPY FIXING)	H.D.G.I.	4 SETS	ELECTRICAL CONTRACTOR	ELECTRICAL CONTRACTOR	

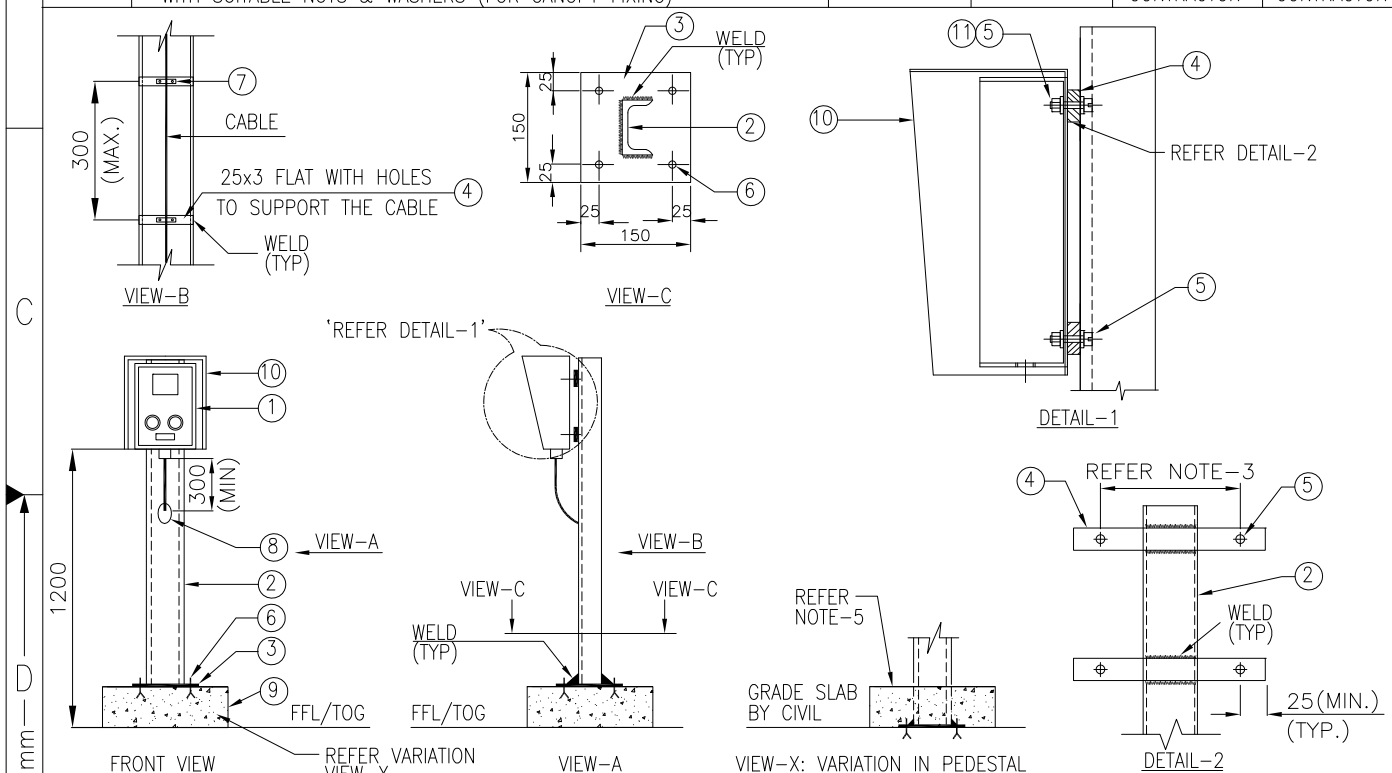

NOTES


- 1) ALL DIMENSION ARE IN 'mm' UNLESS OTHERWISE STATED.
- 2) STEEL SECTIONS SHALL BE PREFABRICATED & PAINTED BEFORE INSTALLATION. AREA AFFECTED DUE TO SITE WELDING SHALL BE CLEANED AND PAINTED.
- 3) THESE DETAILS SHALL BE VERIFIED WITH ORDERED EQUIPMENT DRAWING.
- 4) SUPPLY & INSTALLATION OF STEEL IS NOT PART OF THIS INSTALLATION ARRANGEMENT. SAME IS COVERED ELSEWHERE.
- 5) CANOPY COVERED FROM 3 SIDES SHALL BE PROVIDED FOR LOCAL CONTROL STATION INSTALLED OUTDOOR.
- 6) IN CASE OF ACID PROOF/BRICK LINING AREA, SUCH ARRANGEMENT SHALL BE FOLLOWED BY EL CONTRACTOR BEFORE START OF LINING WORK

DRAWING NOT TO SCALE


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ISO A4

Code			Contract No.			Document ID			PIN-LEP-ELT-4001			Part	Rev.
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Rev.	Date	Name		Date	Name		Date	Name		Description		Acc. Code	
BAR-Code								Store Location: Server/Share					
								Store Location: Folder					
								Store Name PCSP1					
Pro. Unit		TON			Group		Type of Document		Sheet		1 / 1		
Con. Unit		Scale		Order No.		 thyssenkrupp							
		NTS											
	Date	Name						Description					
Drawn	19.07.2017	KRP						INSTALLATION STANDARDS – POWER					
Prepared	19.07.2017	MLD						LOCAL CONTROL STATION ON					
Checked	19.07.2017	RPM						SELF-STANDING PEDESTAL					
Approved	19.07.2017	RPM						(PCSP1)					

1		2		50 mm		3		4	
A	ITEM	DESCRIPTION		MATERIAL	QTY.	SUPPLY BY	INSTALLATION BY		
	1	LOCAL CONTROL STATION		PROJ. SPEC.	1 NO.	CLIENT	ELECTRICAL CONTRACTOR		
	2	ISMC 100		M.S. PAINTED	AS REQUIRED	REFER NOTE-4			
	3	150 x 150 x10 THK PLATE		M.S. PAINTED	1 NO.	REFER NOTE-4			
	4	25 x 3mm THK. FLAT		M.S. PAINTED	1 METER	REFER NOTE-3 & 4			
	5	HEXAGONAL HEAD BOLT M10 X 30mm LONG, THREADS UPTO HEAD, WITH SUITABLE NUTS & WASHERS (REFER NOTE-3)		H.D.G.I.	4 SETS	ELECTRICAL CONTRACTOR	ELECTRICAL CONTRACTOR		
	6	CABLE TIE		PLASTIC	AS REQUIRED	ELECTRICAL CONTRACTOR	ELECTRICAL CONTRACTOR		
	7	EDGE PROTECTION FOR CABLE		RUBBER	1 NO.	ELECTRICAL CONTRACTOR	ELECTRICAL CONTRACTOR		
	8	CANOPY COVERED FROM 3 SIDES (REFER NOTE-5)		PROJ. SPEC.	1 NO.	ELECTRICAL CONTRACTOR	ELECTRICAL CONTRACTOR		
9	HEXAGONAL HEAD BOLT M6 X 25mm LONG, THREADS UPTO HEAD, WITH SUITABLE NUTS & WASHERS (FOR CANOPY FIXING)		H.D.G.I.	4 SETS	ELECTRICAL CONTRACTOR	ELECTRICAL CONTRACTOR			



NOTES

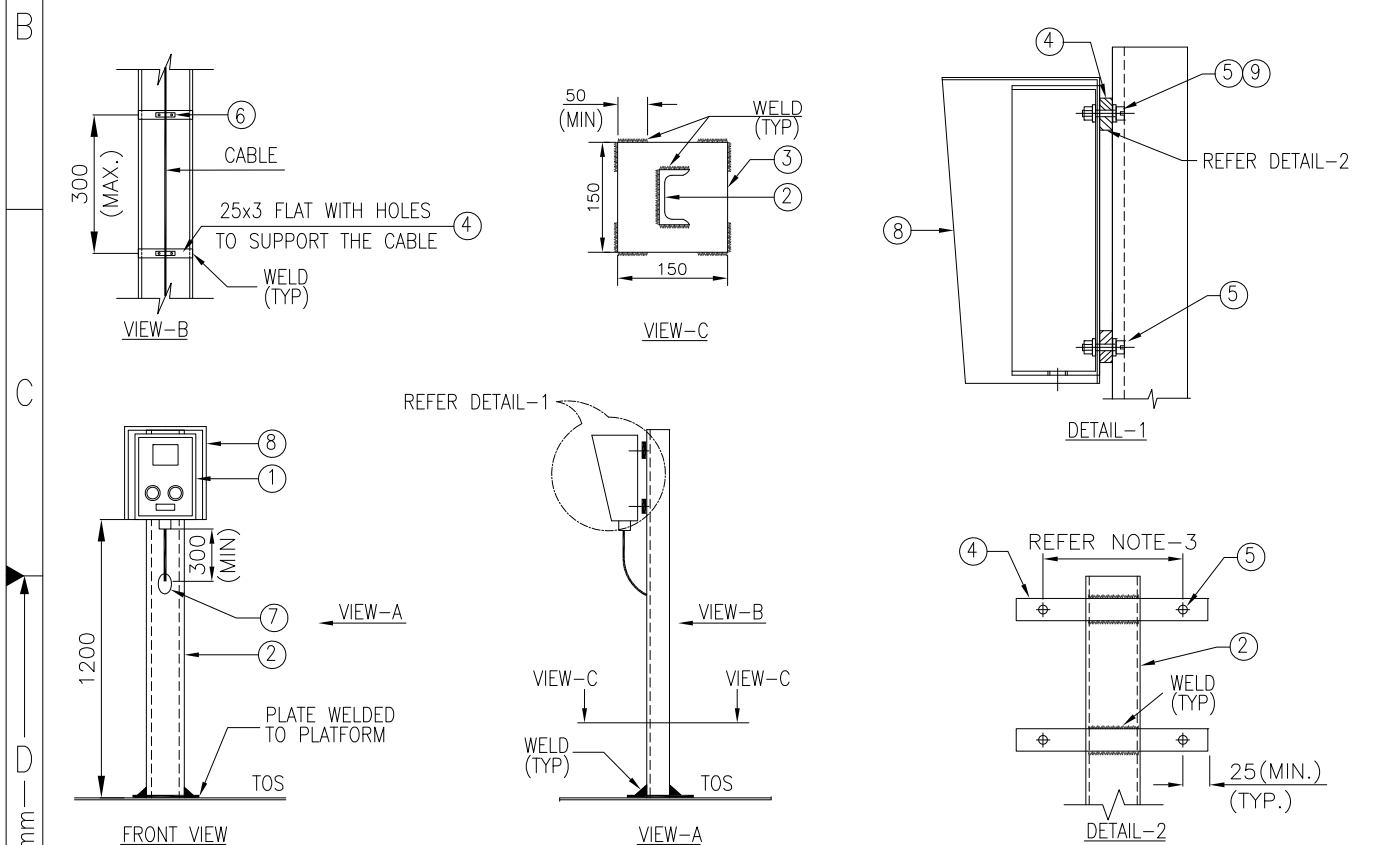- ALL DIMENSION ARE IN 'mm' UNLESS OTHERWISE STATED.
- STEEL SECTIONS SHALL BE PREFABRICATED & PAINTED BEFORE INSTALLATION. AREA AFFECTED DUE TO SITE WELDING SHALL BE CLEANED AND PAINTED.
- THESE DETAILS SHALL BE VERIFIED WITH ORDERED EQUIPMENT DRAWING.
- SUPPLY & INSTALLATION OF STEEL IS NOT PART OF THIS INSTALLATION ARRANGEMENT. SAME IS COVERED ELSEWHERE.
- CANOPY COVERED FROM 3 SIDES SHALL BE PROVIDED FOR LOCAL CONTROL STATION INSTALLED OUTDOOR.

DRAWING NOT TO SCALE

Code		Contract No.		Document ID		PIN-LEP-ELT-4001		Part	Rev.
00	19.07.2017	KRP	MLD	19.07.2017	RPM	19.07.2017	RPM	ISSUED AS STANDARD	00
Rev.	Date	Name	Date	Name	Date	Name	Date	Description	Status
Rev.	Date	Name	Date	Name	Date	Name	Date	Description	Status
BAR-Code								Store Location: Server/Share	
								Store Location: Folder	
								Store Name PCSP2	
Pro. Unit				TON		Group		Type of Document	Sheet 1 / 1
Con. Unit				Scale		Order No.		NTS	
								thysenkruupp	
								Description INSTALLATION STANDARDS – POWER LOCAL CONTROL STATION ON STEEL PLATFORM/GRATING (PCSP2)	
Date		Name		Date		Name			
19.07.2017		KRP		19.07.2017		MLD			
19.07.2017		RPM		19.07.2017		RPM			
19.07.2017		RPM		19.07.2017		RPM			

1	2	3	4	5	6
ITEM	DESCRIPTION	MATERIAL	QTY.	SUPPLY BY	INSTALLATION BY
1	LOCAL CONTROL STATION	PROJ. SPEC.	1 NO.	CLIENT	ELECTRICAL CONTRACTOR
2	ISMC 100	M.S. PAINTED	AS REQUIRED	REFER NOTE-4	
3	150 x 150 x10 THK PLATE	M.S. PAINTED	1 NO.	REFER NOTE-4	
4	ANCHOR FASTENER M10 x 75mm LONG WITH SUITABLE NUT & WASHER	GALVANISED STEEL / SS	4 NOS.	ELECTRICAL CONTRACTOR	ELECTRICAL CONTRACTOR
5	25 x 3mm THK FLAT	M.S. PAINTED	1 METER	REFER NOTE-3 & 4	
6	HEXAGONAL HEAD BOLT M10 X 30mm LONG, THREADS UPTO HEAD, WITH SUITABLE NUTS & WASHERS (REFER NOTE-3)	H.D.G.I.	4 SETS	ELECTRICAL CONTRACTOR	ELECTRICAL CONTRACTOR
7	CABLE TIE	PLASTIC	AS REQUIRED	ELECTRICAL CONTRACTOR	ELECTRICAL CONTRACTOR
8	EDGE PROTECTION FOR CABLE	RUBBER	1 NO.	ELECTRICAL CONTRACTOR	ELECTRICAL CONTRACTOR
9	CANOPY COVERED FROM 3 SIDES (REFER NOTE-5)	PROJ. SPEC.	1 NO.	ELECTRICAL CONTRACTOR	ELECTRICAL CONTRACTOR
10	HEXAGONAL HEAD BOLT M6 X 25mm LONG, THREADS UPTO HEAD, WITH SUITABLE NUTS & WASHERS (FOR CANOPY FIXING)	H.D.G.I.	4 SETS	ELECTRICAL CONTRACTOR	ELECTRICAL CONTRACTOR

REFER NOTE-3

WELD (TYP)

25 (MIN.)

DETAIL-1

WELD

25 (MIN) (TYP)

DETAIL-2

WELD

25 (MIN) (TYP)

DETAIL-3

NOTES

- ALL DIMENSIONS ARE IN 'mm' UNLESS OTHERWISE STATED.
- STEEL SECTIONS SHALL BE PREFABRICATED & PAINTED BEFORE INSTALLATION. AREA AFFECTED DUE TO SITE WELDING SHALL BE CLEANED AND PAINTED.
- THESE DETAILS SHALL BE VERIFIED WITH ORDERED EQUIPMENT DRAWING.
- SUPPLY & INSTALLATION OF STEEL IS NOT PART OF THIS INSTALLATION ARRANGEMENT. SAME IS COVERED ELSEWHERE.
- CANOPY COVERED FROM 3 SIDES SHALL BE PROVIDED FOR LOCAL CONTROL STATION INSTALLED OUTDOOR.

DRAWING NOT TO SCALE

Code	Contract No.	Document ID	Part	Rev.
00	19.07.2017	KRP	MLD	19.07.2017
Rev.	Date	Name	Date	Name
19.07.2017	19.07.2017	KRP	19.07.2017	KRP
19.07.2017	19.07.2017	MLD	19.07.2017	MLD
19.07.2017	19.07.2017	RPM	19.07.2017	RPM
19.07.2017	19.07.2017	RPM	19.07.2017	RPM

PIN-LEP-ELT-4001

Code	Contract No.	Document ID	Part	Rev.
00	19.07.2017	KRP	MLD	19.07.2017
Rev.	Date	Name	Date	Name
19.07.2017	19.07.2017	KRP	19.07.2017	KRP
19.07.2017	19.07.2017	MLD	19.07.2017	MLD
19.07.2017	19.07.2017	RPM	19.07.2017	RPM
19.07.2017	19.07.2017	RPM	19.07.2017	RPM

ISSUED AS STANDARD

Code	Contract No.	Document ID	Part	Rev.
00	19.07.2017	KRP	MLD	19.07.2017
Rev.	Date	Name	Date	Name
19.07.2017	19.07.2017	KRP	19.07.2017	KRP
19.07.2017	19.07.2017	MLD	19.07.2017	MLD
19.07.2017	19.07.2017	RPM	19.07.2017	RPM
19.07.2017	19.07.2017	RPM	19.07.2017	RPM

Store Location: Server/Share

Store Location: Folder

Store Name: PCSP3


Pro. Unit	TON	Group	Type of Document	Sheet
1	TON	Group	Type of Document	1 / 1

Con. Unit	Scale	Order No.
NTS	Scale	Order No.

thyssenkrupp

Date	Name	Description
19.07.2017	KRP	INSTANTATION STANDARDS - POWER
19.07.2017	MLD	LOCAL CONTROL STATION SUPPORTED
19.07.2017	RPM	FROM MOTOR FOUNDATION
19.07.2017	RPM	(PCSP3)

1		2		3		4	
ITEM		DESCRIPTION		MATERIAL		QTY.	
1		LOCAL CONTROL STATION		PROJ. SPEC.		1 NO.	
2		ISMC 75		M.S. PAINTED		AS REQUIRED	
3		25 x 3mm THK. FLAT		M.S. PAINTED		1.0 METER	
4		U BOLT M10 SIZE THREADED AT THE END SUITABLE FOR HANDRAIL PIPE WITH NUT & WASHERS.		H.D.G.I.		2 SETS	
5		HEXAGONAL HEAD BOLT M10 X 30mm LONG, THREADS UPTO HEAD, WITH SUITABLE NUTS & WASHERS (REFER NOTE-3)		H.D.G.I.		6 SETS	
6		CABLE TIE		PLASTIC		AS REQUIRED	
7		EDGE PROTECTION FOR CABLE		RUBBER		1 NO.	
8		CANOPY COVERED FROM 3 SIDES (REFER NOTE-5)		PROJ. SPEC.		1 NO.	
9		HEXAGONAL HEAD BOLT M6 X 25mm LONG, THREADS UPTO HEAD, WITH SUITABLE NUTS & WASHERS (FOR CANOPY FIXING)		H.D.G.I.		4 SETS	

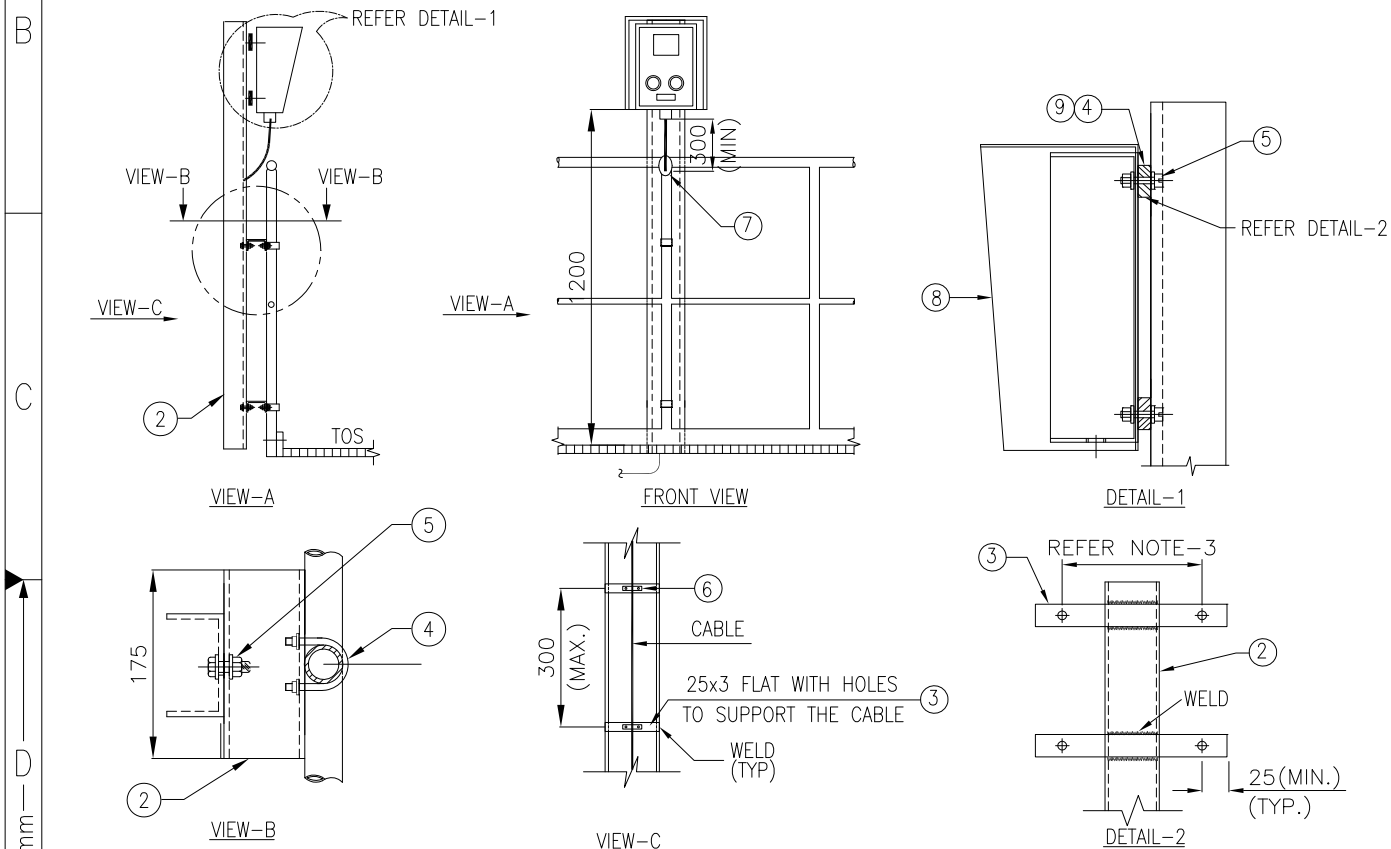


- 2) STEEL SECTIONS SHALL BE PREFABRICATED & PAINTED BEFORE INSTALLATION. AREA AFFECTED DUE TO SITE WELDING SHALL BE CLEANED AND PAINTED.
- 3) THESE DETAILS SHALL BE VERIFIED WITH ORDERED EQUIPMENT DRAWING.
- 4) SUPPLY & INSTALLATION OF STEEL IS NOT PART OF THIS INSTALLATION ARRANGEMENT. SAME IS COVERED ELSEWHERE.
- 5) CANOPY COVERED FROM 3 SIDES SHALL BE PROVIDED FOR LOCAL CONTROL STATION INSTALLED OUTDOOR.



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ISO A4

Code			Contract No.				Document ID				PIN-LEP-ELT-4001				Part		Rev. 00	
00	19.07.2017	KRP	MLD	19.07.2017	RPM	19.07.2017	RPM	ISSUED AS STANDARD				Cat. Code	Acc. Code	Status				
Rev.	Date	Name		Date	Name	Date	Name	Description			Acc. Code							
BAR-Code								Store Location: Server/Share										
								Store Location: Folder										
								Store Name PCSR1										
Pro. Unit		TON			Group		Type of Document			Sheet 1 / 1								
Con. Unit		Scale		Order No.		 thyssenkrupp												
		NTS																
	Date	Name		Description INSTALLATION STANDARDS – POWER LOCAL CONTROL STATION ON RAILING (PCSR1)														
Drawn	19.07.2017	KRP																
Prepared	19.07.2017	MLD																
Checked	19.07.2017	RPM																
Approved	19.07.2017	RPM																


A	1		2		50 mm		3		4	
	ITEM	DESCRIPTION			MATERIAL	QTY.	SUPPLY BY	INSTALLATION BY		
	1	LOCAL CONTROL STATION			PROJ. SPEC.	1 NO.	CLIENT	ELECTRICAL CONTRACTOR		
	2	ISM 75			M.S. PAINTED	AS REQUIRED	REFER NOTE-3 & 4			
	3	HEXAGONAL HEAD BOLT M10 X 30mm LONG, THREADS UPTO HEAD, WITH SUITABLE NUTS & WASHERS (REFER NOTE-3)			HDGI	4 SETS	ELECTRICAL CONTRACTOR	ELECTRICAL CONTRACTOR		
	4	CANOPY COVERED FROM 3 SIDES (REFER NOTE-5)			PROJ. SPEC.	1 NO.	ELECTRICAL CONTRACTOR	ELECTRICAL CONTRACTOR		
	5	HEXAGONAL HEAD BOLT M6 X 25mm LONG, THREADS UPTO HEAD, WITH SUITABLE NUTS & WASHERS (FOR CANOPY FIXING)			HDGI	4 SETS	ELECTRICAL CONTRACTOR	ELECTRICAL CONTRACTOR		



DRAWING NOT TO SCALE

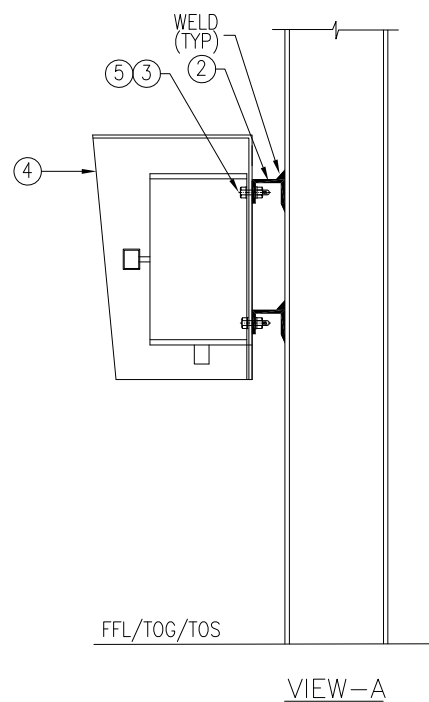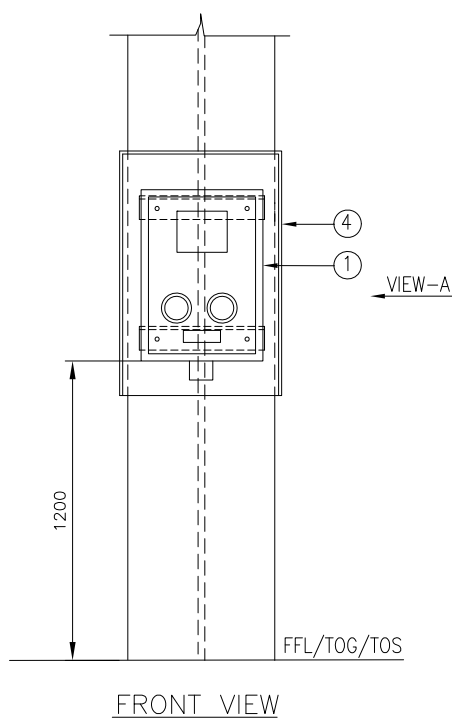NOTES

- 1) ALL DIMENSION ARE IN 'mm' UNLESS OTHERWISE STATED.
- 2) STEEL SECTIONS SHALL BE PREFABRICATED & PAINTED BEFORE INSTALLATION. AREA AFFECTED DUE TO SITE WELDING SHALL BE CLEANED AND PAINTED.
- 3) THESE DETAILS SHALL BE VERIFIED WITH ORDERED EQUIPMENT DRAWING.
- 4) SUPPLY & INSTALLATION OF STEEL IS NOT PART OF THIS INSTALLATION ARRANGEMENT. SAME IS COVERED ELSEWHERE.
- 5) CANOPY COVERED FROM 3 SIDES SHALL BE PROVIDED FOR LOCAL CONTROL STATION INSTALLED OUTDOOR.

Code			Contract No.			Document ID			PIN-LEP-ELT-4001			Part	Rev.
00	19.07.2017	KRP	MLD	19.07.2017	RPM	19.07.2017	RPM	ISSUED AS STANDARD			Cat. Code	Acc. Code	Status
Rev.	Date	Name		Date	Name		Date	Name		Description		Acc. Code	
		Drawn/Prepared				Checked				Approved			
BAR-Code								Store Location: Server/Share					
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								Store Name PCSS1					
Pro. Unit		TON		Group		Type of Document		Sheet		1 / 1			
Con. Unit		Scale		Order No.		 thyssenkrupp							
		NTS											
	Date	Name						Description					
Drawn	19.07.2017	KRP						INSTALLATION STANDARDS – POWER					
Prepared	19.07.2017	MLD						LOCAL CONTROL STATION ON					
Checked	19.07.2017	RPM						STEEL STRUCTURE					
Approved	19.07.2017	RPM						(PCSS1)					

ISO A4

1	2	3	4	5	6
ITEM	DESCRIPTION	MATERIAL	QTY.	SUPPLY BY	INSTALLATION BY
1	DISTRIBUTION BOARD/ PANEL	—	1 NO.	CLIENT	ELECTRICAL CONTRACTOR
2	ISMC 75	M.S. PAINTED	AS REQUIRED	REFER NOTE-3 & 4	
3	HEXAGONAL HEAD BOLT M10 X 30mm LONG, THREADS UPTO HEAD, WITH SUITABLE NUTS & WASHERS (REFER NOTE-3)	H.D.G.I.	4 SETS	ELECTRICAL CONTRACTOR	ELECTRICAL CONTRACTOR
4	ANCHOR FASTENER M10 x 75mm LONG WITH SUITABLE NUT & WASHER	SS	4 NOS.	ELECTRICAL CONTRACTOR	ELECTRICAL CONTRACTOR
5	CANOPY COVERED FROM 3 SIDES (REFER NOTE-5)	PROJ. SPEC.	1 NO.	ELECTRICAL CONTRACTOR	ELECTRICAL CONTRACTOR
6	HEXAGONAL HEAD BOLT M6 X 25mm LONG, THREADS UPTO HEAD, WITH SUITABLE NUTS & WASHERS (FOR CANOPY FIXING)	H.D.G.I.	4 SETS	ELECTRICAL CONTRACTOR	ELECTRICAL CONTRACTOR

FRONT VIEW

VIEW-A

DRAWING NOT TO SCALE

NOTES

- 1) ALL DIMENSION ARE IN 'mm' UNLESS OTHERWISE STATED.
- 2) STEEL SECTIONS SHALL BE PREFABRICATED & PAINTED BEFORE INSTALLATION.
- 3) THESE DETAILS SHALL BE VERIFIED WITH ORDERED EQUIPMENT DRAWING.
- 4) SUPPLY & INSTALLATION OF STEEL IS NOT PART OF THIS INSTALLATION ARRANGEMENT. SAME IS COVERED ELSEWHERE.
- 5) CANOPY COVERED FROM 3 SIDES SHALL BE PROVIDED FOR DISTRIBUTION BOARD/PANEL INSTALLED OUTDOOR.

Code				Contract No.				Document ID				Part		Rev.	
								PIN-LEP-ELT-4001						00	
00	19.07.2017	KRP	MLD	19.07.2017	RPM	19.07.2017	RPM	ISSUED AS STANDARD				Cat. Code	Acc. Code	Status	
Rev.	Date	Name	Drawn/Prepared	Date	Name	Date	Name	Description				Acc. Code			
BAR-Code								Store Location: Server/Share							
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								Store Name PDBC1							
Pro. Unit				TON		Group		Type of Document		Sheet		1 / 1			
Con. Unit				Scale		Order No.									
								NTS							

	Date	Name	Description
Drawn	19.07.2017	KRP	INSTALLATION STANDARDS – POWER DISTRIBUTION BOARD/PANELS (≤1000MM) ON BRACKET, ON WALL/CONCRETE COLUMN (PDBC1)
Prepared	19.07.2017	MLD	
Checked	19.07.2017	RPM	
Approved	19.07.2017	RPM	

1


2

50 mm

3


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ITEM	DESCRIPTION	MATERIAL	QTY.	SUPPLY BY	INSTALLATION BY
1	DISTRIBUTION BOARD/ PANEL	—	1 NO.	CLIENT	ELECTRICAL CONTRACTOR
2	ISM 75	M.S. PAINTED	AS REQUIRED	REFER NOTE-3 & 4	
3	HEXAGONAL HEAD BOLT M10 X 30mm LONG, THREADS UPTO HEAD, WITH SUITABLE NUTS & WASHERS (REFER NOTE-3)	H.D.G.I.	4 SETS	ELECTRICAL CONTRACTOR	ELECTRICAL CONTRACTOR
4	CANOPY COVERED FROM 3 SIDES (REFER NOTE-5)	PROJ. SPEC.	1 NO.	ELECTRICAL CONTRACTOR	ELECTRICAL CONTRACTOR
5	HEXAGONAL HEAD BOLT M6 X 25mm LONG, THREADS UPTO HEAD, WITH SUITABLE NUTS & WASHERS (FOR CANOPY FIXING)	H.D.G.I.	4 SETS	ELECTRICAL CONTRACTOR	ELECTRICAL CONTRACTOR

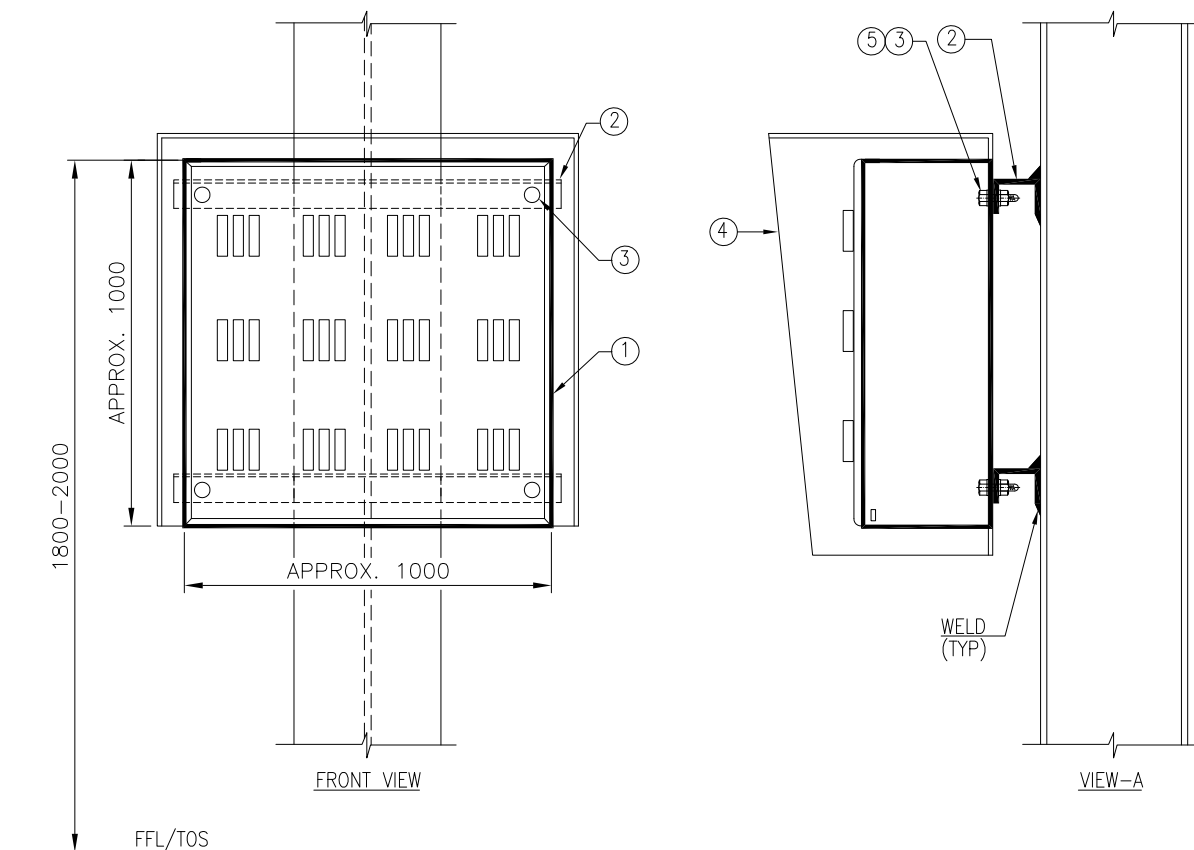


NOTES

- 1) ALL DIMENSION ARE IN 'mm' UNLESS OTHERWISE SPECIFIED.
- 2) STEEL SECTIONS SHALL BE PREFABRICATED & PAINTED BEFORE INSTALLATION. AREA AFFECTED DUE TO SITE WELDING SHALL BE CLEANED AND PAINTED.
- 3) THESE DETAILS SHALL BE VERIFIED WITH ORDERED EQUIPMENT DRAWING.
- 4) SUPPLY & INSTALLATION OF STEEL IS NOT PART OF THIS INSTALLATION ARRANGEMENT. SAME IS COVERED ELSEWHERE.
- 5) CANOPY COVERED FROM 3 SIDES SHALL BE PROVIDED FOR DISTRIBUTION BOARD/PANEL INSTALLED OUTDOOR.

Code			Contract No.				Document ID				PIN-LEP-ELT-4001				Part		Rev.		
00	19.07.2017	KRP	MLD	19.07.2017	RPM	19.07.2017	RPM	ISSUED AS STANDARD				Cat. Code	Acc. Code	Status					
Rev.	Date	Name		Date	Name		Date	Name		Description					Acc. Code				
Drawn/Prepared												Checked		Approved					
BAR-Code												Store Location: Server/Share							
												Store Location: Folder							
												Store Name PDBS1							
Pro. Unit		TON			Group		Type of Document			Sheet 1 / 1									
Con. Unit		Scale		Order No.			 thyssenkrupp												
		NTS																	
	Date	Name		Description INSTALLATION STANDARDS – POWER DISTRIBUTION BOARD/PANEL (≤1000MM) ON BRACKET, ON STRUCTURAL COLUMN (PDBS1)															
Drawn	19.07.2017	KRP																	
Prepared	19.07.2017	MLD																	
Checked	19.07.2017	RPM																	
Approved	19.07.2017	RPM																	

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
1		2		3		4	
ITEM		DESCRIPTION		MATERIAL		QTY.	
SUPPLY BY		INSTALLATION BY					
1		DISTRIBUTION BOARD/ PANEL		-		2 OR MORE	
2		ISMC 75		M.S. PAINTED		AS REQUIRED	
3		ISMC 100		M.S. PAINTED		AS REQUIRED	
4		150 x 150 x10 THK PLATE		M.S. PAINTED		2 NOS.	
5		HEXAGONAL HEAD BOLT M10 X 30mm LONG, THREADS UPTO HEAD, WITH SUITABLE NUTS & WASHERS (REFER NOTE-3)		H.D.G.I.		AS REQUIRED	
6		CANOPY COVERED FROM 3 SIDES (REFER NOTE-5)		PROJ. SPEC.		1 NO.	
7		HEXAGONAL HEAD BOLT M6 X 25mm LONG, THREADS UPTO HEAD, WITH SUITABLE NUTS & WASHERS (FOR CANOPY FIXING)		H.D.G.I.		4 SETS	

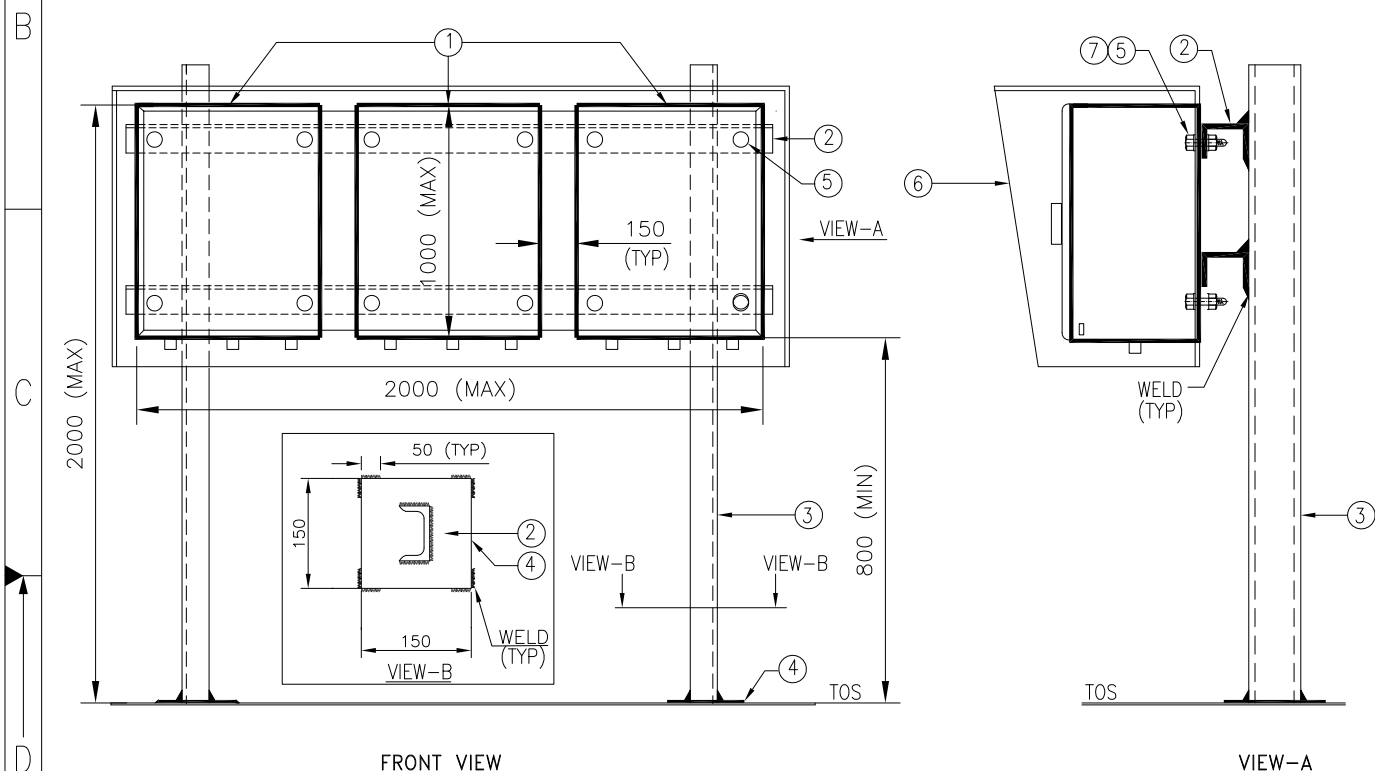


DRAWING NOT TO SCALE

NOTES

- 1) ALL DIMENSION ARE IN 'mm' UNLESS OTHERWISE SPECIFIED.
- 2) STEEL SECTIONS SHALL BE PREFABRICATED & PAINTED BEFORE INSTALLATION. AREA AFFECTED DUE TO SITE WELDING SHALL BE CLEANED AND PAINTED.
- 3) THESE DETAILS SHALL BE VERIFIED WITH ORDERED EQUIPMENT DRAWING.
- 4) SUPPLY & INSTALLATION OF STEEL IS NOT PART OF THIS INSTALLATION ARRANGEMENT. SAME IS COVERED ELSEWHERE.
- 5) CANOPY COVERED FROM 3 SIDES SHALL BE PROVIDED FOR DISTRIBUTION/ FIELD PANELS INSTALLED OUTDOOR.

E	Code			Contract No.				Document ID				PIN-LEP-ELT-4001				Part		Rev. 00	
	00	19.07.2017	KRP	MLD	19.07.2017	RPM	19.07.2017	RPM	ISSUED AS STANDARD				Cat. Code	Acc. Code	Status				
	Rev.	Date	Name		Date	Name		Date	Name		Description					Acc. Code			
F	BAR-Code										Store Location: Server/Share								
											Store Location: Folder								
											Store Name PFPP2								
	Pro. Unit		TON			Group		Type of Document			Sheet 1 / 1								
	Con. Unit		Scale		Order No.		NTS						 thyssenkrupp						
ISO A4		Date	Name																
	Drawn	19.07.2017	KRP																
	Prepared	19.07.2017	MLD																
	Checked	19.07.2017	RPM																
	Approved	19.07.2017	RPM																
										Description INSTALLATION STANDARDS – POWER DISTRIBUTION BOARD/ PANEL ON STEEL PLATFORM, ON SELF STANDING PEDASTAL (PFPP2)									

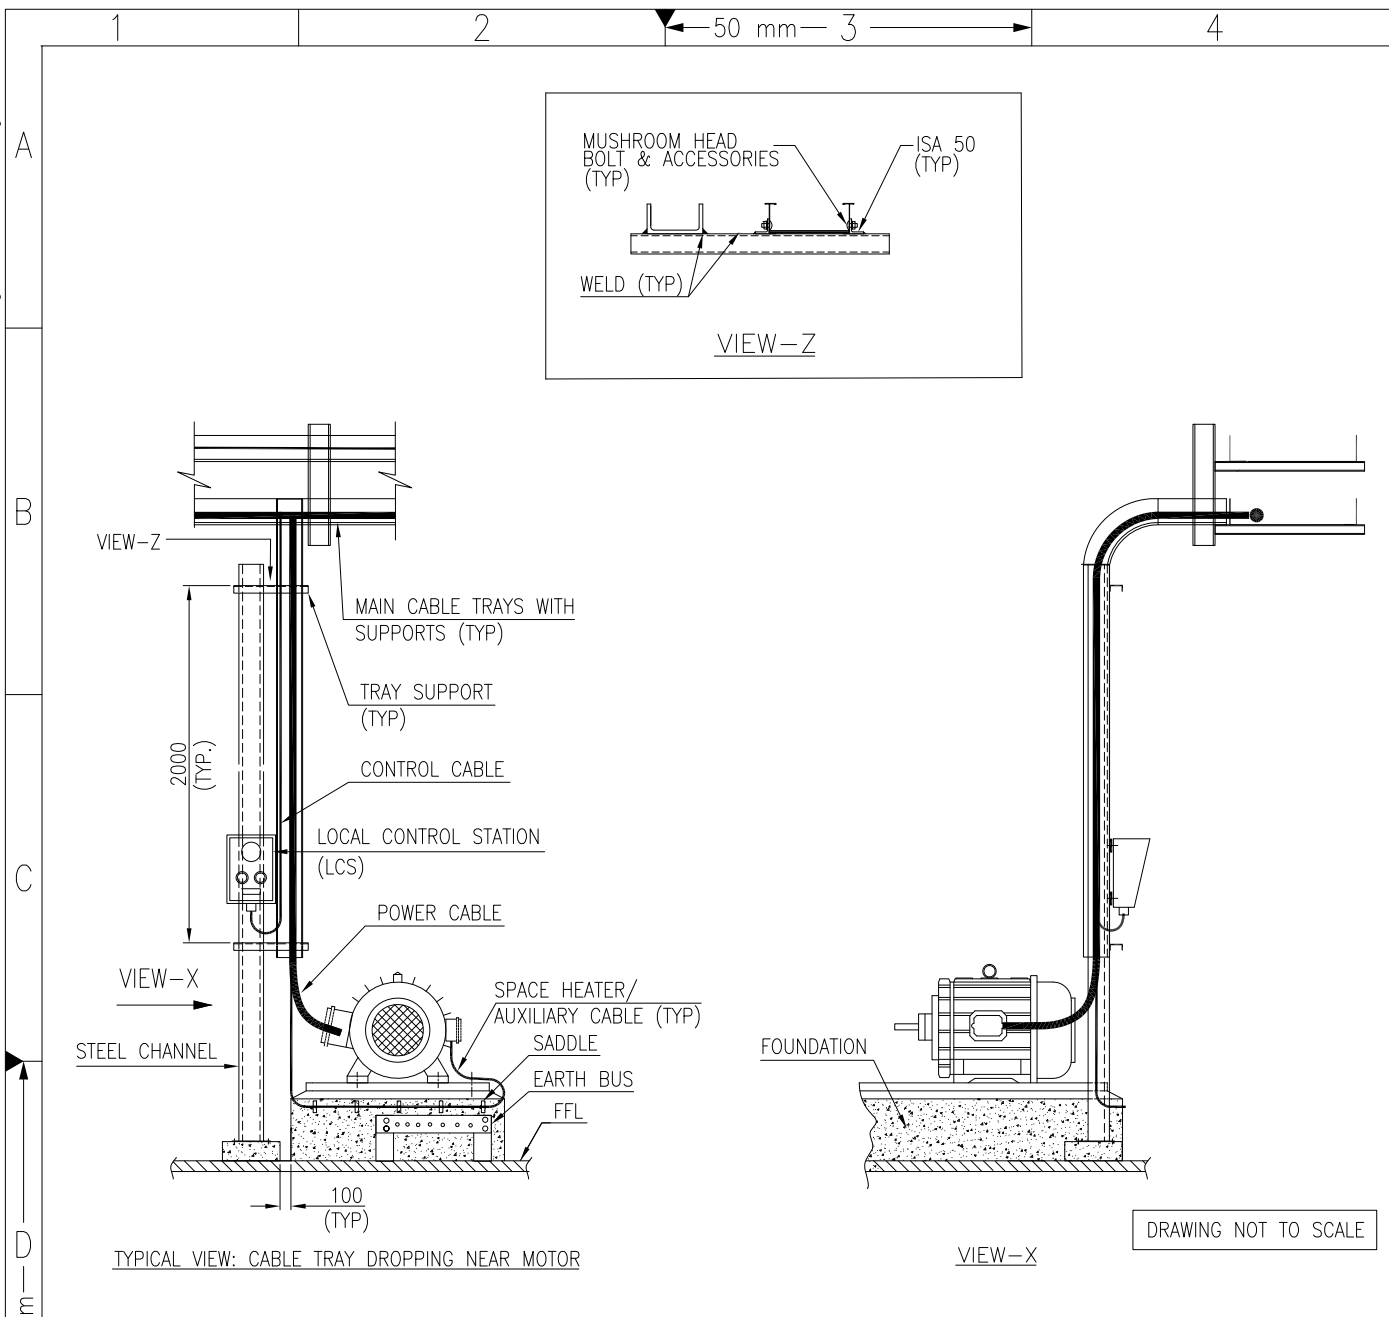

NOTES

- 1) ALL DIMENSION ARE IN 'mm' UNLESS OTHERWISE SPECIFIED.
- 2) THE INSTALLATION ARRANGEMENT IS INDICATIVE ONLY. ACTUAL INSTALLATION SHALL BE SUIT TO SITE CONDITIONS.
- 3) SINGLE RUN OF POWER CABLE WITH OF OD $\leq 25\text{mm}$ & ASSOCIATED AUXILIARY CABLES SHALL BE ROUTED THROUGH "C" SECTION WITH SUITABLE TYING/FIXING ARRANGEMENT. FOR OD OF CABLES $> 25\text{mm}$, CABLE TRAY WIDTH NEAR MOTOR DROPPING SHALL BE DECIDED BASED ON OD OF THE CABLE, NO. OF RUNS, REQUIREMENT OF BARRIER, SPACE AVAILABILITY ETC.
- 4) FOR MATERIAL, QUANTITY & DETAILS OF LCS INSTALLATION, REFER RELEVANT INSTALLATION ARRANGEMENT SPECIFIED IN LAYOUT.
- 5) FOR MATERIAL, QUANTITY & DETAILS OF EARTH BUS INSTALLATION, REFER RELEVANT INSTALLATION ARRANGEMENT SPECIFIED IN LAYOUT.

Code		Contract No.		Document ID		PIN-LEP-ELT-4001		Part	Rev.
00	19.07.2017	KRP	MLD	19.07.2017	RPM	19.07.2017	RPM	ISSUED AS STANDARD	00
Rev.	Date	Name	Date	Name	Date	Name	Description	Acc. Code	Status

BAR-Code

Store Location: Server/Share

Store Location: Folder


Store Name
PMAG1


Pro. Unit	TON	Group	Type of Document	Sheet
				1 / 1

Con. Unit	Scale	Order No.	
	NTS		thyssenkrupp

ISO A4

	Date	Name	Description
Drawn	19.07.2017	KRP	INSTALLATION STANDARDS – POWER POWER & CONTROL CABLING FOR MOTORS, ROUTED ABOVE GROUND (PMAG1)
Prepared	19.07.2017	MLD	
Checked	19.07.2017	RPM	
Approved	19.07.2017	RPM	

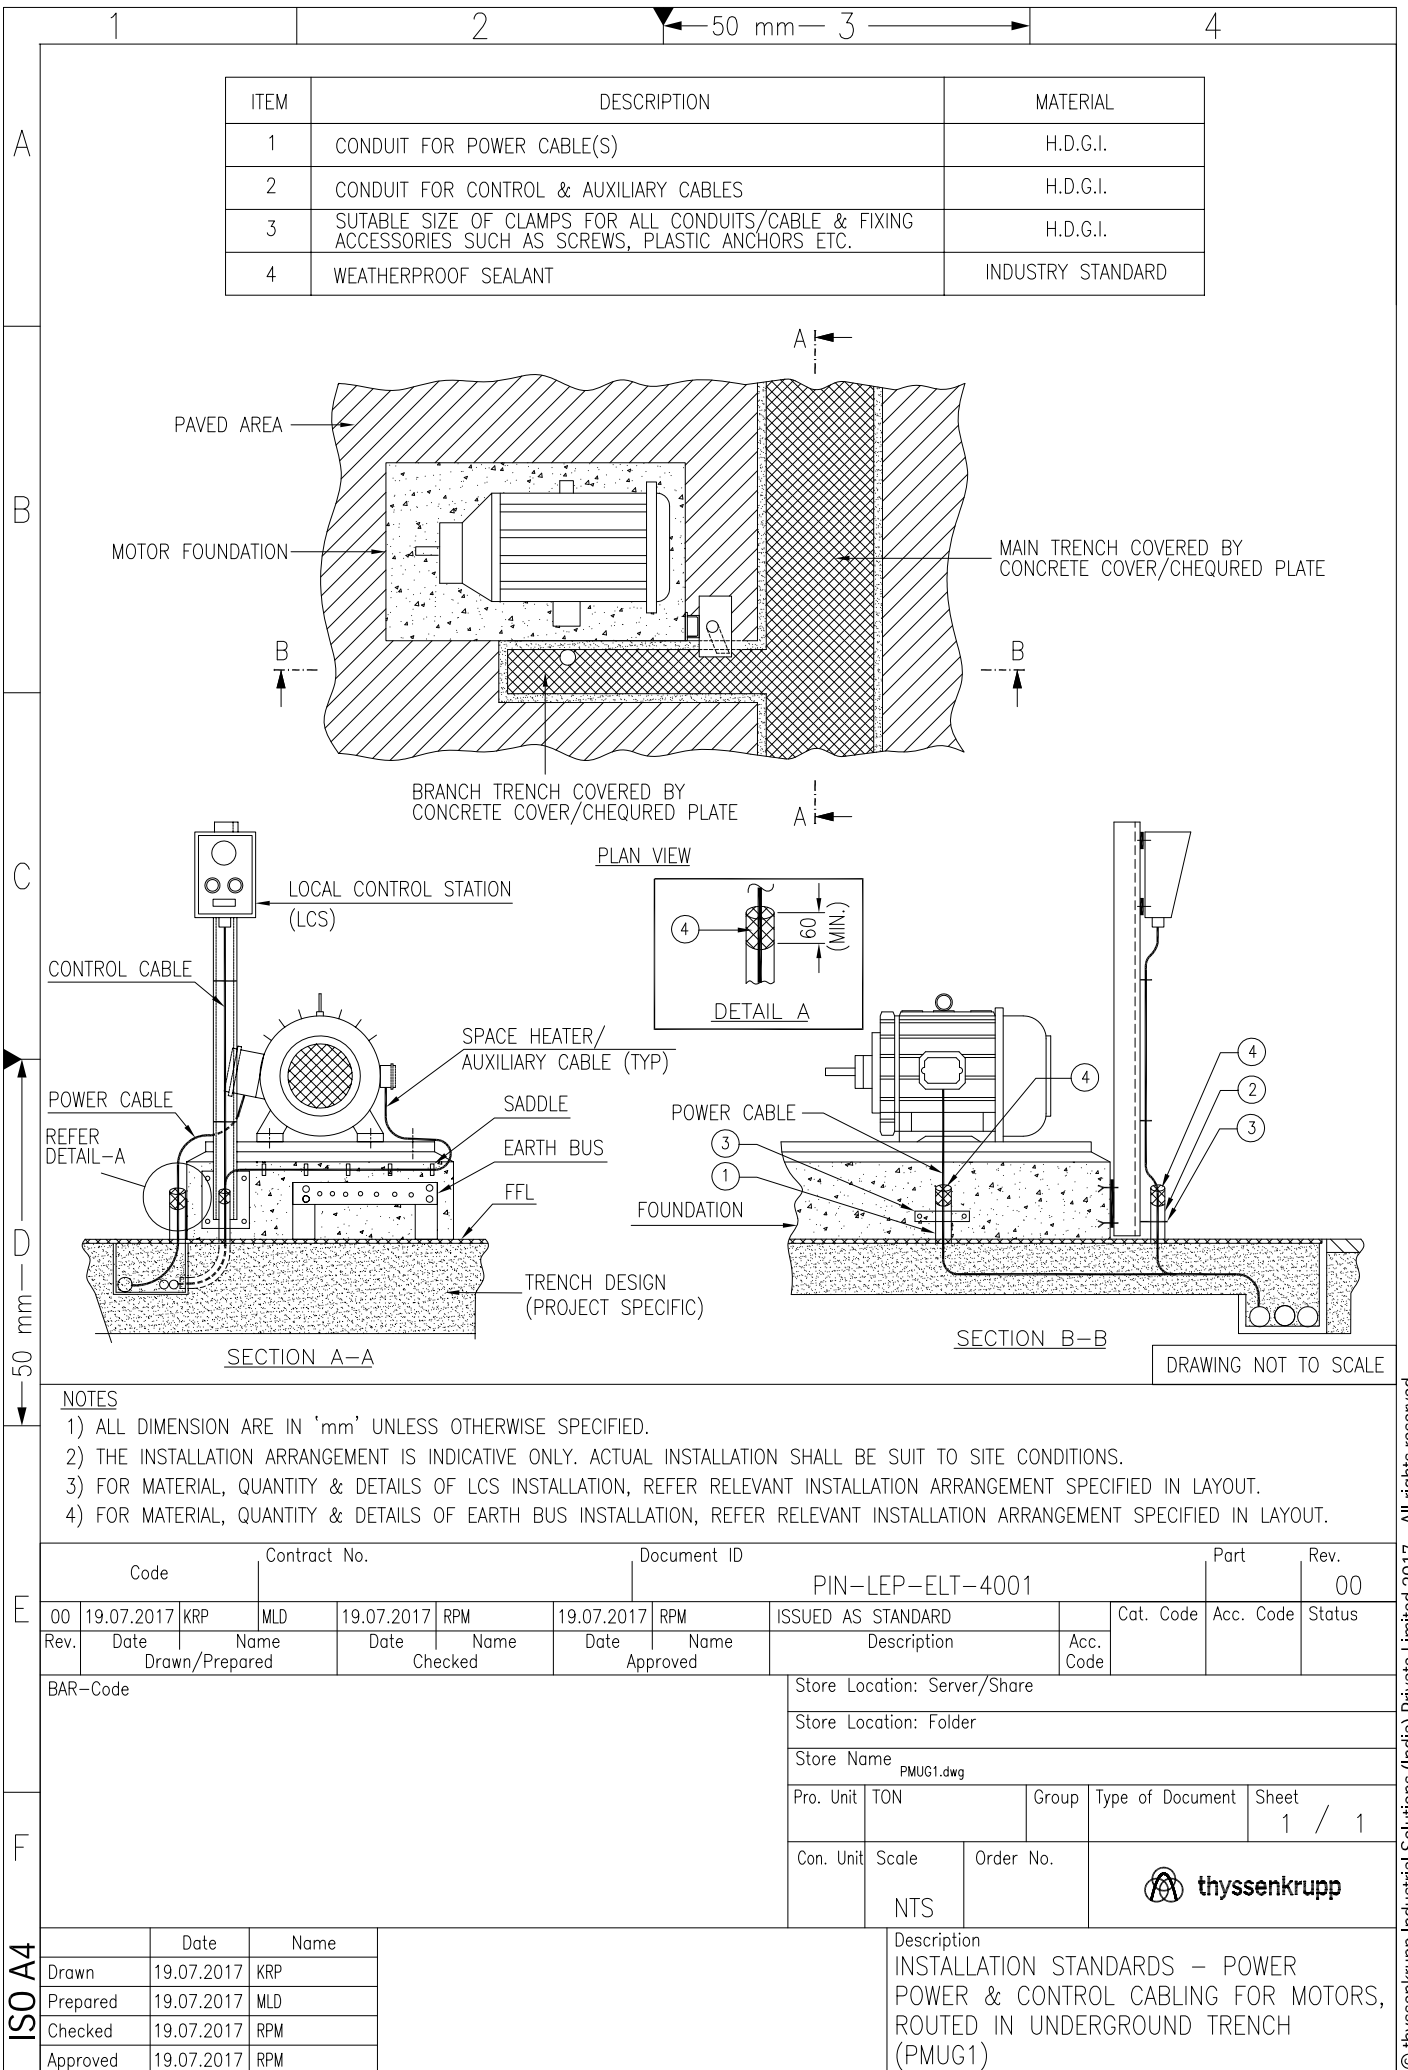

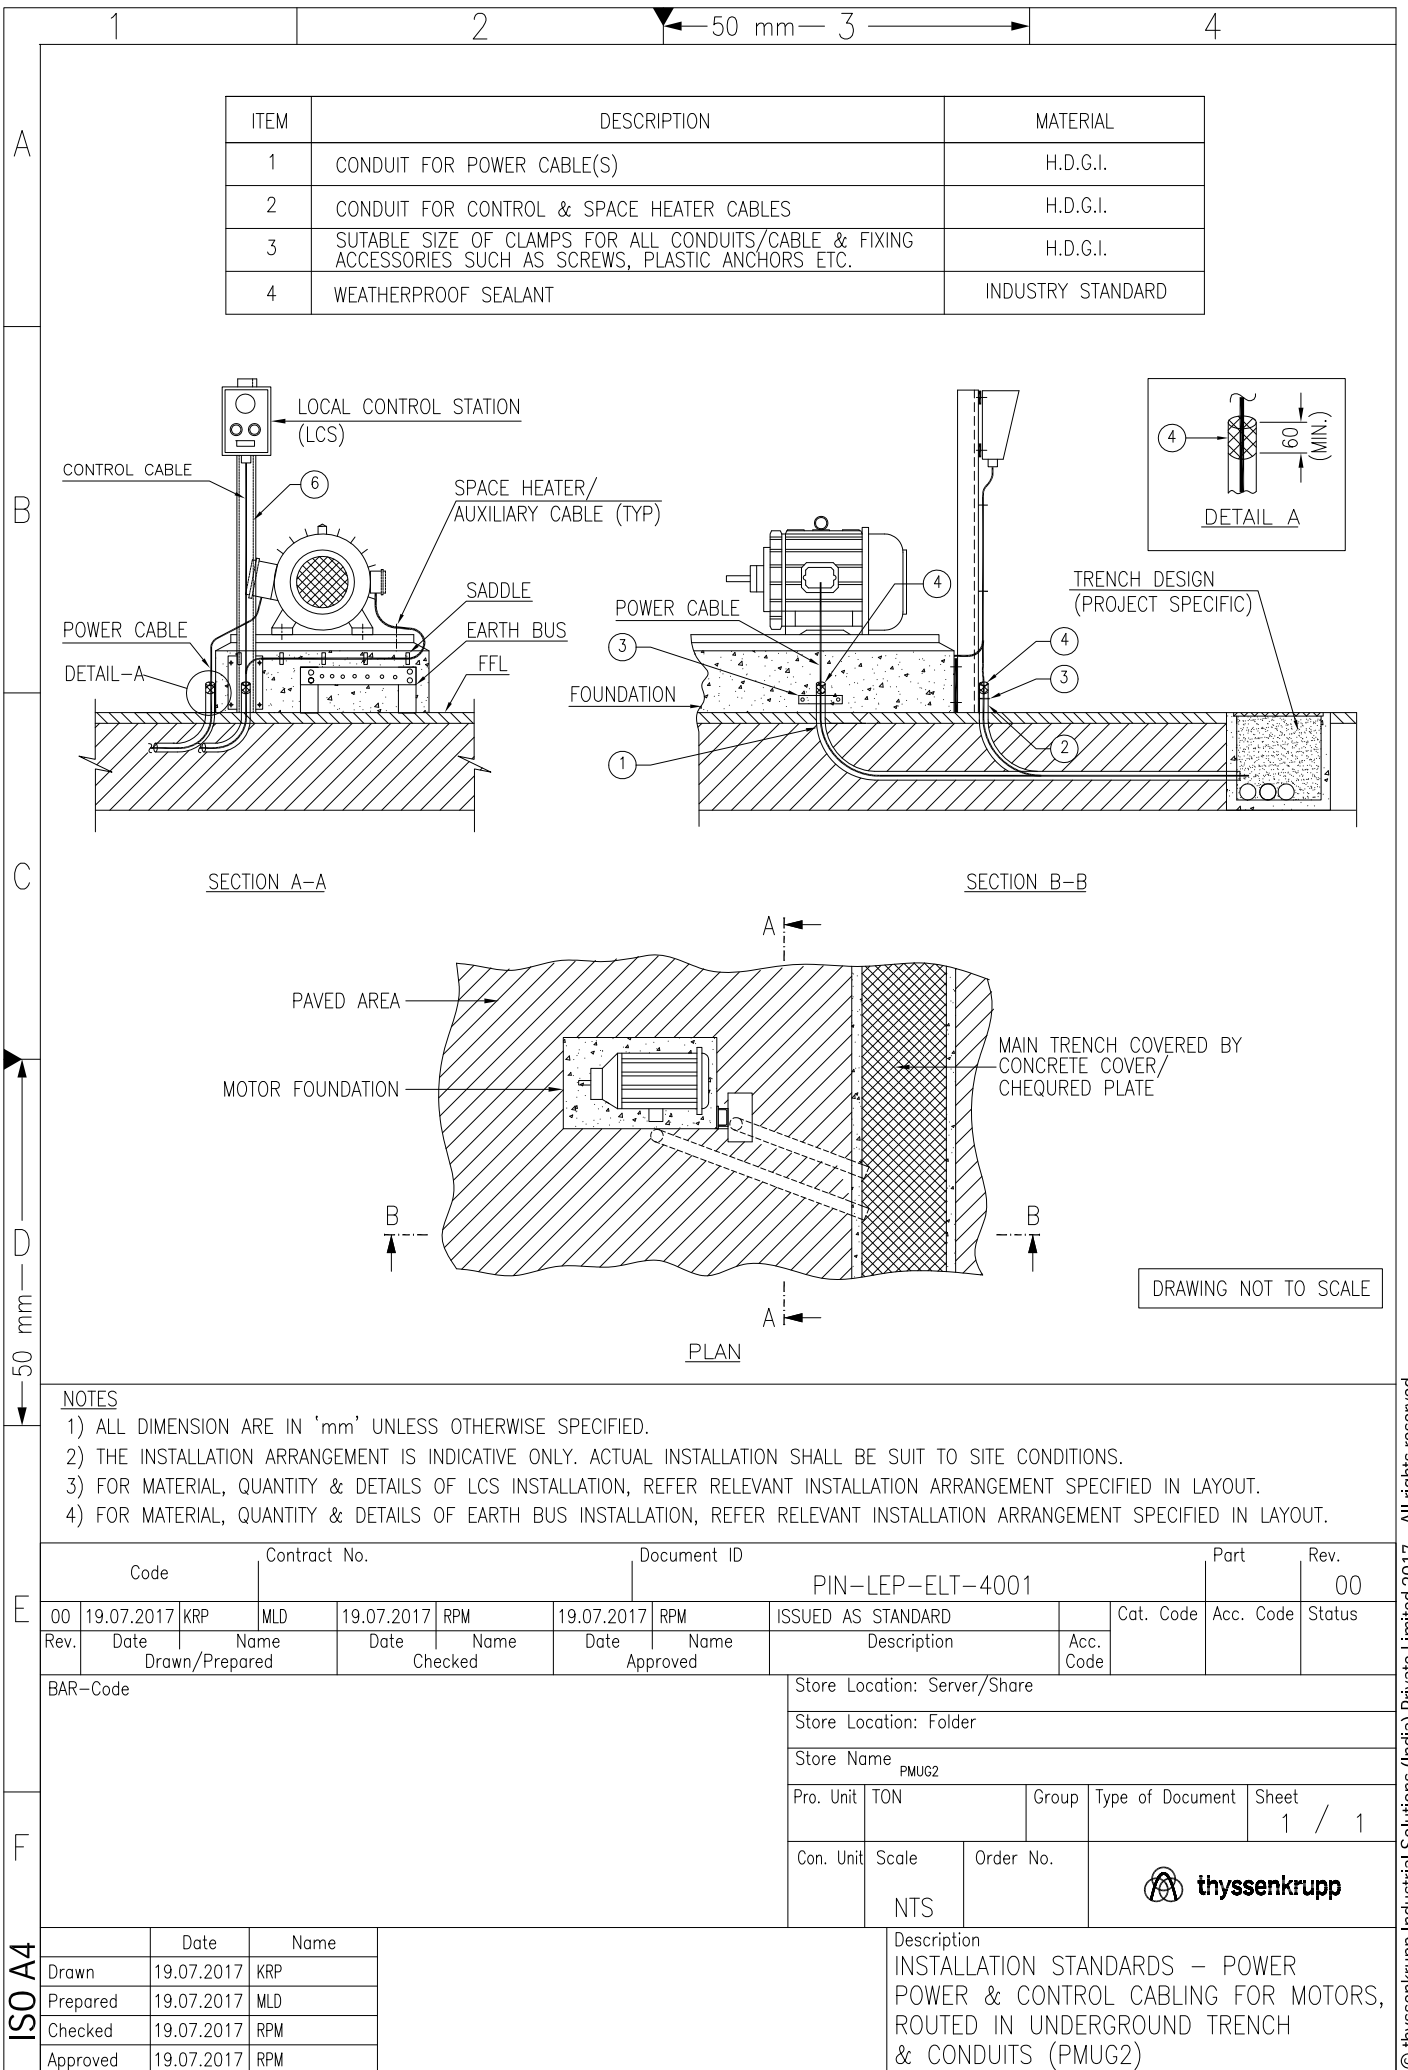

1	2	3	4	5	6
ITEM	DESCRIPTION	MATERIAL	QTY.	SUPPLY BY	INSTALLATION BY
1	SOCKET OUTLET	PROJ. SPEC.	1 NO.	CLIENT	ELECTRICAL CONTRACTOR
2	ISMC 75	M.S. PAINTED	AS REQUIRED	REFER NOTE-3 & 4	
3	HEXAGONAL HEAD BOLT M10 X 30mm LONG, THREADS UPTO HEAD, WITH SUITABLE NUTS & WASHERS (REFER NOTE-3)	H.D.G.I.	4 SETS	ELECTRICAL CONTRACTOR	ELECTRICAL CONTRACTOR
4	ANCHOR FASTENER M10 x 75mm LONG WITH SUITABLE NUT & WASHER	GALVANISED STEEL/SS	4 NOS.	ELECTRICAL CONTRACTOR	ELECTRICAL CONTRACTOR
5	CANOPY COVERED FROM 3 SIDES (REFER NOTE-5)	PROJ. SPEC.	1 NO.	ELECTRICAL CONTRACTOR	ELECTRICAL CONTRACTOR
6	HEXAGONAL HEAD BOLT M6 X 25mm LONG, THREADS UPTO HEAD, WITH SUITABLE NUTS & WASHERS (FOR CANOPY FIXING)	H.D.G.I.	4 SETS	ELECTRICAL CONTRACTOR	ELECTRICAL CONTRACTOR

FRONT VIEW

VIEW-A

DRAWING NOT TO SCALE

NOTES


- ALL DIMENSION ARE IN 'mm' UNLESS OTHERWISE SPECIFIED.
- STEEL SECTIONS SHALL BE PREFABRICATED & PAINTED BEFORE INSTALLATION.
- THESE DETAILS SHALL BE VERIFIED WITH ORDERED EQUIPMENT DRAWING.
- SUPPLY & INSTALLATION OF STEEL IS NOT PART OF THIS INSTALLATION ARRANGEMENT. SAME IS COVERED ELSEWHERE.
- CANOPY COVERED FROM 3 SIDES SHALL BE PROVIDED FOR SOCKET INSTALLED OUTDOOR.

Code		Contract No.		Document ID				Part		Rev.	
00	19.07.2017	KRP	MLD	19.07.2017	RPM	19.07.2017	RPM	PIN-LEP-ELT-4001		00	
Rev.	Date	Name		Date	Name	Date	Name	Description		Acc. Code	Status
		Drawn/Prepared			Checked		Approved				

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Con. Unit		Scale		Order No.									
		NTS											


Date		Name		Description	
Drawn	19.07.2017	KRP		INSTALLATION STANDARDS – POWER	
Prepared	19.07.2017	MLD		SOCKET OUTLET ON BRACKET,	
Checked	19.07.2017	RPM		ON WALL/CONCRETE COLUMN	
Approved	19.07.2017	RPM		(PSOC1)	


ITEM	DESCRIPTION	MATERIAL	QTY.	SUPPLY BY	INSTALLATION BY
1	SOCKET OUTLET	PROJ. SPEC.	1 NO.	CLIENT	ELECTRICAL CONTRACTOR
2	ISM 75	M.S. PAINTED	AS REQUIRED	REFER NOTE-3 & 4	
3	HEXAGONAL HEAD BOLT M10 X 30mm LONG, THREADS UPTO HEAD, WITH SUITABLE NUTS & WASHERS (REFER NOTE-3)	H.D.G.I.	4 SETS	ELECTRICAL CONTRACTOR	ELECTRICAL CONTRACTOR
4	CANOPY COVERED FROM 3 SIDES (REFER NOTE-5)	PROJ. SPEC.	1 NO.	ELECTRICAL CONTRACTOR	ELECTRICAL CONTRACTOR
5	HEXAGONAL HEAD BOLT M6 X 25mm LONG, THREADS UPTO HEAD, WITH SUITABLE NUTS & WASHERS (FOR CANOPY FIXING)	H.D.G.I.	4 SETS	ELECTRICAL CONTRACTOR	ELECTRICAL CONTRACTOR

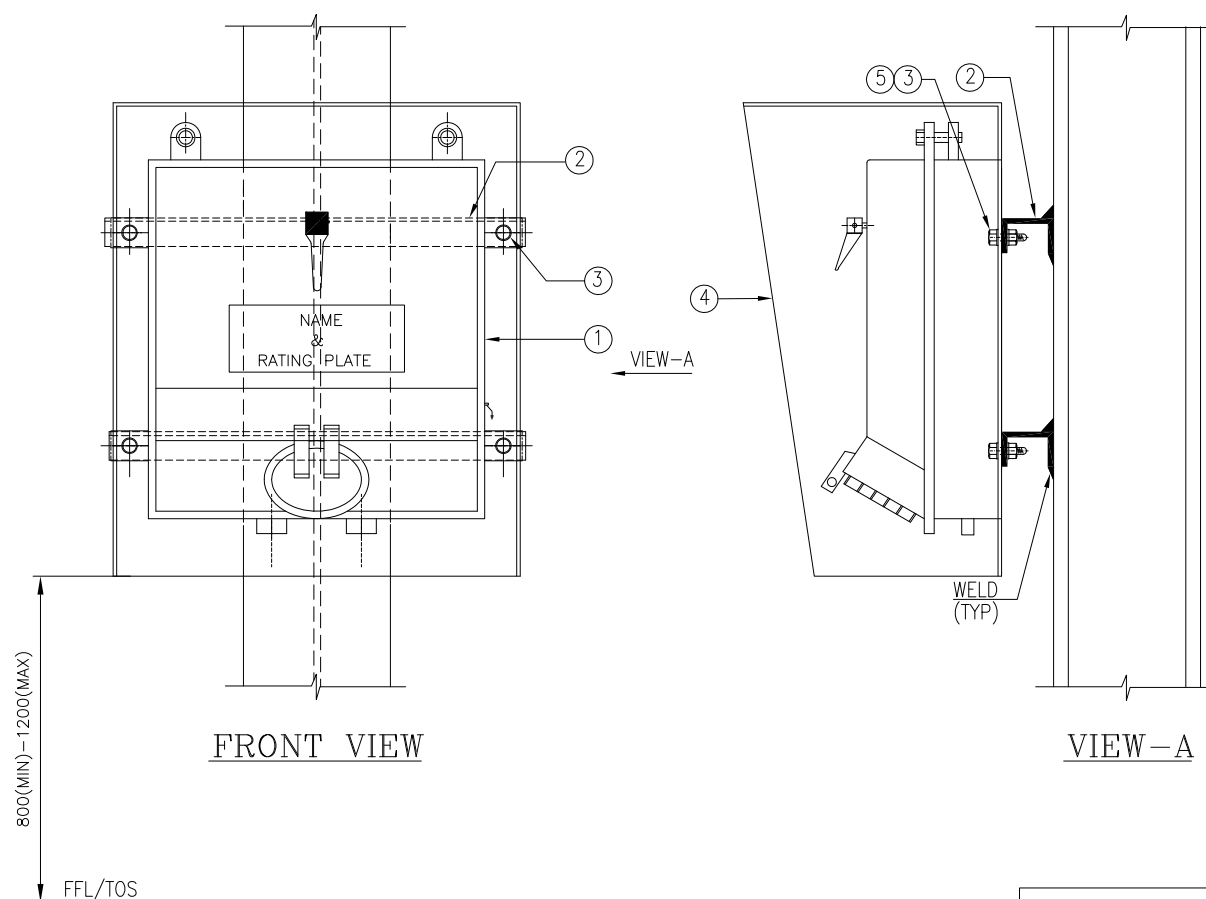

NOTES

- 1) ALL DIMENSION ARE IN 'mm' UNLESS OTHERWISE SPECIFIED.
- 2) STEEL SECTIONS SHALL BE PREFABRICATED & PAINTED BEFORE INSTALLATION. AREA AFFECTED DUE TO SITE WELDING SHALL BE CLEANED AND PAINTED.
- 3) THESE DETAILS SHALL BE VERIFIED WITH ORDERED EQUIPMENT DRAWING.
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00	19.07.2017	KRP	MLD	19.07.2017	RPM	19.07.2017	RPM	ISSUED AS STANDARD			Cat. Code	Acc. Code	Status
Rev.	Date	Name		Date	Name		Date	Name		Description		Acc. Code	
		Drawn/Prepared				Checked				Approved			
BAR-Code								Store Location: Server/Share					
								Store Location: Folder					
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		Pro. Unit		TON		Group		Type of Document		Sheet 1 / 1			
		Con. Unit		Scale		Order No.		 thyssenkrupp					
				NTS									
	Date	Name						Description					
Drawn	19.07.2017	KRP						INSTALLATION STANDARDS – POWER					
Prepared	19.07.2017	MLD						SOCKET OUTLET ON BRACKET,					
Checked	19.07.2017	RPM						ON STRUCTURAL COLUMN					
Approved	19.07.2017	RPM						(PSOS1)					

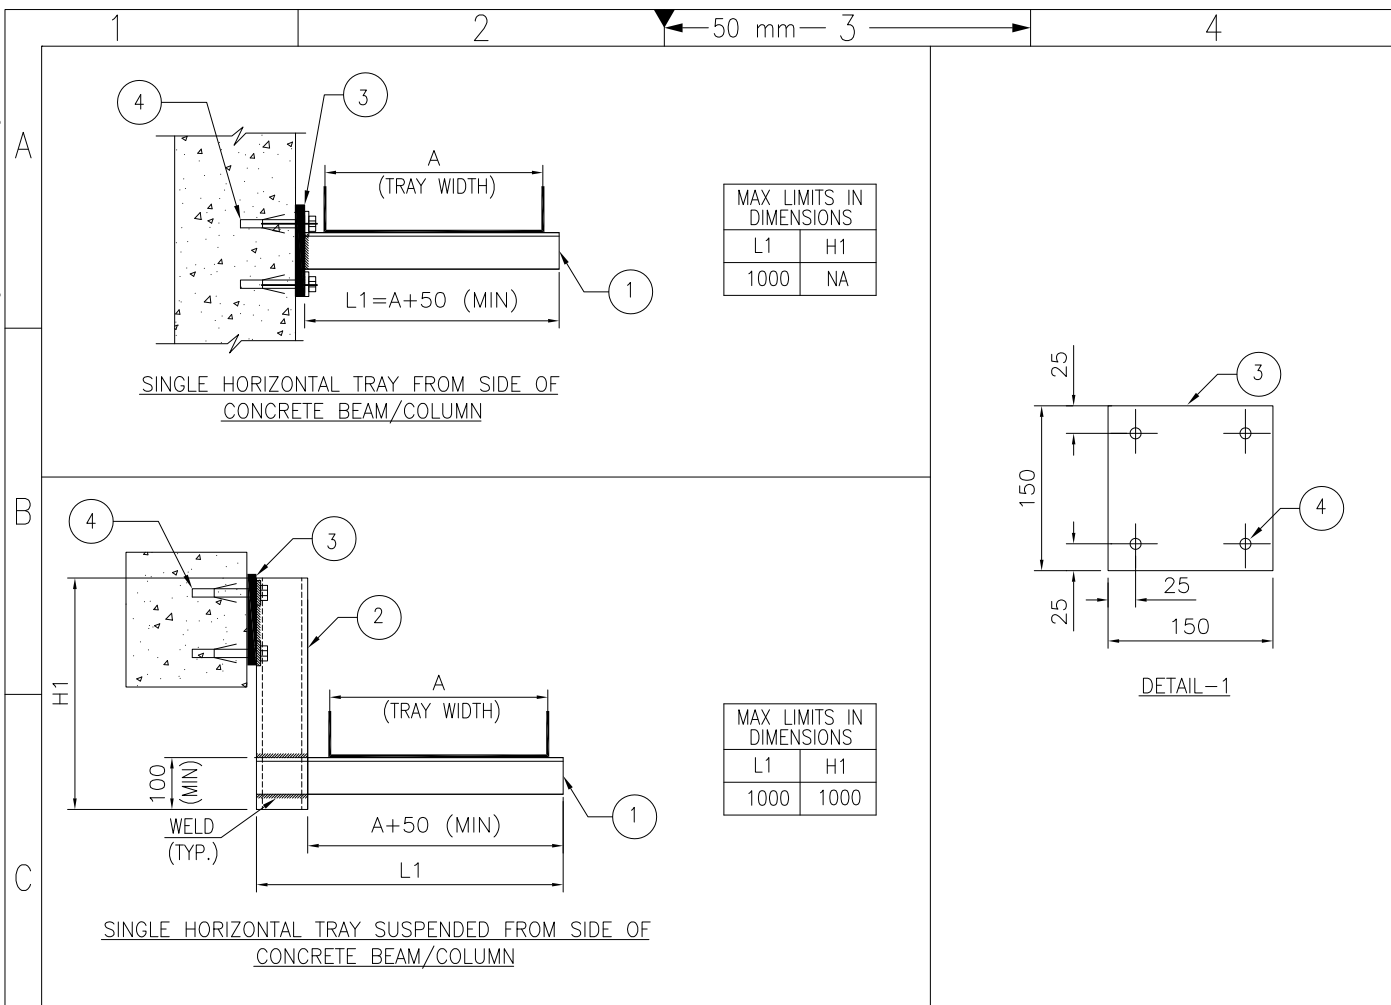


ITEM	DESCRIPTION	MATERIAL
1	ISA 75 (75x75x6mm)	MS PAINTED
2	ISMC 100	MS PAINTED
3	150x150x10mm THK. PLATE (REFER DETAIL-1)	MS PAINTED
4	M10 X 75 LONG HEAVY DUTY ANCHOR FASTENER WITH SUITABLE NUT & WASHER	GALVANISED STEEL/SS

NOTES

- 1) ALL DIMENSION ARE IN 'mm' UNLESS OTHERWISE STATED.
 - 2) TYPICAL ARRANGEMENT IS INDICATED IN THE DRAWING.
 - 3) GENERALLY, ALL CABLE TRAY SUPPORTS SHALL BE ENGINEERED IN COORDINATION WITH CIVIL DEPARTMENT. THIS INSTALLATION ARRANGEMENT SHALL BE FOLLOWED IN EXCEPTIONAL CASES ONLY. E.G. TRAYS ENGINEERED AFTER CIVIL INFORMATION DUE TO LACK OF INFORMATION ON PACKAGE UNIT CONSUMERS ETC.
 - 4) STEEL SECTIONS SHALL BE PREFABRICATED & PAINTED BEFORE INSTALLATION. AREA AFFECTED DUE TO SITE WELDING SHALL BE CLEANED AND PAINTED.
 - 5) SUPPORTING DETAILS ARE APPLICABLE FOR TRAY WIDTHS 600MM & BELOW.
 - 6) INSERT PLATE SHALL BE ANCHORED AT THE CENTER OF THE AVAILABLE SURFACE.

DRAWING NOT TO SCALE

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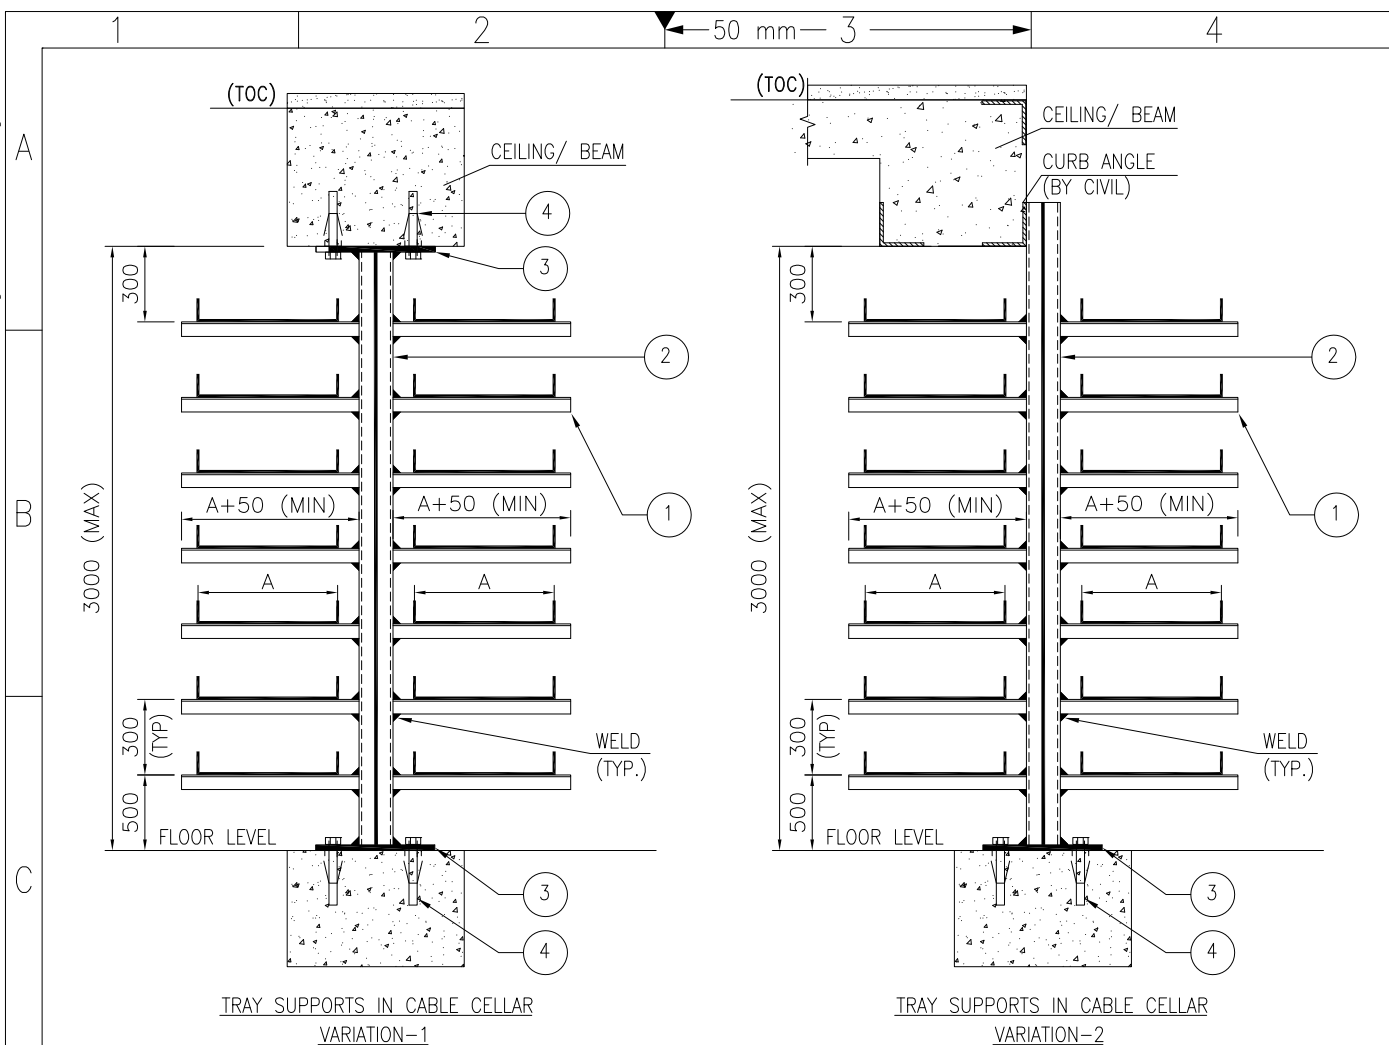
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	Pro. Unit	TON	Group	Type of Document	Sheet	1 / 1	
Con. Unit	Scale	Order No.	 thyssenkrupp				
	NTS						

	Date	Name	Description
Drawn	19.07.2017	KRP	INSTALLATION STANDARDS – POWER
Prepared	19.07.2017	MLD	TYPICAL DETAILS OF CABLE TRAY
Checked	19.07.2017	RPM	SUPPORTING: TYPE-1
Approved	19.07.2017	RPM	(PCTS1)


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<p>Code Contract No. Document ID Part Rev.</p> <p>PIN-LEP-ELT-4001 00</p>																																							
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<p>BAR-Code</p> <p>Store Location: Server/Share</p> <p>Store Location: Folder</p> <p>Store Name PCTSS</p> <p>Pro. Unit TON Group Type of Document Sheet 1 / 1</p> <p>Con. Unit Scale Order No.</p> <p>NTS</p> <p> thyssenkrupp</p>																																							
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19.07.2017	RPM	Checked																																					
19.07.2017	RPM	Approved																																					



ITEM	DESCRIPTION	MATERIAL
1	ISA 75 (75x75x6mm)	MS PAINTED
2	ISMC 100 BOX	MS PAINTED
3	200x200x10mm THK. PLATE (REFER DETAIL-1)	MS PAINTED
4	M10 X 75 LONG HEAVY DUTY ANCHOR FASTENER WITH SUITABLE NUT & WASHER	GALVANISED STEEL/SS




NOTES

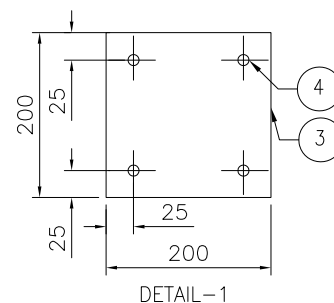- 1) ALL DIMENSION ARE IN 'mm' UNLESS OTHERWISE STATED.
- 2) TYPICAL ARRANGEMENT IS INDICATED IN THE DRAWING.
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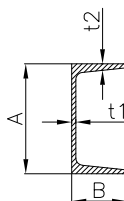
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Rev.	Date	Name		Date	Name	Date	Name	Description	Acc. Code		
Drawn/Prepared				Checked		Approved					
BAR-Code								Store Location: Server/Share			
								Store Location: Folder			
								Store Name PCTS6			
Pro. Unit				TON		Group		Type of Document		Sheet 1 / 1	
Con. Unit				Scale		Order No.					
								NTS			
								Description INSTALLATION STANDARDS – POWER TYPICAL DETAILS OF CABLE TRAY SUPPORTING IN CELLAR (PCTS6)			
Date		Name									
Drawn		19.07.2017 KRP									
Prepared		19.07.2017 MLD									
Checked		19.07.2017 RPM									
Approved		19.07.2017 RPM									

ISO A4


STANDARD STEEL SECTIONS : WEIGHT AND DIMENSIONS.

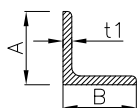

ISA (TYP)




ISMC (TYP)

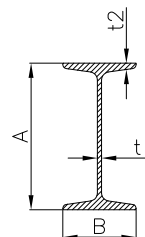

ISMB (TYP)

DESIGNATION	MASS (KG/M)	DIMENSIONS (MM)			
		A	B	t1	t2
ISA-50	4.5	50	50	6	—
ISA-65	5.8	65	65	6	—
ISA-75	6.8	75	75	6	—
ISMC-75	7.14	75	40	4.8	7.5
ISMC-100	9.56	100	50	5.0	7.7
ISMC-125	13.1	125	65	5.3	8.2
ISMC-150	16.8	150	75	5.7	9.0
ISMB-100	8.9	100	50	4.7	7.0
ISMB-125	13.3	125	70	5.0	8.0
ISMB-150	15.0	150	75	5.0	8.0


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
TYPICAL VIEW OF MS PLATE

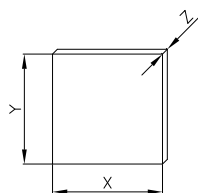WEIGHT (KG)	DIMENSIONS (MM)		
	X	Y	Z
0.79	100	100	10
1.77	150	150	10
0.59	1000	25	3



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BAR-Code	Drawing / Prepared		Checked	Approved	Code		
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	Store Location: Folder						
	Store Name _						
	Pro. Unit	TON		Group	Type of Document	Sheet 1 / 1	
Con. Unit	Scale NTS	Order No.		 thyssenkrupp			

	Date	Name	Description INSTALLATION STANDARDS – POWER STANDARD STEEL SECTIONS: WEIGHT & DIMENSIONS
Drawn	19.07.2017	KRP	
Prepared	19.07.2017	MLD	
Checked	19.07.2017	RPM	
Approved	19.07.2017	RPM	



Plant 1.0 MTPA ALUMINA REFINERY STREAM-5	Client NALCO	Contract Code NAL	Document ID 6695-ELT-G00-EC-0027	Contract No. 66-6695
	ELECTRICAL INSTALLATION PART- II - INSTALLATION DETAIL-EARTHING			नालको  NALCO नेशनल एल्युमिनियम कम्पनी लिमिटेड National Aluminium Company Ltd.
				Rev 0 Page 1 of 6

INSTALLATION DETAIL-EARTHING



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				Rev 0 Page 2 of 6

1. LIST OF INSTALLATION STANDARDS

Sr. No.	Description	Typical No.	Number of Sheets	Rev.
1	Main Earthing Grid conductor –Below ground typical layout	EEG1	1	0
2	Earthing conductor –Welding / Tapping details	EEG2	1	0
3	Earthing Riser from lower elevation to higher elevation details	EEG3	1	0
4	C-Connector for Round conductor	EEG4	1	0
5	Equipotential Bonding strip on concrete wall / column	EEB1	1	0
6	Equipotential Bonding strip on steel structure/column	EEB2	1	0
7	Equipotential Bonding strip on cable tray	EEB3	1	0
8	Insulated Equipotential Bonding strip on concrete wall / column	EEB4	1	0
9	Insulated Equipotential Bonding strip on steel structure/column	EEB5	1	0
10	Earthing conductor installed on cable tray	EET1	1	0
11	Earthing of Steel structure	ESS1	1	0
12	Bonding of Pipelines	EBP1	1	0
13	Earthing/Bonding of Pipelines and piperacks at tie in point	EBP2	1	0
14	Earthing of Mechanical Equipment (Tank,Vessel)	EME1	2	0
15	Earthing of Transformer with solidly Grounded Neutral	ETS1	1	0
16	Earthing of Transformer with Neutral grounding through NGR	ETN1	1	0
17	Earthing of DG SET	EDG1	1	0
18	Earthing of LV Motor on separate skid	EML1	1	0
19	Earthing of two LV Motor on common skid	EML2	1	0
20	Earthing of LV Motor on separate skid (above ground earthing)	EML3	1	0
21	Earthing of two LV Motor on common skid (above ground earthing)	EML4	1	0
22	Earthing of HV Motor	EMH1	1	0
23	Earthing of HV Motor (above ground earthing)	EMH2	1	0
24	Typical earth connection for street light pole	ESL1	1	0
25	Typical earth connection for street light pole with earth rod	ESL2	1	0
26	Earth bonding of cable trays	ETB1	1	0
27	Earth pit with HDGI pipe electrode for unpaved area	EEP1	1	0
28	Earth pit with deep rod electrode for unpaved area	EEP2	1	0
29	Earth pit with HDGI plate electrode for unpaved area	EEP3	1	0
30	Earth pit with CI plate electrode for unpaved area	EEP4	1	0
31	Earth pit with CI pipe electrode for unpaved area	EEP5	1	0
32	Earth pit with HDGI pipe electrode for paved area without forklift movement	EEP6	1	0
33	Earth pit with deep rod electrode for paved area without forklift movement	EEP7	1	0
34	Earth pit with HDGI plate electrode for paved area without forklift movement	EEP8	1	0
35	Earth pit with CI plate electrode for paved area without forklift movement	EEP9	1	0
36	Earth pit with CI pipe electrode for paved area without forklift movement	EEP10	1	0
37	Earth pit with HDGI pipe electrode for paved area with 2T capacity forklift movement	EEP11	1	0
38	Earth pit with deep rod electrode for paved area with 2T capacity forklift movement	EEP12	1	0
39	Earth pit with HDGI plate electrode for paved area with 2T capacity forklift movement	EEP13	1	0
40	Earth pit with CI plate electrode for paved area with 2T capacity forklift movement	EEP14	1	0

Plant 1.0 MTPA ALUMINA REFINERY STREAM-5	Client NALCO	Contract Code NAL	Document ID 6695-ELT-G00-EC-0027	Contract No. 66-6695
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				Rev 0 Page 3 of 6

Sr. No.	Description	Typical No.	Number of Sheets	Rev.
41	Earth pit with CI pipe electrode for paved area with 2T capacity forklift movement	EEP15	1	0
42	Earth Pit With Cu Plate Electrode for unpaved area (EEP16)	EEP16	1	0
43	Earth Pit With Cu Plate Electrode Without forklift movement for paved area	EEP17	1	0
44	Earth Pit With Cu Plate Electrode With 2t capacity forklift for paved area	EEP18	1	0
45	Standard Detail Of Earth Pit Chamber	PIN-LEP-CVC-1013	1	0

Plant 1.0 MTPA ALUMINA REFINERY STREAM-5	Client NALCO	Contract Code NAL	Document ID 6695-ELT-G00-EC-0027	Contract No. 66-6695		
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				Rev	0	Page

1. General:



- The documents/drawings as indicated below shall be prepared by the LSTK Contractor as a part of detail Engineering.
- These notes shall be read and construed in conjunction with Earthing Protection layout drawings and Installation Standards – Earthing.
- The resistance of the earth electrode system to the general body of earth must not exceed 1 Ohm.
- The voltage gradient in and near the substation should limit "touch" and "step" voltages to safe values as defined in IEEE 80.
- All metallic objects within the boundaries of the substation shall be bonded together by means of equipotential conductors.
- The earth electrode conductor shall be capable of carrying the maximum earth fault current continuously without overheating, mechanical damage or unduly drying the soil around buried conductors.
- Prior to design of the earthing system, an earth resistivity test shall be carried out. The test shall allow for the seasonal variation of the earth resistivity.
- Metallic fences erected to prevent unauthorised access to a substation shall be connected to the substation earth electrode system. A grading wire should be buried at a distance of 1 m outside the fence. The fence shall be bonded to the grading wire and to the substation earth electrode system.

2. Earth pits:

- Each earth pit shall be connected to earth grid/ bus through two numbers of main earthing conductors.
- Minimum 6000 mm spacing between plate/ pipe electrodes shall be provided.
- Clearance for construction of earth pit shall be obtained from Engineer-In-Charge before commencement of excavation. Civil and Mechanical groups shall be consulted.
- Earth pit designation identification shall be marked on the top cover. Further on bottom of the cover, earth pit designation identification with earth pit resistance and date of testing shall be marked.

3. Routing of earthing conductor:

- Underground buried earthing conductor shall be laid at least 600 mm below ground/ finished floor level. Earthing conductor shall be routed at least 1000 mm away from the building. Buried conductors shall be brought 500 mm above ground/ finished floor level for making further connections.
- All earthing conductors crossing road shall be routed through Hume pipes/ GI pipes. Wherever earthing conductor crosses drains, trenches or pipelines, it shall be laid minimum 300 mm below the same.
- Earthing conductor on concrete floor shall be routed below the screed (IPS) of the floor.
- Earthing cable/ conductor above ground shall preferably be routed in cable trays wherever available. Otherwise earthing cable/ conductor shall be routed on wall/ structure using GI spacers (min. 3 mm thick) and saddles (min. 2.5 mm thick) at interval of 300 mm.
- Wherever earthing conductor passes through walls, floors, etc., galvanized conduit sleeves shall be provided for the passage of the conductor. Both ends of the sleeve shall be sealed to prevent the passage of water through the sleeves. Water stops shall be provided wherever earthing conductor enters the building from outside, below grade level. Necessary sealing compound shall be supplied by Contractor as part of the installation rate.
- Wherever possible, all earthing conductors for electrical equipment shall be dressed/ clamped along with the power/ control cable for the equipment.



Plant 1.0 MTPA ALUMINA REFINERY STREAM-5	Client NALCO	Contract Code NAL	Document ID 6695-ELT-G00-EC-0027	Contract No. 66-6695		
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				Rev	0	Page

4. Equipment and structure earthing:

- Piperack and Building steel columns shall be earthed at every 20 meters (maximum). In case the height is greater than 20 meters, higher elevation shall also be earthed at every 20 meters.
- Walkways, railings and other steel parts located on the top of buildings and fastened to concrete structures shall be solidly connected to the earthing system at spacing's not to exceed 15 m. Concrete reinforcement and embedded hold-down bolts shall not be used as the sole means of earthing. All walkways and railings shall be electrically bonded throughout their complete length.
- Cable trays shall be earthed at every 50 meters on piperack (maximum). In general cable trays shall be earthed at start and end.
- Earthing continuity bonding across pipe line flanges shall be provided for pipe lines as indicated in the respective earthing drawings. These lines shall be bonded to nearby earth bus at flanged joints nearest to the two ends of each line and at intermediate joints at intervals not exceeding 50 meters.
- LCS & 1 phase socket (16A/ 20A) shall be earthed externally at one point.
- Equipment receiving single phase power supply such as light fixtures, socket (5A), ceiling/ exhaust fans, lighting junction boxes, etc. shall be earthed through third core of the power supply cable. No separate external earthing is required.
- Metallic screens, armour of all multicore MV cables shall be earthed at both ends. In general single core MV cables, armour/screen shall be earthed only at one end (source end); for long length of single core MV/ HV cables, vendor documentation shall be referred.
- Metallic screens, armour of all multicore LV cables shall be earthed at both ends through cable glands. For single core LV cables, armour/ screen shall be earthed only at one end (source end).
- EOT crane and other movable equipment fed from power conductor system shall be connected to earth through the PE conductor of the crane power supply cable & down shop lead. In addition, rails of monorail and crane shall also be earthed.
- Locations of earthing connections shown for equipment are indicative. Earthing conductor shall be laid and routed to match the orientation of the cleats on the equipment.
- Metallic conduits and pipes shall not be used as earth continuity conductor.
- Flexible earthing leads shall be provided for earthing the equipment on moving platforms.

5. Earthing connections:

- All contact surfaces shall be free from scale, paint, enamel, grease, rust or dirt before connection is made.
- All connections of earthing conductor shall be welded or bolted with appropriate hardware. In case of copper earthing conductor the same shall be brazed or bolted with Stain steel (SS 304) hardware.
- When wires are used as earth conductor same shall be connected by crimping type lugs. Tinned copper lugs shall be used in case of copper cables.
- Whether specifically shown in drawings or not, metallic stairs, hand-rails, etc, shall be connected to the nearby earthing grid by one earthing lead. Electrical continuity shall be ensured by bonding the different sections of hand-rails and metallic stairs.
- All underground bolted/ clamped & welded connections shall be protected against corrosion using tape/ bitumen compound.
- All welded joints shall be cleaned and applied with anti-corrosive treatment. Above ground welded joints shall be painted with two coats of primer and silver paint.
- Cutting of strip or drilling holes on strip shall be carried out using hack saw, drilling machines. Gas cutting is not permissible for the same.

Plant 1.0 MTPA ALUMINA REFINERY STREAM-5	Client NALCO	Contract Code NAL	Document ID 6695-ELT-G00-EC-0027	Contract No. 66-6695
 thyssenkrupp	ELECTRICAL INSTALLATION PART- II - INSTALLATION DETAIL-EARTHING			 नेशनल एल्युमिनियम कम्पनी लिमिटेड National Aluminium Company Ltd.
				Rev 0 Page 6 of 6

- h. Earth cleats for earthing of structural steel shall be welded on the steel column wherever the same are not available. The earth cleats shall be welded by the LSTK Contractor before the steel columns are fire proofed wherever applicable.

6. Special requirement:

- a. Since earthing is the major concern in hilly areas, due to long geographical terrain with high resistivity and large weather cycles, maintenance free chemical earthing shall be provided wherever required apart from standard earthing design.
- b. For all switchboards and transformers, chemical earthing system, if required, shall be considered instead of conventional earthing.

1	2	3	4		
ITEM	DESCRIPTION	MATERIAL	QTY.	SUPPLY BY	INSTALLATION BY
1	EARTHING CONDUCTOR	---	AS REQUIRED	ELECTRICAL CONTRACTOR	ELECTRICAL CONTRACTOR

A
B
C

CONCRETE/STEEL COLUMN

GRADE/FINISHED FLOOR LEVEL/COMPACTED GROUND

1000

600 (MIN.)

1

COLUMN FOOTING/FOUNDATION

DRAWING NOT TO SCALE


NOTES:

- 1) ALL DIMENSIONS ARE IN 'mm' UNLESS OTHERWISE SPECIFIED.
- 2) SIZE OF EARTHING CONDUCTOR SHALL BE AS PER THE 'EARTHING SCHEDULE' FOR THE PROJECT.
- 3) ALL UNDERGROUND WELDED CONNECTIONS SHALL BE PROTECTED AGAINST CORROSION USING TAPE OR BITUMEN COMPOUND.

Code		Contract No.		Document ID				Part		Rev.		
				PIN-LEP-ELT-4002						00		
00	29/10/15	RDK	ANK	29/10/15	RPM	29/10/15	RPM	ISSUED AS STANDARD		Cat. Code	Acc. Code	Status
Rev.	Date	Name		Date	Name		Date	Name		Acc. Code		
		Drawn/Prepared				Checked						
BAR-Code								Store Location: Server/Share				
								Store Location: Folder				
								Store Name				
								EEG1				
Pro. Unit		TON		Group		Type of Document		Sheet				
								1 / 1				
Con. Unit		Scale		Order No.								
		NTS										

ISO A4		Date	Name	Description INSTALLATION STANDARDS – EARTHING MAIN EARTHING GRID CONDUCTOR BELOW GROUND TYPICAL LAYOUT (EEG1)
	Drawn	29/10/15	RDK	
	Prepared	29/10/15	ANK	
	Checked	29/10/15	RPM	
	Approved	29/10/15	RPM	

1	2	3	4
← 50 mm →			
A			
B	<p style="text-align: center;">EARTHING CONDUCTORS</p> <p style="text-align: center;">WELD (TYP)</p> <p style="text-align: center;">WELD/TAPPING DETAILS</p>		
C	<p style="text-align: center;">EARTHING CONDUCTOR-1</p> <p style="text-align: center;">EARTHING CONDUCTOR-2</p> <p style="text-align: center;">WELD/TAPPING DETAILS</p>		
← 50 mm →			
<p>NOTES:</p> <ol style="list-style-type: none"> 1) WELDING SHALL BE DONE ON ALL SIDES OF EARTHING CONDUCTOR 2) AFTER WELDING SURFACE SHALL BE CLEANED AND APPLIED WITH ANTI-CORROSIVE TREATMENT (BITUMEN COMPOUND). 3) SIZE OF EARTHING CONDUCTOR SHALL BE AS PER THE 'EARTHING SCHEDULE' FOR THE PROJECT. 			
Code		Contract No.	
Document ID		Part	
PIN-LEP-ELT-4002		Rev. 00	
00	29/10/15	RDK	ANK
29/10/15	RPM	29/10/15	RPM
ISSUED AS STANDARD		Cat. Code	Acc. Code
Rev.	Date	Name	Status
Drawn/Prepared	Date	Name	Checked
Date	Name	Date	Approved
Description		Acc. Code	Status
Store Location: Server/Share		Store Location: Folder	
Store Name		Store Name	
EEG2		EEG2	
Pro. Unit	TON	Group	Type of Document
Sheet	1 / 1		
Con. Unit	Scale	Order No.	thyssenkrupp
NTS	thyssenkrupp		
Date		Name	
Drawn	29/10/15	RDK	
Prepared	29/10/15	ANK	
Checked	29/10/15	RPM	
Approved	29/10/15	RPM	
Description		Description	
INSTALLATION STANDARDS – EARTHING		INSTALLATION STANDARDS – EARTHING	
EARTHING CONDUCTOR		EARTHING CONDUCTOR	
WELDING / TAPPING DETAILS		WELDING / TAPPING DETAILS	
(EEG2)		(EEG2)	


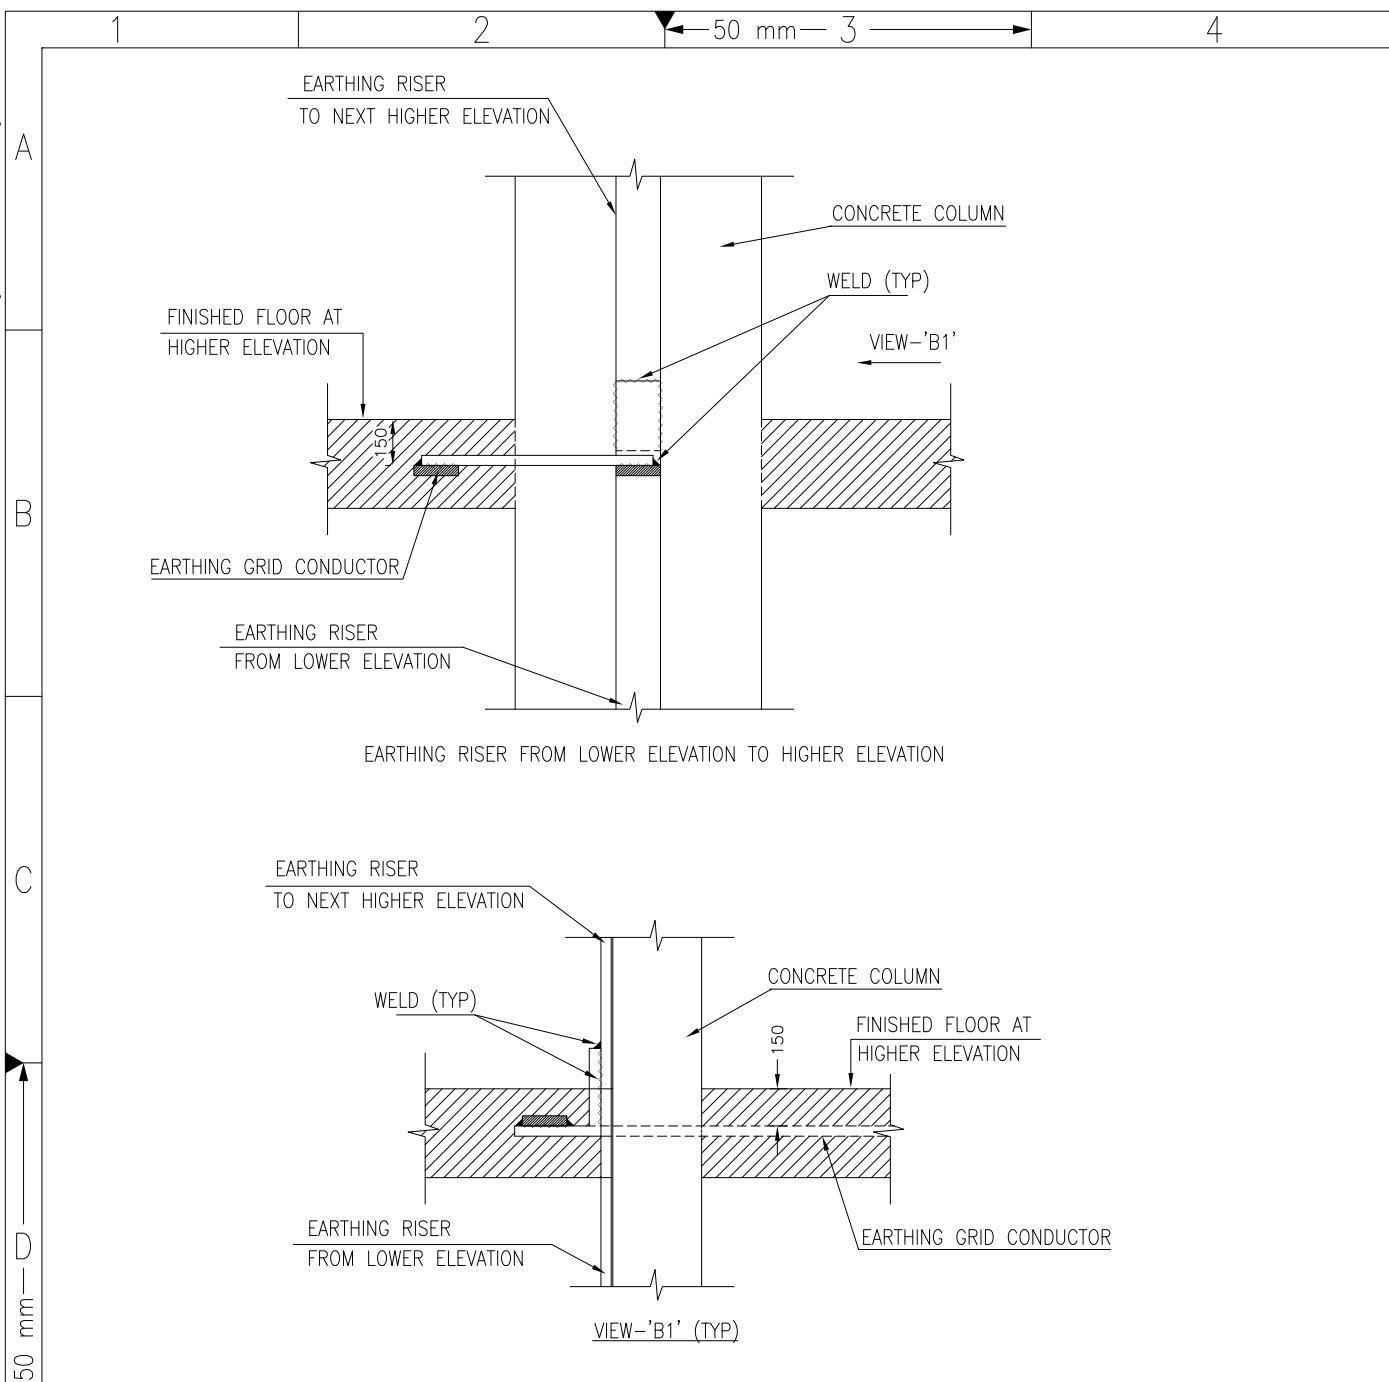




NOTES:

- 1) WELDING SHALL BE DONE ON ALL SIDES OF EARTHING CONDUCTOR
- 2) AFTER WELDING SURFACE SHALL BE CLEANED AND APPLIED WITH ANTI-CORROSIVE TREATMENT (BITUMEN COMPOUND).
- 3) SIZE OF EARTHING CONDUCTOR SHALL BE AS PER THE 'EARTHING SCHEDULE' FOR THE PROJECT.
- 4) EARTHING CONDUCTOR SHALL BE ROUTED USING SADDLES/CLAMPING AT INTERVAL OF 300mm.

Code		Contract No.		Document ID		PIN-LEP-ELT-4002		Part	Rev.
00	29/10/15	RDK	ANK	29/10/15	RPM	29/10/15	RPM	ISSUED AS STANDARD	00
Rev.	Date	Name	Date	Name	Date	Name	Description	Acc. Code	Status
		Drawn/Prepared		Checked		Approved			
BAR-Code							Store Location: Server/Share		
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Pro. Unit		TON		Group		Type of Document		Sheet	
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Con. Unit		Scale		Order No.					
		NTS							
Date		Name		Description					
Drawn		29/10/15 RDK		INSTALLATION STANDARDS – EARTHING					
Prepared		29/10/15 ANK		EARTHING RISER FROM LOWER ELEVATION					
Checked		29/10/15 RPM		TO HIGHER ELEVATION DETAILS					
Approved		29/10/15 RPM		(EEG3)					

1	2	3	4		
ITEM	DESCRIPTION	MATERIAL	QTY.	SUPPLY BY	INSTALLATION BY
1	C-CONNECTOR FOR ROUND CONDUCTOR	TINNED CU/ ALUMINUM	AS REQUIRED	ELECTRICAL CONTRACTOR	ELECTRICAL CONTRACTOR

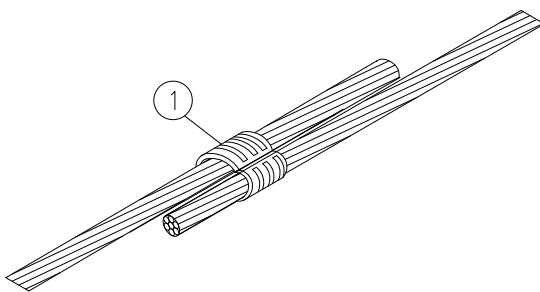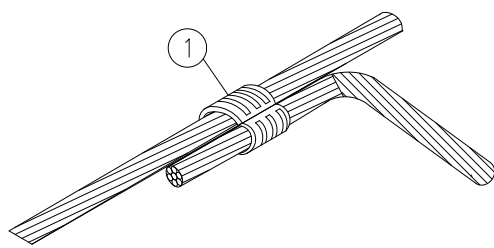DRAWING NOT TO SCALE

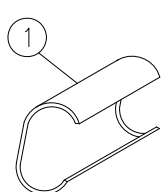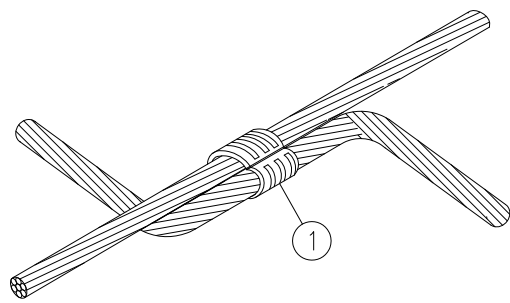NOTES

- 1) ALL DIMENSIONS ARE IN 'mm' UNLESS OTHERWISE SPECIFIED.
- 2) SIZE OF EARTHING CONDUCTORS SHALL BE AS PER THE 'EARTHING SCHEDULE' FOR THE PROJECT.
- 3) ALL SUCH CONNECTION BELOW GROUND SHALL BE PROTECTED WITH THE THE HELP OF CORROSION PROTECTION TAPE WITH BITUMEN COATING ABOVE

Code		Contract No.		Document ID		Part		Rev.	
00	04/01/17	KRP	PMT	04/01/17	RPM	04/01/17	RPM	PIN-LEP-ELT-4002	00
Rev.	Date	Name	Date	Name	Date	Name	Description	Acc. Code	Status
		Drawn/Prepared		Checked		Approved			

BAR-Code

Store Location: Server/Share


Store Location: Folder

Store Name EEG4

Pro. Unit TON Group Type of Document Sheet 1 / 1

Con. Unit Scale Order No.

NTS




	Date	Name
Drawn	04/01/17	KRP
Prepared	04/01/17	PMT
Checked	04/01/17	RPM
Approved	04/01/17	RPM

Description

INSTALLATION STANDARDS – EARTHING

C-CONNECTOR FOR ROUND CONDUCTOR (EEG4)

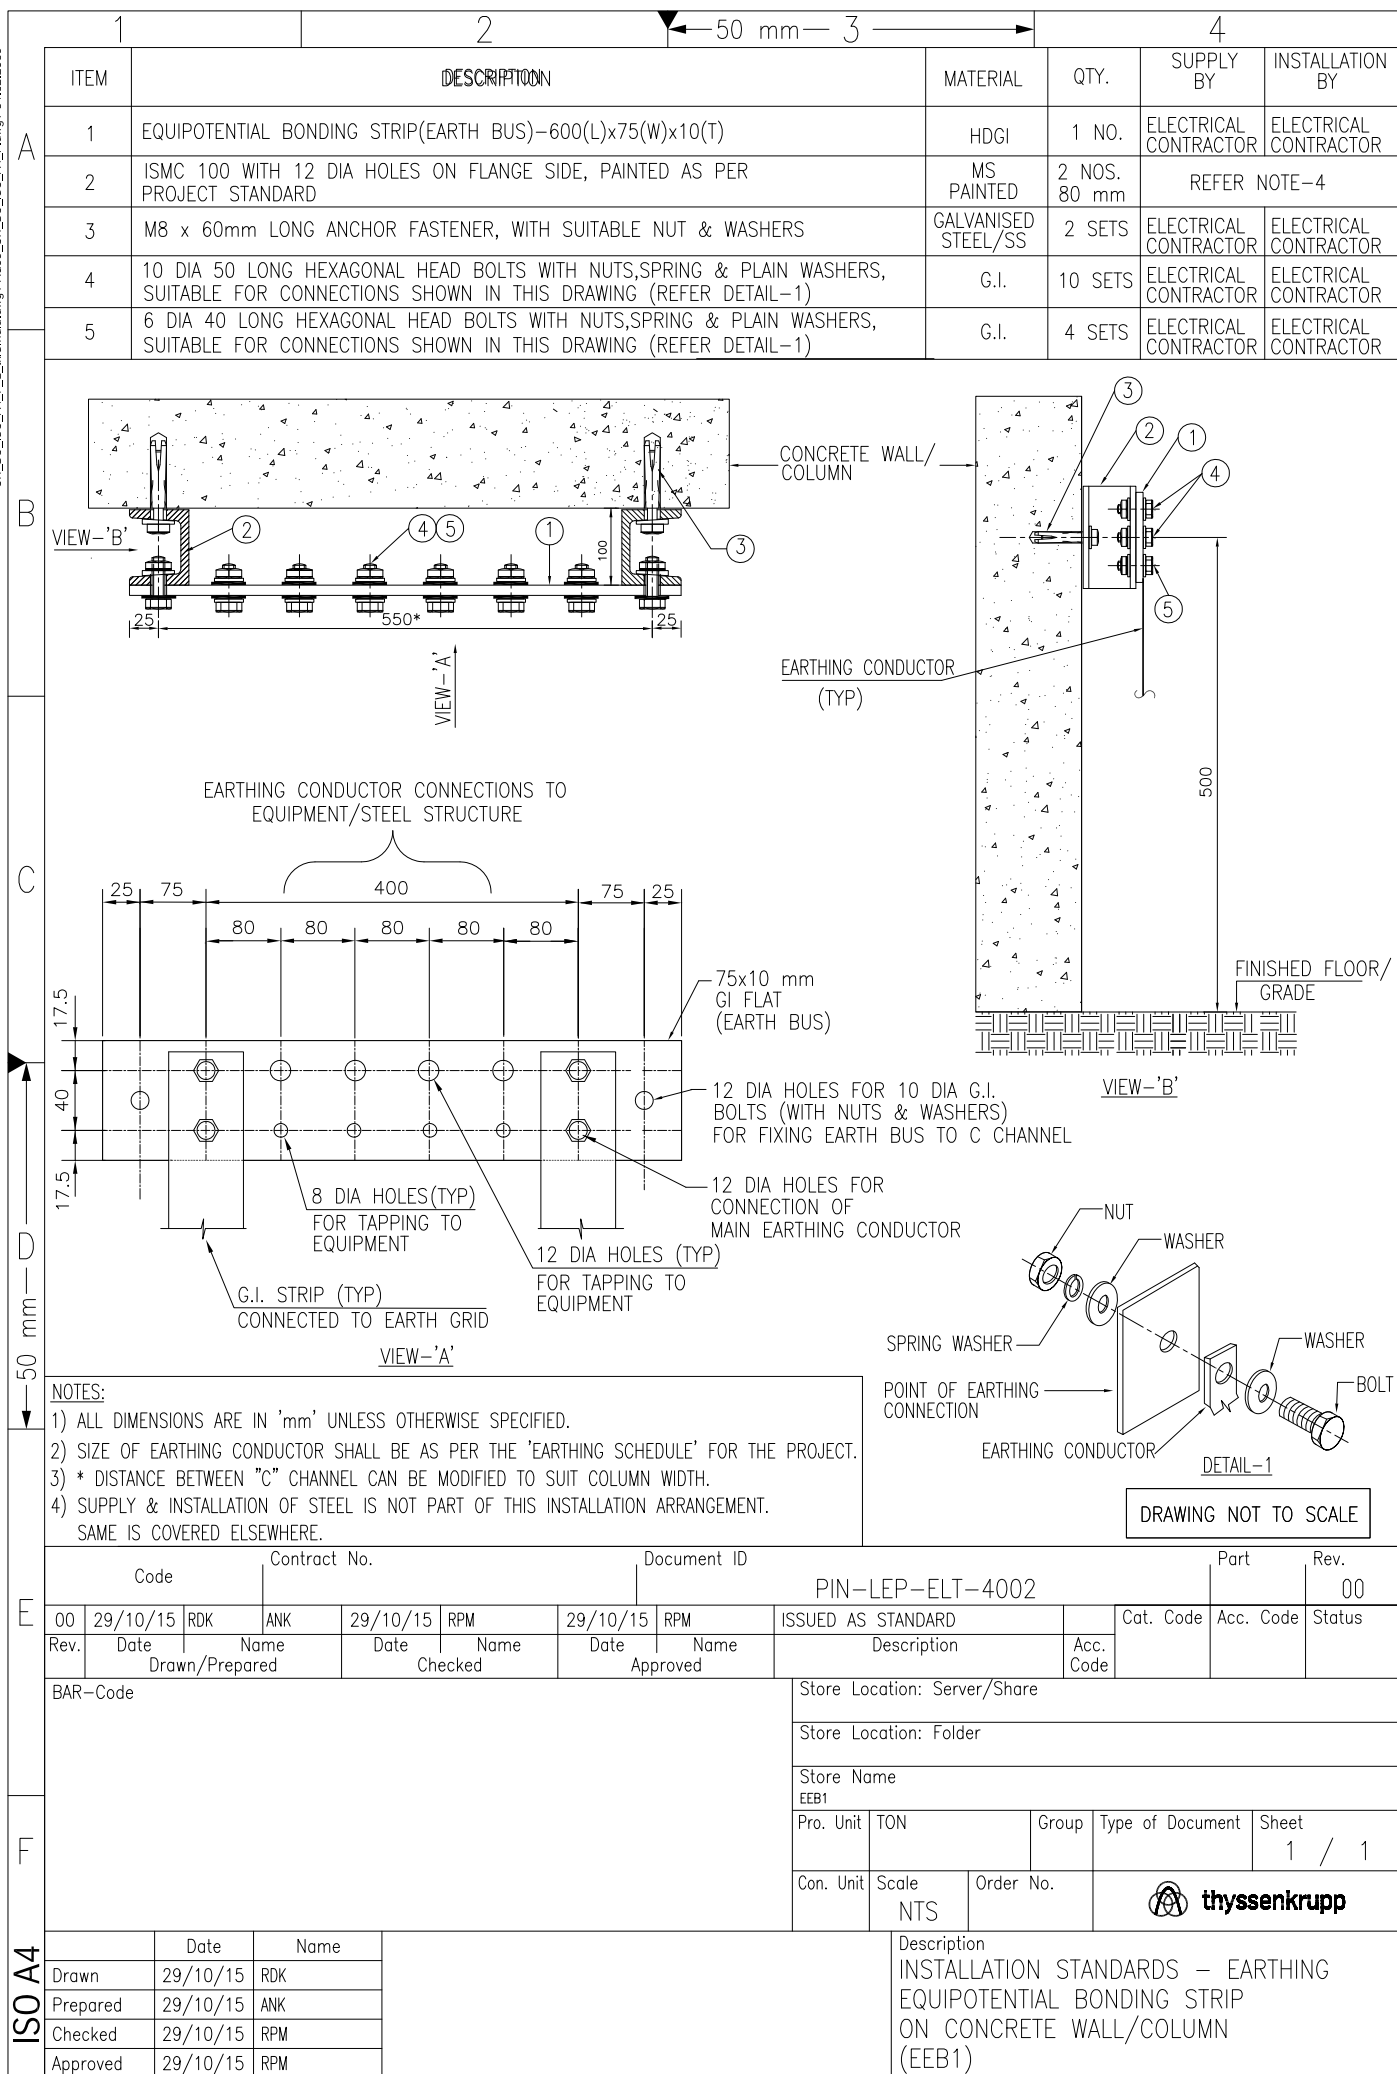

1	2	3	4
ITEM	DESCRIPTION	MATERIAL	QTY.
1	EQUIPOTENTIAL BONDING STRIP(EARTH BUS)-600(L)x75(W)x10(T)	HDGI	1 NO.
2	ISM 100 WITH 12 DIA HOLES ON FLANGE SIDE, PAINTED AS PER PROJECT STANDARD	MS PAINTED	2 NOS. 80 mm
3	10 DIA, 50 LONG HEXAGONAL HEAD BOLTS WITH NUTS, SPRING & PLAIN WASHERS, SUITABLE FOR CONNECTIONS SHOWN IN THIS DRAWING (REFER DETAIL-1)	G.I.	10 SETS
4	6 DIA, 40 LONG HEXAGONAL HEAD BOLTS WITH NUTS, SPRING & PLAIN WASHERS, SUITABLE FOR CONNECTIONS SHOWN IN THIS DRAWING (REFER DETAIL-1)	G.I.	4 SETS

VIEW - 'B'

VIEW - 'A'

DETAIL-1

DRAWING NOT TO SCALE

NOTES:

- 1) ALL DIMENSIONS ARE IN 'mm' UNLESS OTHERWISE SPECIFIED.
- 2) SIZE OF EARTHING CONDUCTOR SHALL BE AS PER THE 'EARTHING SCHEDULE' FOR THE PROJECT.
- 3) * DISTANCE BETWEEN "C" CHANNEL CAN BE MODIFIED TO SUIT COLUMN WIDTH.
- 4) ** INCASE OF FIREPROOFING REQUIREMENT EXTRA "C" CHANNEL ALONGWITH FIXING NUTBOLTS SHALL BE CONSIDERED.
- 5) SUPPLY & INSTALLATION OF STEEL IS NOT PART OF THIS INSTALLATION ARRANGEMENT. SAME IS COVERED ELSEWHERE.

Code		Contract No.		Document ID		Part		Rev.	
00	29/10/15	RDK	ANK	29/10/15	RPM	29/10/15	RPM	PIN-LEP-ELT-4002	
Rev.	Date	Name	Date	Name	Date	Name	Description	Acc. Code	Status
		Drawn/Prepared		Checked		Approved			

BAR-Code

Store Location: Server/Share

Store Location: Folder

Store Name

Pro. Unit TON Group Type of Document Sheet 1 / 1

Con. Unit Scale Order No.

ISO A4

	Date	Name
Drawn	29/10/15	RDK
Prepared	29/10/15	ANK
Checked	29/10/15	RPM
Approved	29/10/15	RPM

Description

INSTALLATION STANDARDS - EARTHING EQUIPOTENTIAL BONDING STRIP ON STEEL STRUCTURE/COLUMN (EEB2)

ITEM	DESCRIPTION	MATERIAL	QTY.	SUPPLY BY	INSTALLATION BY
1	EQUIPOTENTIAL BONDING STRIP(EARTH BUS)-600(L)x75(W)x10(T)	HDGI	1 NO.	ELECTRICAL CONTRACTOR	ELECTRICAL CONTRACTOR
2	10 DIA 50 LONG HEXAGONAL HEAD BOLTS WITH NUTS,SPRING WASHERS & WASHERS SUITABLE FOR CONNECTIONS SHOWN IN THIS DRAWING (REFER DETAIL-1)	G.I.	12 SETS	ELECTRICAL CONTRACTOR	ELECTRICAL CONTRACTOR
3	6 DIA 40 LONG HEXAGONAL HEAD BOLTS WITH NUTS,SPRING WASHERS & WASHERS SUITABLE FOR CONNECTIONS SHOWN IN THIS DRAWING (REFER DETAIL-1)	G.I.	4 SETS	ELECTRICAL CONTRACTOR	ELECTRICAL CONTRACTOR

VIEW - 'A'

VIEW - 'A'

DETAIL-1

NOTES

- ALL DIMENSIONS ARE IN 'mm' UNLESS OTHERWISE SPECIFIED.
- 75x10mm EARTHING CONDUCTOR SHALL BE FIXED ON THE CABLE TRAY RUNGS EITHER BY MEANS OF MUSHROOM HEAD SCREWS, AS SHOWN ABOVE, OR WITH CLAMPS AT AN INTERVAL NOT EXCEEDING 1 MTR.
- EQUIPOTENTIAL BONDING STRIPS ON CABLE TRAYS SHALL BE USED FOR TAPPING EARTHING CONNECTIONS FOR LV MOTORS AND OTHER POWER AND CONTROL EQUIPMENT.
- SIZE OF EARTHING CONDUCTOR SHALL BE AS PER THE 'EARTHING SCHEDULE' FOR THE PROJECT.

DRAWING NOT TO SCALE

Code	Contract No.	Document ID	PIN-LEP-ELT-4002	Part	Rev.
00	29/10/15 RDK	ANK	29/10/15 RPM	29/10/15 RPM	ISSUED AS STANDARD
Rev.	Date	Name	Date	Name	Description
	Drawn/Prepared	Checked	Approved		Acc. Code

BAR-Code

Store Location: Server/Share

Store Location: Folder

Store Name

EEB3

Pro. Unit TON Group Type of Document Sheet 1 / 1


Con. Unit Scale Order No.

	Date	Name
Drawn	29/10/15	RDK
Prepared	29/10/15	ANK
Checked	29/10/15	RPM
Approved	29/10/15	RPM

Description


INSTALLATION STANDARDS – EARTHING EQUIPOTENTIAL BONDING STRIP ON CABLE TRAY (EEB3)

ITEM	DESCRIPTION	MATERIAL	QTY.	SUPPLY BY	INSTALLATION BY
1	EQUIPOTENTIAL BONDING STRIP(EARTH BUS)-600(L)x75(W)x10(T)	HDGI/ TINNED Cu	1 NO.	ELECTRICAL CONTRACTOR	ELECTRICAL CONTRACTOR
2	ISM 100 WITH 12 DIA HOLES ON FLANGE SIDE, PAINTED AS PER PROJECT STANDARD	MS PAINTED	2 NOS. 80mm	REFER NOTE-4	
3	M8 x 60mm LONG ANCHOR FASTENER, WITH SUITABLE NUT & WASHERS	G.I.	2 NOS.	ELECTRICAL CONTRACTOR	ELECTRICAL CONTRACTOR
4	10 DIA 50 LONG HEXAGONAL HEAD BOLTS WITH NUTS, SPRING & PLAIN WASHERS, SUITABLE FOR CONNECTIONS SHOWN IN THIS DRAWING (REFER DETAIL-1)	G.I.	8 SETS	ELECTRICAL CONTRACTOR	ELECTRICAL CONTRACTOR
5	6 DIA 40 LONG HEXAGONAL HEAD BOLTS WITH NUTS, SPRING & PLAIN WASHERS, SUITABLE FOR CONNECTIONS SHOWN IN THIS DRAWING (REFER DETAIL-1)	G.I.	4 SETS	ELECTRICAL CONTRACTOR	ELECTRICAL CONTRACTOR
6	1.1 KV INSULATOR, MINIMUM HEIGHT 50 mm WITH 2 SETS OF BOLTS TO SUIT INSULATOR	-	2 NOS	ELECTRICAL CONTRACTOR	ELECTRICAL CONTRACTOR

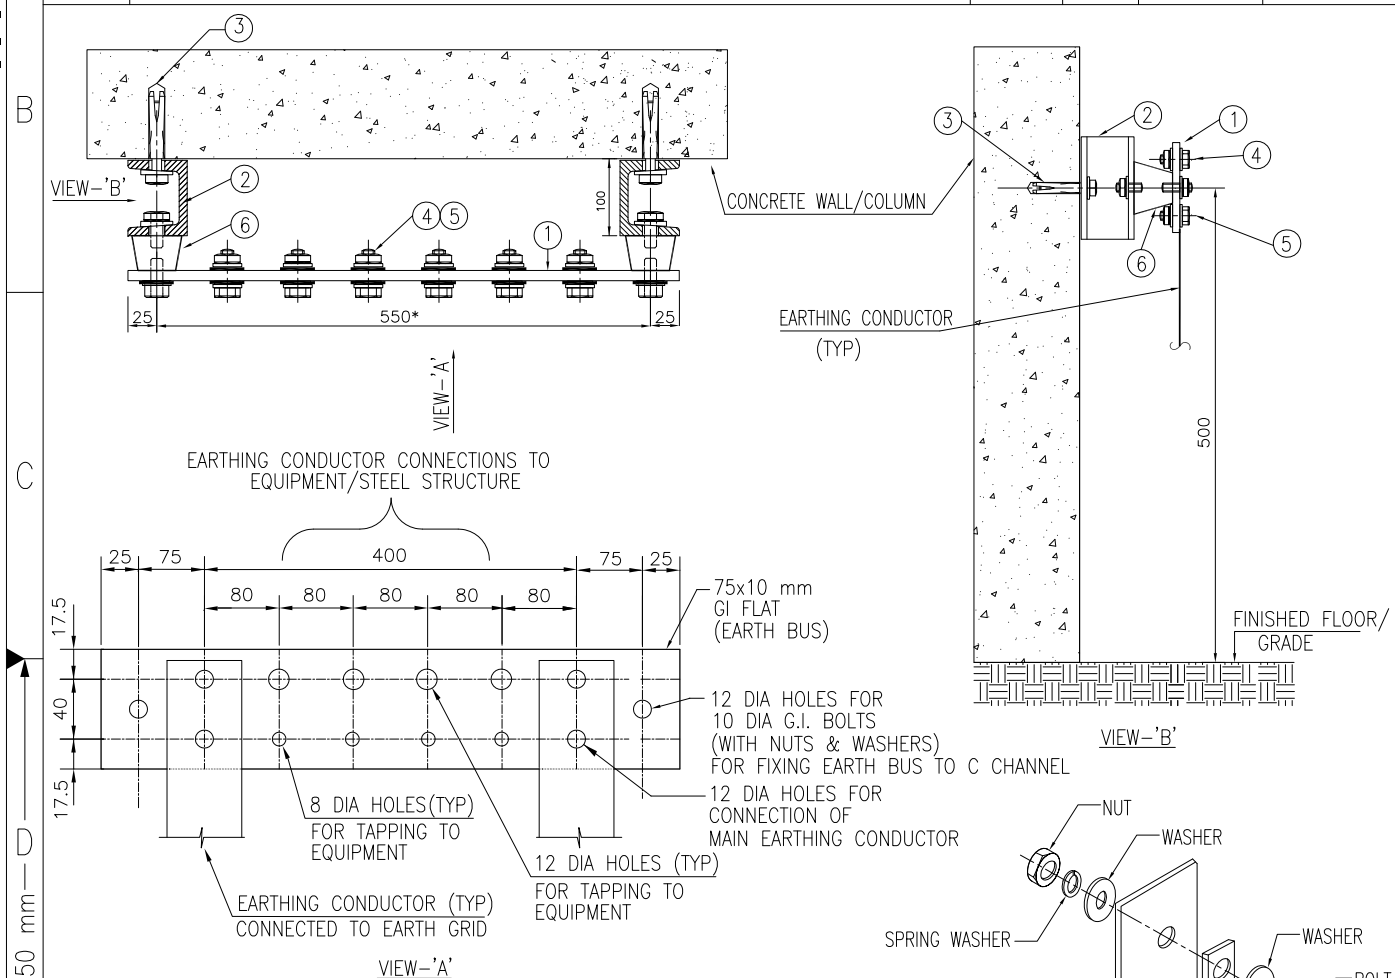

NOTES:

- 1) ALL DIMENSIONS ARE IN 'mm' UNLESS OTHERWISE SPECIFIED.
- 2) SIZE OF EARTHING CONDUCTOR SHALL BE AS PER THE 'EARTHING SCHEDULE' FOR THE PROJECT.
- 3) * DISTANCE BETWEEN "C" CHANNEL CAN BE MODIFIED TO SUIT COLUMN WIDTH.
- 4) SUPPLY & INSTALLATION OF STEEL IS NOT PART OF THIS INSTALLATION ARRANGEMENT. SAME IS COVERED ELSEWHERE.

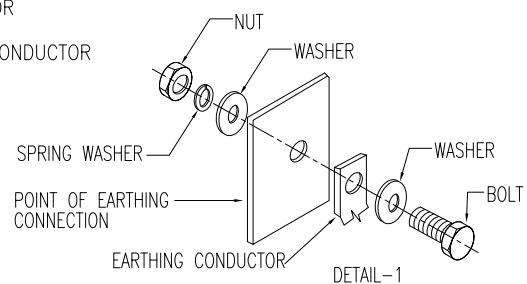


DRAWING NOT TO SCALE


ISO A4

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F

Code				Contract No.				Document ID				Part				Rev.	
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Rev.		Date		Name		Date		Name		Date		Name		Description		Acc. Code	
		Drawn/Prepared				Checked				Approved						Cat. Code	
BAR-Code												Store Location: Server/Share					
												Store Location: Folder					
												Store Name					
												EEB4					
Pro. Unit		TON				Group		Type of Document				Sheet					
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Con. Unit		Scale		Order No.													
		NTS				 thyssenkrupp											
		Date		Name		Description											
Drawn		29/10/15		RDK		INSTALLATION STANDARDS – EARTHING											
Prepared		29/10/15		ANK		INSULATED EQUIPOTENTIAL BONDING STRIP											
Checked		29/10/15		RPM		ON CONCRETE WALL/COLUMN											
Approved		29/10/15		RPM		(EEB4)											

ITEM	DESCRIPTION	MATERIAL	QTY.	SUPPLY BY	INSTALLATION BY
1	EQUIPOTENTIAL BONDING STRIP(EARTH BUS)-600(L)x75(W)x10(T)	HDGI/ Tinned Cu	1 NO.	ELECTRICAL CONTRACTOR	ELECTRICAL CONTRACTOR
2	ISMC 100 WITH 12 DIA HOLES ON FLANGE SIDE, PAINTED AS PER PROJECT STANDARD	MS PAINTED	2 NOS. 80 mm	REFER NOTE-5	
3	10 DIA 50 LONG HEXAGONAL HEAD BOLTS WITH NUTS,SPRING & PLAIN WASHERS, SUITABLE FOR CONNECTIONS SHOWN IN THIS DRAWING (REFER DETAIL-1)	G.I.	8 SETS	ELECTRICAL CONTRACTOR	ELECTRICAL CONTRACTOR
4	6 DIA 40 LONG HEXAGONAL HEAD BOLTS WITH NUTS,SPRING & PLAIN WASHERS, SUITABLE FOR CONNECTIONS SHOWN IN THIS DRAWING (REFER DETAIL-1)	G.I.	4 SETS	ELECTRICAL CONTRACTOR	ELECTRICAL CONTRACTOR
5	1.1 KV INSULATOR, MINIMUM HEIGHT 50 mm WITH 2 SETS OF BOLTS TO SUIT INSULATOR	G.I.	2 NOS	ELECTRICAL CONTRACTOR	ELECTRICAL CONTRACTOR

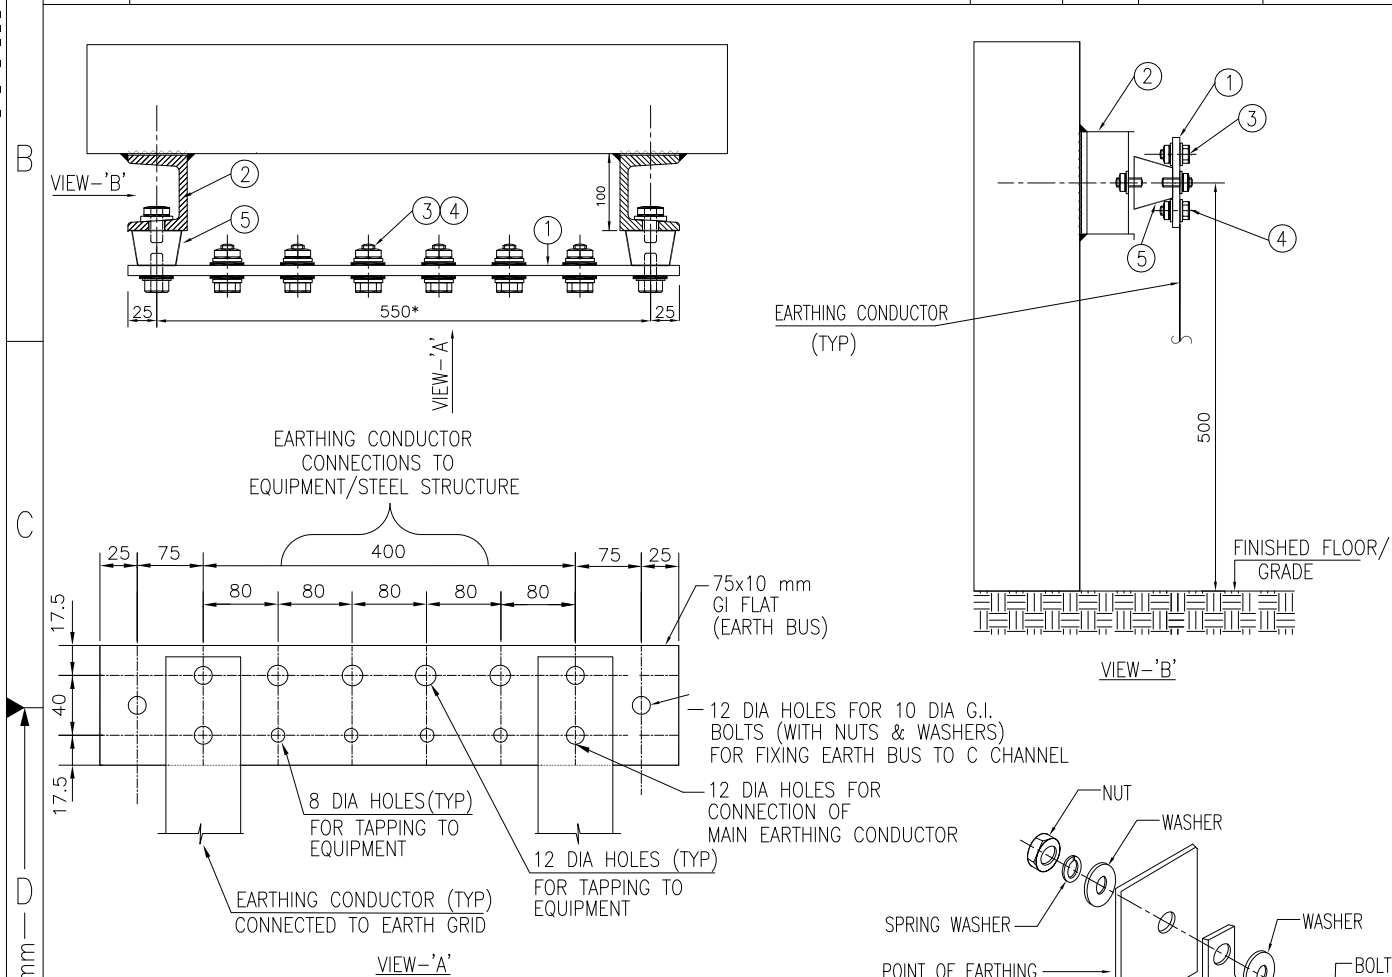


NOTES:

- 1) ALL DIMENSIONS ARE IN 'mm' UNLESS OTHERWISE SPECIFIED.
- 2) SIZE OF EARTHING CONDUCTOR SHALL BE AS PER THE 'EARTHING SCHEDULE' FOR THE PROJECT.
- 3) * DISTANCE BETWEEN "C" CHANNEL CAN BE MODIFIED TO SUIT COLUMN WIDTH.
- 4) ** INCASE OF FIREPROOFING REQUIREMENT EXTRA "C" CHANNEL ALONGWITH FIXING NUTBOLTS SHALL BE CONSIDERED.
- 5) SUPPLY & INSTALLATION OF STEEL IS NOT PART OF THIS INSTALLATION ARRANGEMENT. SAME IS COVERED ELSEWHERE.


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F	Rev.		Date		Date		Description		Acc. Code	
	29/10/15		RDK		29/10/15		RPM		Status	
ISO A4	BAR-Code		Store Location: Server/Share		Store Location: Folder		Store Name		Pro. Unit	
	EEB5		TON		Group		Type of Document		Sheet	
ISO A4	Con. Unit		Scale		Order No.		thysenkrupp		1 / 1	
	Date		Name		Description		INSTALLATION STANDARDS - EARTHING INSULATED EQUIPOTENTIAL BONDING STRIP ON STEEL STRUCTURE/COLUMN (EEB5)			
ISO A4	Drawn		29/10/15		RDK					
	Prepared		29/10/15		ANK					
ISO A4	Checked		29/10/15		RPM					
	Approved		29/10/15		RPM					

1		2				3		4			
ITEM	DESCRIPTION					MATERIAL	QTY.	SUPPLY BY	INSTALLATION BY		
1	EARTHING CONDUCTOR AS PER EARTHING SCHEDULE					—	AS REQUIRED	ELECTRICAL CONTRACTOR	ELECTRICAL CONTRACTOR		
2	MUSHROOM HEAD BOLT M10 X 50mm LONG, THREADS UPTO HEAD, WITH NUTS & WASHERS SUITABLE FOR CONNECTIONS SHOWN IN THIS DRAWING					H.D.G.I.	AS REQUIRED	ELECTRICAL CONTRACTOR	ELECTRICAL CONTRACTOR		

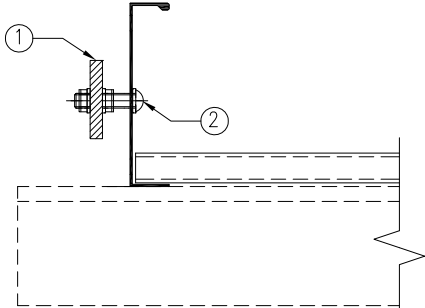

SECTION A-A

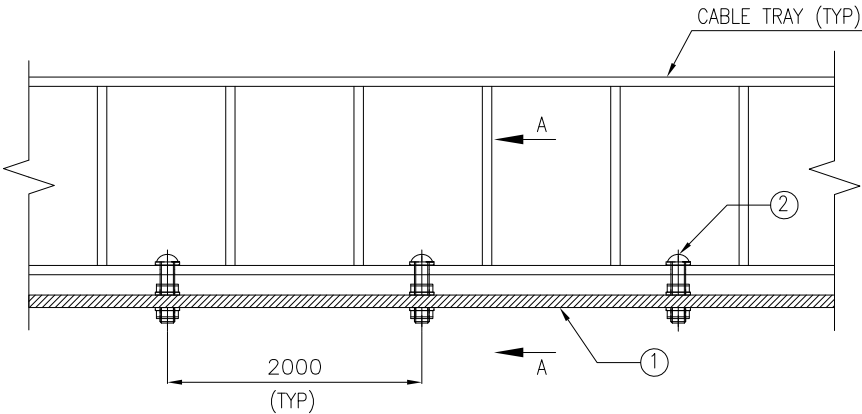


PLAN VIEW

DRAWING NOT TO SCALE

NOTES

1) ALL DIMENSIONS ARE IN 'mm' UNLESS OTHERWISE SPECIFIED.

Code		Contract No.		Document ID				Part		Rev.	
00	03/08/17	KRP	MLD	03/08/17	RPM	03/08/17	RPM	PIN-LEP-ELT-4002		00	
Rev.	Date	Name		Date	Name	Date	Name	ISSUED AS STANDARD	Cat. Code	Acc. Code	
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		Con. Unit		Scale NTS		Order No.		 thyssenkrupp			

ISO A4

	Date	Name
Drawn	03/08/17	KRP
Prepared	03/08/17	MLD
Checked	03/08/17	RPM
Approved	03/08/17	RPM

Description

INSTALLATION STANDARDS – EARTHING
EARTHING CONDUCTOR INSTALLED
ON CABLE TRAY
(EET1)

1	2	3	4	5	6
ITEM	DESCRIPTION	MATERIAL	QTY.	SUPPLY BY	INSTALLATION BY
1	ISMC 100 WITH 12 DIA HOLES ON FLANGE SIDE, PAINTED AS PER PROJECT STANDARD	MS PAINTED	1 NO. 80 mm	REFER NOTE-3	
2	EARTHING CONDUCTOR. SIZE OF EARTHING CONDUCTOR & MATERIAL SHALL BE AS PER THE 'EARTHING SCHEDULE' FOR THE PROJECT.		0.5 MTRS	ELECTRICAL CONTRACTOR	ELECTRICAL CONTRACTOR
3	EARTHING STUB-UP - STRIP, WITH 1 NO. 12 DIA HOLE SIZE SHALL BE AS PER THE 'EARTHING SCHEDULE' FOR THE PROJECT.	HDGI	1 NO.	PIPING CONTRACTOR	PIPING CONTRACTOR
4	HEXAGONAL HEAD BOLTS-40mm LONG, WITH NUTS & WASHERS SUITABLE FOR CONNECTIONS SHOWN IN THIS DRAWING (REFER DETAIL-1)	GI	2 SETS	ELECTRICAL CONTRACTOR	ELECTRICAL CONTRACTOR
5	CABLE LUG SUITABLE FOR THE CABLE		2 NOS.	ELECTRICAL CONTRACTOR	ELECTRICAL CONTRACTOR
6	CLAMPING ARRANGEMENT SUITABLE FOR EARTHING CONDUCTOR WITH REQUIRED HARDWARE		1 LOT.	ELECTRICAL CONTRACTOR	ELECTRICAL CONTRACTOR

VIEW - 'A'

STEEL STRUCTURE/COLUMN
WELD (TYP)

WELD (TYP)

FINISHED FLOOR/GRADE

TO NEAREST EARTHING GRID

VIEW - 'A'

NUT
WASHER
SPRING WASHER
POINT OF EARTHING CONNECTION
EARTHING CONDUCTOR
WASHER
BOLT

DETAIL-1

DRAWING NOT TO SCALE

NOTES:

- ALL DIMENSIONS ARE IN 'mm' UNLESS OTHERWISE SPECIFIED.
- STEEL STRUCTURES viz. PIPERACK & BUILDING COLUMNS SHALL BE EARTHED AT AN INTERVAL AS PER THE 'EARTHING SCHEDULE' FOR THE PROJECT.
- SUPPLY & INSTALLATION OF STEEL IS NOT PART OF THIS INSTALLATION ARRANGEMENT. SAME IS COVERED ELSEWHERE.

Document ID PIN-LEP-ELT-4002

Part 00

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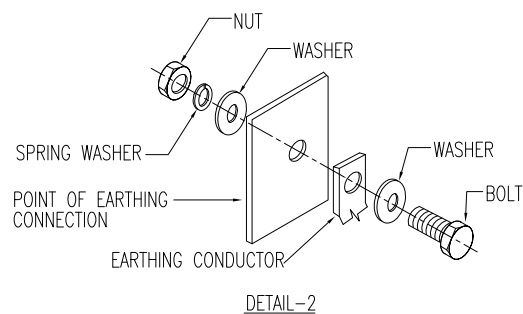
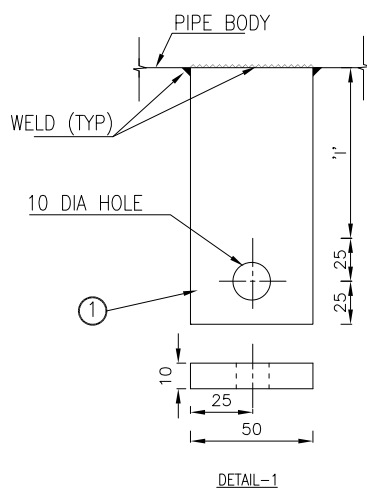
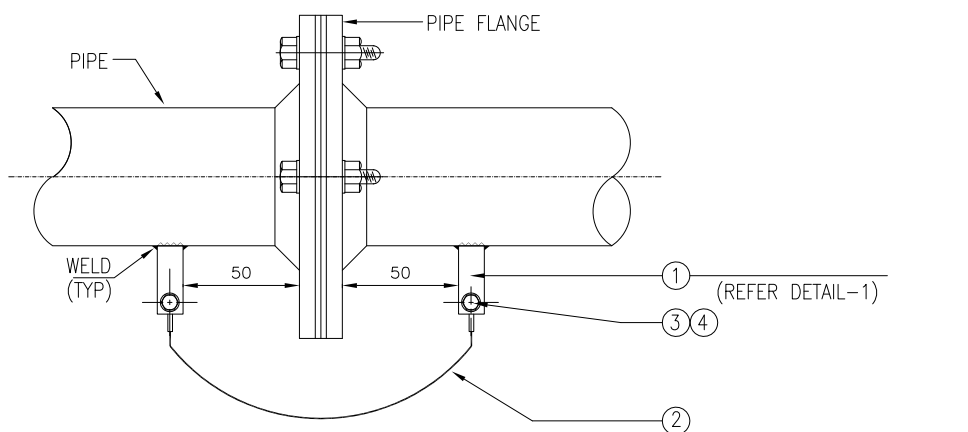
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Rev.	Date	Name	Date	Name
	Drawn/Prepared	Checked	Approved	Description

Store Location	Store Name	Pro. Unit	TON	Group	Type of Document	Sheet
Store Location: Server/Share	ESS1	TON				1 / 1
Store Location: Folder		Con. Unit	Scale	Order No.		

Date	Name	Description
29/10/15	RDK	INSTALLATION STANDARDS - EARTHING EARTHING OF STEEL STRUCTURE (ESS1)
29/10/15	ANK	
29/10/15	RPM	
29/10/15	RPM	

thyssenkrupp

ITEM	DESCRIPTION	MATERIAL	QTY.	SUPPLY BY	INSTALLATION BY
1	EARTHING CLEAT-[$'i'+50$](L)x50(W)x10(T), WITH 1NO. 10 DIA HOLE, ' i '=INSULATION THICKNESS	SAME AS PIPELINE	2 NOS.	CLIENT/PIPING CONTRACTOR	PIPING CONTRACTOR
2	EARTHING CONDUCTOR. SIZE OF EARTHING CONDUCTOR & MATERIAL SHALL BE AS PER THE 'EARTHING SCHEDULE' FOR THE PROJECT.	-	0.4 MTRS	ELECTRICAL CONTRACTOR	ELECTRICAL CONTRACTOR
3	HEXAGONAL HEAD BOLTS-25mm LONG, WITH NUTS & WASHERS SUITABLE FOR CONNECTIONS SHOWN IN THIS DRAWING (REFER DETAIL-2)	GI	2 SETS	ELECTRICAL CONTRACTOR	ELECTRICAL CONTRACTOR
4	CABLE LUG SUITABLE FOR THE CABLE	-	2 NOS.	ELECTRICAL CONTRACTOR	ELECTRICAL CONTRACTOR




DRAWING NOT TO SCALE

NOTE:

1) ALL DIMENSIONS ARE IN 'mm' UNLESS OTHERWISE SPECIFIED.


Code		Contract No.		Document ID				Part		Rev.		
				PIN-LEP-ELT-4002						00		
00	29/10/15	RDK	ANK	29/10/15	RPM	29/10/15	RPM	ISSUED AS STANDARD		Cat. Code	Acc. Code	Status
Rev.	Date	Name		Date	Name	Date	Name	Description	Acc. Code			
BAR-Code								Store Location: Server/Share				
								Store Location: Folder				
								Store Name				
								EBP1				
Pro. Unit				TON		Group		Type of Document		Sheet		
										1 / 1		
Con. Unit				Scale		Order No.						
				NTS				Description INSTALLATION STANDARDS - EARTHING BONDING OF PIPELINES (EBP1)				
Date		Name										
Drawn		29/10/15		RDK								
Prepared		29/10/15		ANK								
Checked		29/10/15		RPM								
Approved		29/10/15		RPM								

ITEM	DESCRIPTION	MATERIAL	QTY.	SUPPLY BY	INSTALLATION BY
1	25X3mm GI STRAPPING CLAMP SUITABLE FOR RESPECTIVE PIPE SIZE (REFER NOTE-4)	GI	AS REQUIRED	PIPING CONTRACTOR	PIPING CONTRACTOR
2	EARTHING CONDUCTOR-16mm ² , PVC INSULATED, GREEN/YELLOW CABLE	ALUMINIUM	AS REQUIRED	ELECTRICAL CONTRACTOR	ELECTRICAL CONTRACTOR
3	8 DIA HEXAGONAL HEAD BOLTS-50mm LONG, WITH NUTS & WASHERS SUITABLE FOR CONNECTIONS SHOWN IN THIS DRAWING (REFER VIEW-A & DETAIL-2)	GI	AS REQUIRED	ELECTRICAL CONTRACTOR	ELECTRICAL CONTRACTOR
4	CABLE LUG SUITABLE FOR THE CABLE	AL	AS REQUIRED	ELECTRICAL CONTRACTOR	ELECTRICAL CONTRACTOR
5	EARTHING CLEAT, WITH 1NO. 10 DIA HOLE (DETAIL3)	-	AS REQUIRED	ELECTRICAL CONTRACTOR	ELECTRICAL CONTRACTOR

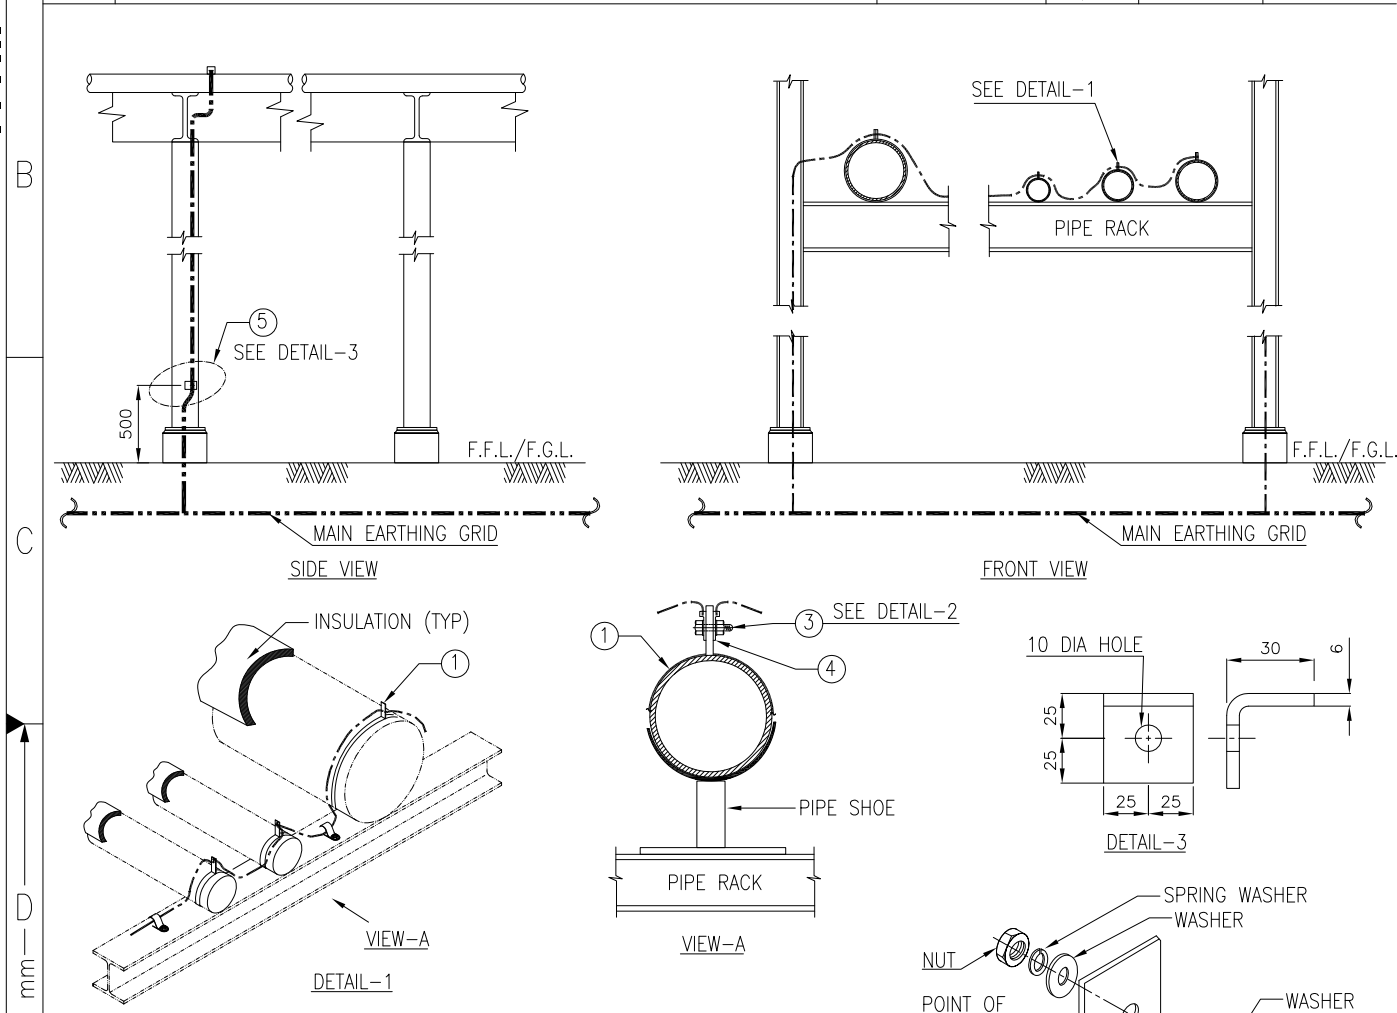

NOTES:

- 1) ALL DIMENSIONS ARE IN 'mm' UNLESS OTHERWISE SPECIFIED.
- 2) THE PIPE LINES SHALL BE BONDED AND EARTHED ONLY AT THE ENTRY EXIT POINTS OF BATTERY LIMIT OF PROCESS UNIT AS PER PROJECT SPECIFIC REQUIREMENT
- 3) STEEL PIPE RACKS SHALL BE EARTHED AT AN INTERVAL AS PER THE EARTHING SCHDEULE OF PROJECT.
- 4) GI STRAPS SHALL BE SELECTED APPROPRIATELY CONSIDERING INSULATION THICKNESS. CONNECTION POINT FOR EARTHING CABLE SHALL BE ACCESSIBLE AFTER INSULATION WRAPPING

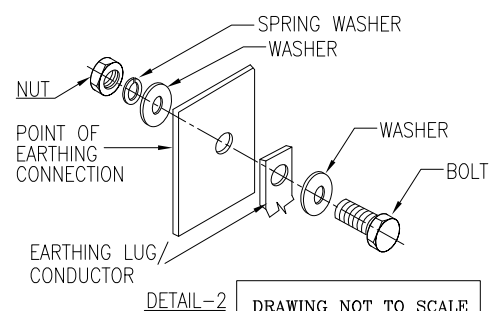

DRAWING NOT TO SCALE

Code		Contract No.		Document ID		Part		Rev.	
00		29/10/15 RDK		29/10/15 RPM		PIN-LEP-ELT-4002		00	
Rev.	Date	Name	Date	Name	Date	Name	Description	Acc. Code	Status
	29/10/15	RDK	29/10/15	RPM	29/10/15	RPM	ISSUED AS STANDARD		
BAR-Code							Store Location: Server/Share		
							Store Location: Folder		
							Store Name		
							EBP2		
							Pro. Unit		
							TON		
							Group		
							Type of Document		
							Sheet		
							1 / 1		
							Con. Unit		
							Scale		
							NTS		
							Order No.		
							thysenkruupp		
							Description		
							INSTALLATION STANDARDS - EARTHING		
							EARTHING / BONDING OF PIPELINES AND		
							PIPE RACKS AT TIE IN POINT		
							(EBP2)		

	Date	Name
Drawn	29/10/15	RDK
Prepared	29/10/15	ANK
Checked	29/10/15	RPM
Approved	29/10/15	RPM

ISO A4

ITEM	DESCRIPTION	MATERIAL	QTY.	SUPPLY BY	INSTALLATION BY
1	EARTHING CLEAT-[('I'+50)(L)x50(W)x10(T), WITH 1NO. 12 DIA HOLE, 'I'=INSULATION THICKNESS	SAME AS EQUIPMENT	'X' NOS. (*X'=AS PER TABLE-1)	ELECTRICAL CONTRACTOR	ELECTRICAL CONTRACTOR
2	EARTHING CONDUCTOR. SIZE OF EARTHING CONDUCTOR & MATERIAL SHALL BE AS PER THE 'EARTHING SCHEDULE' FOR THE PROJECT.	ALUMINIUM	AS REQUIRED	ELECTRICAL CONTRACTOR	ELECTRICAL CONTRACTOR
3	EARTHING STUB-UP - STRIP, WITH 1 NO. 12 DIA HOLE SIZE SHALL BE AS PER THE 'EARTHING SCHEDULE' FOR THE PROJECT.	HDOI	'X' NOS.	ELECTRICAL CONTRACTOR	ELECTRICAL CONTRACTOR
4	10 DIA HEXAGONAL HEAD BOLTS-50mm LONG, WITH NUTS & WASHERS SUITABLE FOR CONNECTIONS SHOWN IN THIS DRAWING (REFER DETAIL-2)	GI	2 x 'X' SETS	ELECTRICAL CONTRACTOR	ELECTRICAL CONTRACTOR
5	CABLE LUG SUITABLE FOR THE CABLE	AL	2 x 'X' SETS	ELECTRICAL CONTRACTOR	ELECTRICAL CONTRACTOR

TABLE-1:-

EQUIPMENT DIMENSION ('D' OR 'H')	NUMBER OF EARTHING CLEATS
< 20 MTRS	2 NOS. AT 180deg
>=20<30 MTRS	3 NOS. AT 120deg
>=30 MTRS	4 NOS. AT 90deg

DETAIL-1

DETAIL-1

DRAWING NOT TO SCALE

NOTES:

- ALL DIMENSIONS ARE IN 'mm' UNLESS OTHERWISE SPECIFIED.
- QUANTITY AND ORIENTATION OF EARTHING CLEATS ON MECHANICAL EQUIPMENT/INTEGRAL EQUIPMENT SUPPORTS SHALL BE MARKED BY ELECTRICAL GROUP ON THE EQUIPMENT FABRICATION/NOZZLE ORIENTATION DRAWINGS. CO-ORDINATION TO BE DONE WITH MECHANICAL/PIPING GROUP FOR THE SAME.

Code		Contract No.		Document ID		Part		Rev.	
00	29/10/15	RDK	ANK	29/10/15	RPM	29/10/15	RPM	ISSUED AS STANDARD	00
Rev.	Date	Name		Date	Name	Date	Name	Description	Acc. Code
		Drawn/Prepared			Checked		Approved		

BAR-Code

Store Location: Server/Share

Store Location: Folder

Store Name

Pro. Unit TON Group Type of Document Sheet 1 / 2

Con. Unit Scale Order No.

thysenkruupp

Date	Name	Description
Drawn	29/10/15	RDK
Prepared	29/10/15	ANK
Checked	29/10/15	RPM
Approved	29/10/15	RPM

DESCRIPTION
INSTALLATION STANDARDS - EARTHING
EARTHING OF MECHANICAL EQUIPMENT
(TANK, VESSEL)
(EME1)

ITEM	DESCRIPTION	MATERIAL	QTY.	SUPPLY BY	INSTALLATION BY
1	EARTHING CLEAT-100(L)x50(W)x10(T), WITH 1 NO. 12 DIA HOLE	SAME AS EQUIPMENT SUPPORT	'X' NOS. (*X'=AS PER TABLE-1)	ELECTRICAL CONTRACTOR	ELECTRICAL CONTRACTOR
2	EARTHING CONDUCTOR. SIZE OF EARTHING CONDUCTOR & MATERIAL SHALL BE AS PER THE 'EARTHING SCHEDULE' FOR THE PROJECT.	ALUMINIUM	AS REQUIRED	ELECTRICAL CONTRACTOR	ELECTRICAL CONTRACTOR
3	EARTHING STUB-UP - STRIP, WITH 1 NO. 12 DIA HOLE SIZE SHALL BE AS PER THE 'EARTHING SCHEDULE' FOR THE PROJECT.	HDOI	'X' NOS.	ELECTRICAL CONTRACTOR	ELECTRICAL CONTRACTOR
4	10 DIA HEXAGONAL HEAD BOLTS-50mm LONG, WITH NUTS & WASHERS SUITABLE FOR CONNECTIONS SHOWN IN THIS DRAWING (REFER DETAIL-2)	GI	2 x 'X' SETS	ELECTRICAL CONTRACTOR	ELECTRICAL CONTRACTOR
5	CABLE LUG SUITABLE FOR THE CABLE	AL	2 x 'X' SETS	ELECTRICAL CONTRACTOR	ELECTRICAL CONTRACTOR

MECHANICAL EQUIPMENT

METALLIC EQUIPMENT SUPPORT (TYP)

FINISHED FLOOR/GRADE

TO NEAREST EARTHING GRID

TO NEAREST EARTHING GRID

100

25

12 DIA HOLE

WELD (TYP)

25

10

50

1

EQUIPMENT SUPPORT

DETAIL-1

EQUIPMENT DIMENSION ('L')	NUMBER OF EARTHING CLEATS (X)
< 20 MTRS	2 NOS. *
>=20 MTRS	4 NOS. *

* SHALL BE DIAMETRICALLY OPPOSITE

TABLE-1:-

NUT

WASHER

SPRING WASHER

POINT OF EARTHING CONNECTION

EARTHING CONDUCTOR

DETAIL-1

WASHER

BOLT

DRAWING NOT TO SCALE

NOTES:

1) ALL DIMENSIONS ARE IN 'mm' UNLESS OTHERWISE SPECIFIED.

2) QUANTITY AND ORIENTATION OF EARTHING CLEATS ON MECHANICAL EQUIPMENT/INTEGRAL EQUIPMENT SUPPORTS SHALL BE MARKED BY ELECTRICAL GROUP ON THE EQUIPMENT FABRICATION/NOZZLE ORIENTATION DRAWINGS. CO-ORDINATION TO BE DONE WITH MECHANICAL/PIPING GROUP FOR THE SAME.

Code	Contract No.	Document ID	Part	Rev.
00	29/10/15 RDK	ANK	29/10/15 RPM	29/10/15 RPM

PIN-LEP-ELT-4002

Rev.	Date	Name	Date	Name	Date	Name	Description	Acc. Code	Cat. Code	Acc. Code	Status
00	29/10/15	RDK	29/10/15	RPM	29/10/15	RPM	ISSUED AS STANDARD				

BAR-Code

Store Location: Server/Share

Store Location: Folder

Store Name

EME1

Pro. Unit

TON

Group

Type of Document

Sheet

2 / 2

Con. Unit

Scale

NTS

Order No.

thyssenkrupp

Date	Name
29/10/15	RDK
29/10/15	ANK
29/10/15	RPM
29/10/15	RPM

Description

INSTALLATION STANDARDS - EARTHING

EARTHING OF MECHANICAL EQUIPMENT

(TANK,VESSEL)

(EME1)

ITEM	DESCRIPTION	MATERIAL	QTY.	SUPPLY BY	INSTALLATION BY
1	EQUIPOTENTIAL BONDING STRIP	—	AS REQUIRED	ELECTRICAL CONTRACTOR	ELECTRICAL CONTRACTOR
2	EARTH PIT	—	—	ELECTRICAL CONTRACTOR	ELECTRICAL CONTRACTOR
3	10 DIA 50 LONG HEXAGONAL HEAD BOLTS WITH NUTS, SPRING & PLAIN WASHERS, SUITABLE FOR CONNECTIONS SHOWN IN THIS DRAWING (REFER DETAIL-1)	GI	'X' NOS REQUIRED ('X'=AS REQUIRED)	ELECTRICAL CONTRACTOR	ELECTRICAL CONTRACTOR

DRAWING NOT TO SCALE

NOTES


- 1) ALL DIMENSIONS ARE IN 'mm' UNLESS OTHERWISE SPECIFIED.
- 2) THE EARTHING CONDUCTOR ROUTED FROM THE NEUTRAL TERMINAL/BUSHING OF THE TRANSFORMER. TO THE NEUTRAL EARTH PIT SHALL BE INSULATED FROM THE BODY OF THE TRANSFORMER
- 3) SIZE OF EARTHING CONDUCTORS SHALL BE AS PER THE 'EARTHING SCHEDULE' FOR THE PROJECT.
- 4) FOR POWER TRANSFORMER RAIL EARTHING SHALL BE AS PER THE 'EARTHING SCHEDULE' FOR THE PROJECT.

DETAIL-1

Code		Contract No.		Document ID		Part		Rev.	
				PIN-LEP-ELT-4002				00	
00	29/10/15	RDK	ANK	29/10/15	RPM	29/10/15	RPM	ISSUED AS STANDARD	
Rev.	Date	Name	Date	Name	Date	Name	Description	Acc. Code	Status
BAR-Code				Store Location: Server/Share					
				Store Location: Folder					
				Store Name FBDS1					
Pro. Unit		TON		Group		Type of Document		Sheet 1 / 1	
Con. Unit		Scale		Order No.		thyssenkrupp			
		NTS							
Date		Name		Description					
Drawn		29/10/15 RDK		INSTALLATION STANDARDS – EARTHING					
Prepared		29/10/15 ANK		EARTHING OF TRANSFORMER WITH					
Checked		29/10/15 RPM		SOLIDLY GROUNDED NEUTRAL					
Approved		29/10/15 RPM		(ETS1)					


ITEM	DESCRIPTION	MATERIAL	QTY.	SUPPLY BY	INSTALLATION BY
1	EQUIPOTENTIAL BONDING STRIP	-	AS REQUIRED	ELECTRICAL CONTRACTOR	ELECTRICAL CONTRACTOR
2	EARTH PIT	-	-	ELECTRICAL CONTRACTOR	ELECTRICAL CONTRACTOR
3	10 DIA 50 LONG HEXAGONAL HEAD BOLTS, WITH NUTS & WASHERS SUITABLE FOR CONNECTIONS SHOWN IN THIS DRAWING (REFER DETAIL-1)	GI	'X' NOS ('X'=AS REQUIRED)	ELECTRICAL CONTRACTOR	ELECTRICAL CONTRACTOR


DRAWING NOT TO SCALE

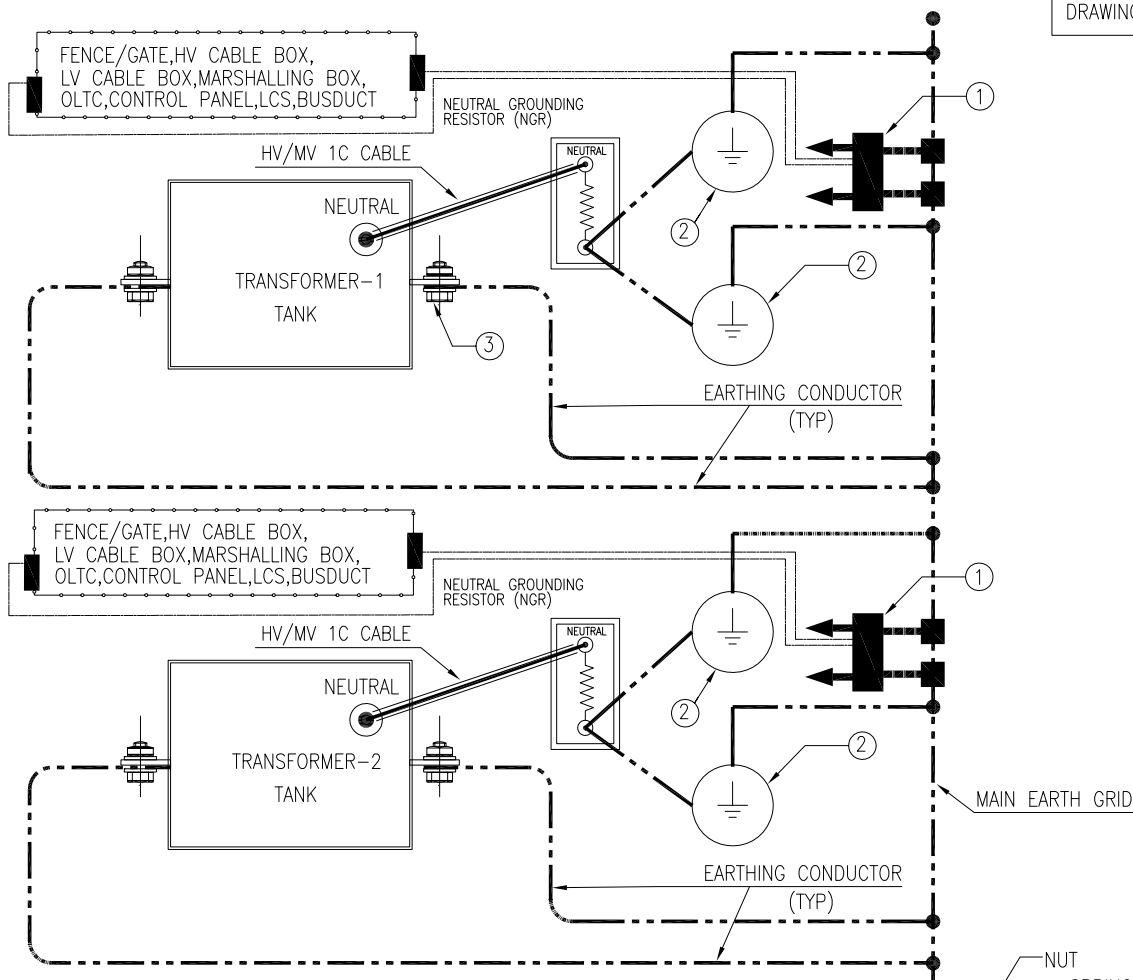

NOTES

- 1) ALL DIMENSIONS ARE IN 'mm' UNLESS OTHERWISE SPECIFIED.
- 2) THE EARTHING CONDUCTOR ROUTED FROM THE NEUTRAL TERMINAL/BUSHING OF THE TRANSFORMER TO THE NGR SHALL BE INSULATED FROM THE BODY OF THE TRANSFORMER
- 3) SIZE OF EARTHING CONDUCTORS SHALL BE AS PER THE 'EARTHING SCHEDULE' FOR THE PROJECT.
- 4) FOR POWER TRANSFORMER RAIL EARTHING SHALL BE AS PER THE 'EARTHING SCHEDULE' FOR THE PROJECT.

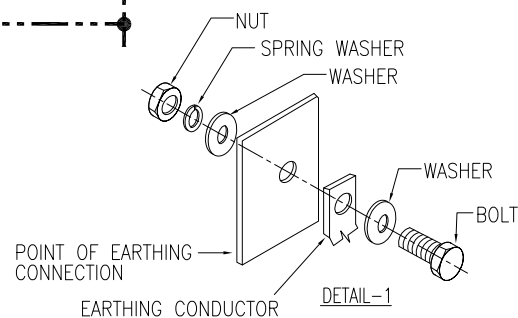

E	Code			Contract No.			Document ID			PIN-LEP-ELT-4002			Part	Rev.
	00	29/10/15	RDK	ANK	29/10/15	RPM	29/10/15	RPM	ISSUED AS STANDARD			Cat. Code	Acc. Code	Status
	Rev.	Date	Name		Date	Name	Date	Name	Description		Acc. Code			
	Drawn/Prepared		Checked		Approved									
F	BAR-Code								Store Location: Server/Share					
									Store Location: Folder					
									Store Name ETN1					
	Pro. Unit	TON			Group	Type of Document		Sheet		1 / 1				
	Con. Unit	Scale		Order No.		 thyssenkrupp								
	NTS													
	ISO A4		Date	Name		Description INSTALLATION STANDARDS – EARTHING EARTHING OF TRANSFORMER WITH NEUTRAL GROUNDING THROUGH NGR (ETN1)								
Drawn		29/10/15	RDK											
Prepared		29/10/15	ANK											
Checked		29/10/15	RPM											
Approved		29/10/15	RPM											

1	2	3	4		
ITEM	DESCRIPTION	MATERIAL	QTY.	SUPPLY BY	INSTALLATION BY
1	EARTHING CONDUCTOR AS PER EARTHING SCHEDULE	—	AS REQUIRED	ELECTRICAL CONTRACTOR	ELECTRICAL CONTRACTOR
2	EARTH PIT	—	AS REQUIRED	ELECTRICAL CONTRACTOR	ELECTRICAL CONTRACTOR
3	10 DIA 50 LONG HEXAGONAL HEAD BOLTS WITH NUTS, SPRING & PLAIN WASHERS, SUITABLE FOR CONNECTIONS SHOWN IN THIS DRAWING (REFER DETAIL-1)	GI	'X' NOS ('X'=AS REQUIRED)	ELECTRICAL CONTRACTOR	ELECTRICAL CONTRACTOR

A

B

C

D

50 mm

NOTES

- 1) ALL DIMENSIONS ARE IN 'mm' UNLESS OTHERWISE SPECIFIED.
- 2) THE EARTHING CONDUCTOR ROUTED FROM THE NEUTRAL TERMINAL/BUSHING OF THE DG TO THE NEUTRAL EARTH PIT SHALL BE INSULATED FROM THE BODY OF THE DG.
- 3) SIZE OF EARTHING CONDUCTORS SHALL BE AS PER THE 'EARTHING SCHEDULE' FOR THE PROJECT.
- 4) ENGINE, BED PLATE, ALTERNATOR OF THE GENERATING SET SHOULD BE BONDED TO DG SET BODY BY DG SET PACKAGE VENDOR.

DETAIL-1

Code		Contract No.		Document ID		Part		Rev.																
				PIN-LEP-ELT-4002				00																
00	24/11/15	RDK	ANK	24/11/15	RPM	24/11/15	RPM	ISSUED AS STANDARD																
Rev.	Date	Name		Date	Name	Date	Name	Description	Acc. Code															
		Drawn/Prepared			Checked		Approved																	
BAR-Code						Store Location: Server/Share																		
						Store Location: Folder																		
						Store Name																		
						EDG1																		
Pro. Unit		TON		Group		Type of Document		Sheet																
								1 / 1																
Con. Unit		Scale		Order No.																				
		NTS																						
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							Date	Name																
						Drawn	29/10/15	RDK																
						Prepared	24/11/15	ANK																
						Checked	24/11/15	RPM																
Approved	24/11/15	RPM																						

1	2	3	4
ITEM	DESCRIPTION	MATERIAL	QTY.
1	EQUIPOTENTIAL BONDING STRIP (AS PER INSTALLATION DRAWING EEB1)	-	1 SET
2	EARTHING CONDUCTOR (AS PER EARTHING SCHEDULE)	-	AS REQUIRED
3	EARTHING STUB-UP (AS PER EARTHING SCHEDULE),	HDGI	2 NOs.

VIEW-A

VIEW-A'

DETAIL-1'

DRAWING NOT TO SCALE

NOTES

1) ALL DIMENSIONS ARE IN 'mm' UNLESS OTHERWISE SPECIFIED.

2) SIZE OF EARTHING CONDUCTOR SHALL BE AS PER THE 'EARTHING SCHEDULE' FOR THE PROJECT.

BAR-Code

Store Location: Server/Share

Store Location: Folder

Store Name

EML1

Pro. Unit TON Group Type of Document Sheet 1 / 1

Con. Unit Scale NTS Order No.

ISO A4

	Date	Name
Drawn	29/10/15	RDK
Prepared	29/10/15	ANK
Checked	29/10/15	RPM
Approved	29/10/15	RPM

Description

INSTALLATION STANDARDS – EARTHING

EARTHING OF LV MOTOR ON SEPARTE SKID (EML1)

ITEM	DESCRIPTION	MATERIAL	QTY.	SUPPLY BY	INSTALLATION BY
1	EQUIPOTENTIAL BONDING STRIP (AS PER INSTALLATION DRAWING EEB1)	—	1 SET	ELECTRICAL CONTRACTOR	ELECTRICAL CONTRACTOR
2	EARTHING CONDUCTOR (AS PER EARTHING SCHEDULE)	—	AS REQUIRED	ELECTRICAL CONTRACTOR	ELECTRICAL CONTRACTOR
3	EARTHING STUB-UP (AS PER EARTHING SCHEDULE),	HDGI	2 NOs.	ELECTRICAL CONTRACTOR	ELECTRICAL CONTRACTOR

DRAWING NOT TO SCALE

NOTES

1) ALL DIMENSIONS ARE IN 'mm' UNLESS OTHERWISE SPECIFIED.

2) SIZE OF EARTHING CONDUCTOR SHALL BE AS PER THE 'EARTHING SCHEDULE' FOR THE PROJECT.

Code		Contract No.		Document ID		Part		Rev.	
00	29/10/15	RDK	ANK	29/10/15	RPM	29/10/15	RPM	PIN-LEP-ELT-4002	
Rev.	Date	Name		Date	Name	Date	Name	Cat. Code	00
		Drawn/Prepared			Checked		Approved	Acc. Code	Status

Store Location: Server/Share	
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Store Name	
Pro. Unit	TON
Group	Type of Document
Sheet	1 / 1
Con. Unit	Scale
Order No.	


ISO A4

	Date	Name
Drawn	29/10/15	RDK
Prepared	29/10/15	ANK
Checked	29/10/15	RPM
Approved	29/10/15	RPM

Description

INSTALLATION STANDARDS – EARTHING
EARTHING OF TWO LV MOTOR
ON COMMON SKID
(EML2)

ITEM	DESCRIPTION	MATERIAL	QTY.	SUPPLY BY	INSTALLATION BY
1	EQUIPOTENTIAL BONDING STRIP (AS PER INSTALLATION DRAWING EEB3)	—	1 SET	ELECTRICAL CONTRACTOR	ELECTRICAL CONTRACTOR
2	EARTHING CONDUCTOR (AS PER EARTHING SCHEDULE)	—	AS REQUIRED	ELECTRICAL CONTRACTOR	ELECTRICAL CONTRACTOR

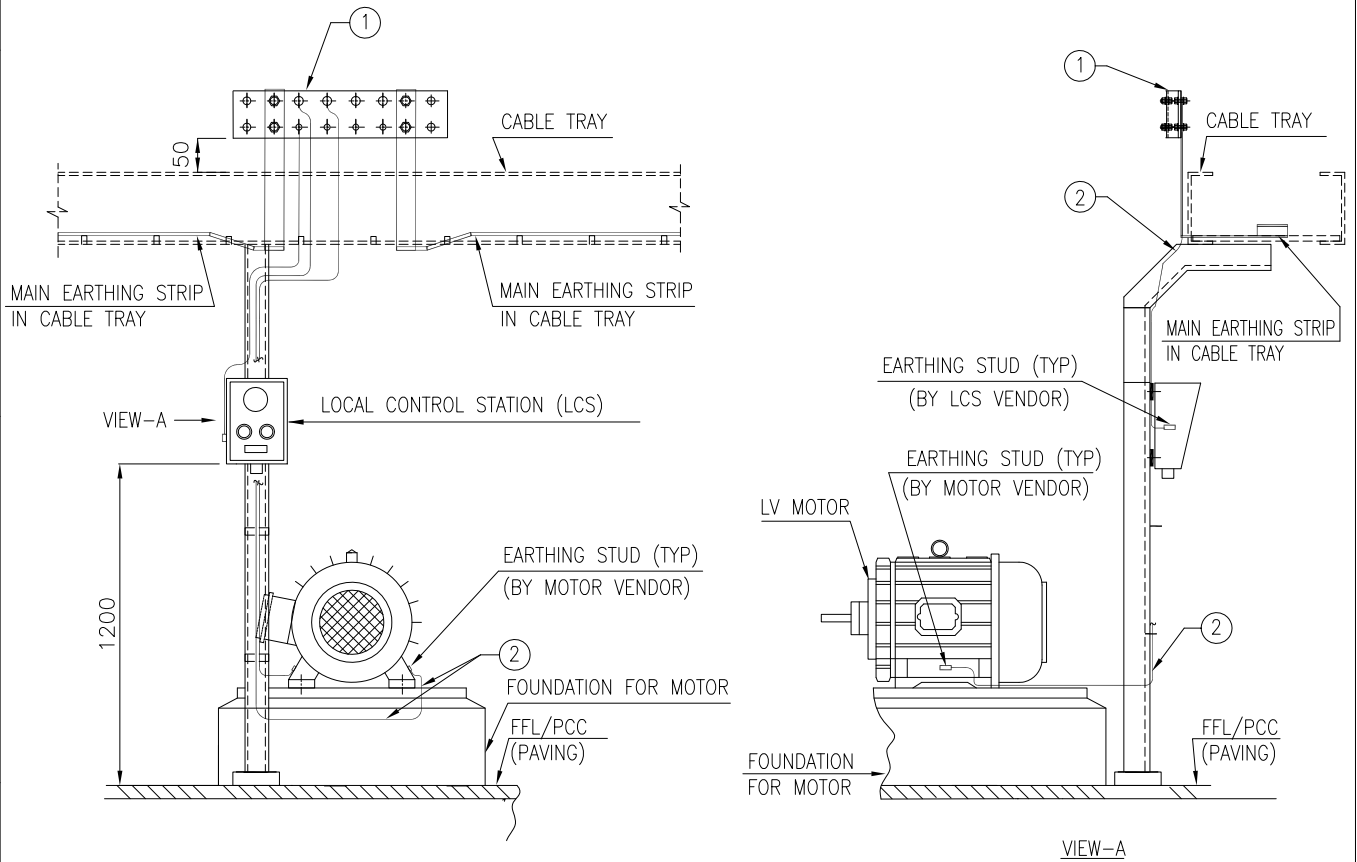


DRAWING NOT TO SCALE

NOTES

- 1) ALL DIMENSIONS ARE IN 'mm' UNLESS OTHERWISE SPECIFIED.
- 2) SIZE OF EARTHING CONDUCTOR SHALL BE AS PER THE 'EARTHING SCHEDULE' FOR THE PROJECT.

Code	Contract No.	Document ID	Part	Rev.
00	29/10/15 RDK ANK	29/10/15 RPM	PIN-LEP-ELT-4002	00
Rev.	Date	Name	Description	Acc. Code
00	29/10/15	RDK	ISSUED AS STANDARD	
01	29/10/15	ANK		
02	29/10/15	RPM		
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06	29/10/15	RPM		
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99	29/10/15	RPM		
100	29/10/15	RPM		

A	1		2		3		4	
	ITEM	DESCRIPTION			MATERIAL	QTY.	SUPPLY BY	INSTALLATION BY
	1	EQUIPOTENTIAL BONDING STRIP (AS PER INSTALLATION DRAWING EEB1)			—	1 SET	ELECTRICAL CONTRACTOR	ELECTRICAL CONTRACTOR
	2	EARTHING CONDUCTOR (AS PER EARTHING SCHEDULE)			—	AS REQUIRED	ELECTRICAL CONTRACTOR	ELECTRICAL CONTRACTOR

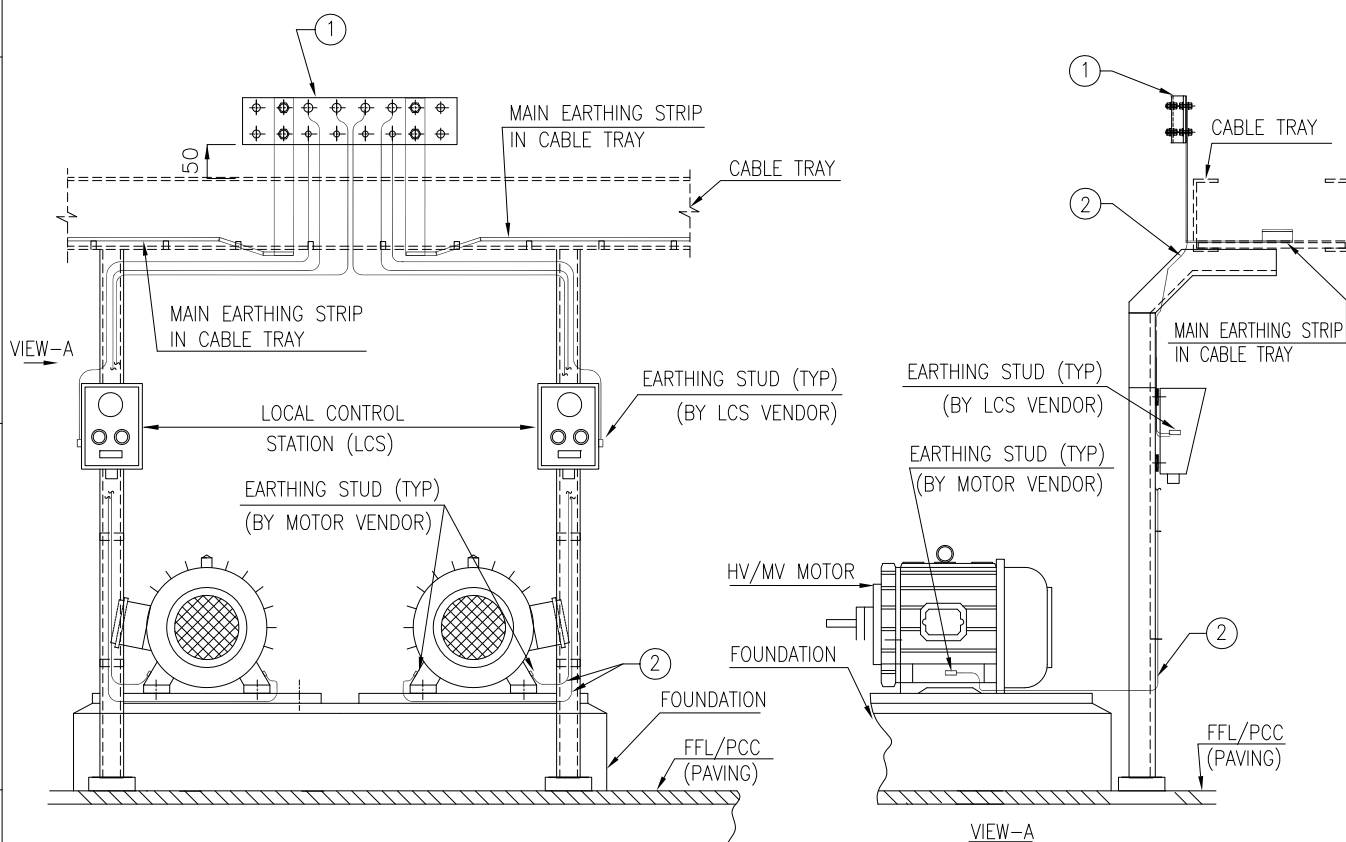

NOTES

- 1) ALL DIMENSIONS ARE IN 'mm' UNLESS OTHERWISE SPECIFIED.
- 2) SIZE OF EARTHING CONDUCTOR SHALL BE AS PER THE 'EARTHING SCHEDULE' FOR THE PROJECT.

Code		Contract No.		Document ID				Part		Rev.		
				PIN-LEP-ELT-4002						00		
00	29/10/15	RDK	ANK	29/10/15	RPM	29/10/15	RPM	ISSUED AS STANDARD		Cat. Code	Acc. Code	Status
Rev.	Date	Name		Date	Name	Date	Name	Description	Acc. Code			
Drawn/Prepared				Checked				Approved				
BAR-Code								Store Location: Server/Share				
								Store Location: Folder				
								Store Name				
								EML1				
Pro. Unit		TON		Group		Type of Document		Sheet				
								1 / 1				
Con. Unit		Scale		Order No.								
		NTS										
Description												
INSTALLATION STANDARDS – EARTHING												
EARTHING OF TWO LV MOTOR ON COMMON												
SKID ABOVE GROUND EARTHING												
(EML4)												

Date	Name
Drawn	29/10/15 RDK
Prepared	29/10/15 ANK
Checked	29/10/15 RPM
Approved	29/10/15 RPM

ISO A4

1	2	3	4
ITEM	DESCRIPTION	MATERIAL	QTY.
1	EQUIPOTENTIAL BONDING STRIP (AS PER INSTALLATION DRAWING EEB1)	—	1 SET
2	EARTHING CONDUCTOR (AS PER EARTHING SCHEDULE)	—	AS REQUIRED
3	EARTHING STUB-UP (AS PER EARTHING SCHEDULE),	HDGI	2 NOs.

VIEW-A

VIEW-A'

DETAIL-1'

DRAWING NOT TO SCALE

NOTES

1) ALL DIMENSIONS ARE IN 'mm' UNLESS OTHERWISE SPECIFIED.



2) SIZE OF EARTHING CONDUCTOR SHALL BE AS PER THE 'EARTHING SCHEDULE' FOR THE PROJECT.

Code		Contract No.		Document ID				Part		Rev.	
00	29/10/15	RDK	ANK	29/10/15	RPM	29/10/15	RPM	PIN-LEP-ELT-4002		00	
Rev.	Date	Name		Date	Name	Date	Name	ISSUED AS STANDARD	Cat. Code	Acc. Code	Status
		Drawn/Prepared			Checked		Approved	Description	Acc. Code		

Store Location: Server/Share			
Store Location: Folder			
Store Name			
EMH1			
Pro. Unit	TON	Group	Type of Document
Con. Unit	Scale	Order No.	Sheet
	NTS		1 / 1

Date	Name	Description
29/10/15	RDK	INSTALLATION STANDARDS – EARTHING EARTHING OF HV MOTOR (EMH1)
29/10/15	ANK	
29/10/15	RPM	
29/10/15	RPM	

A	1		2		← 50 mm → 3		4	
	ITEM	DESCRIPTION			MATERIAL	QTY.	SUPPLY BY	INSTALLATION BY
	1	EQUIPOTENTIAL BONDING STRIP (AS PER INSTALLATION DRAWING EEB3)			—	1 SET	ELECTRICAL CONTRACTOR	ELECTRICAL CONTRACTOR
	2	EARTHING CONDUCTOR (AS PER EARTHING SCHEDULE)			—	AS REQUIRED	ELECTRICAL CONTRACTOR	ELECTRICAL CONTRACTOR

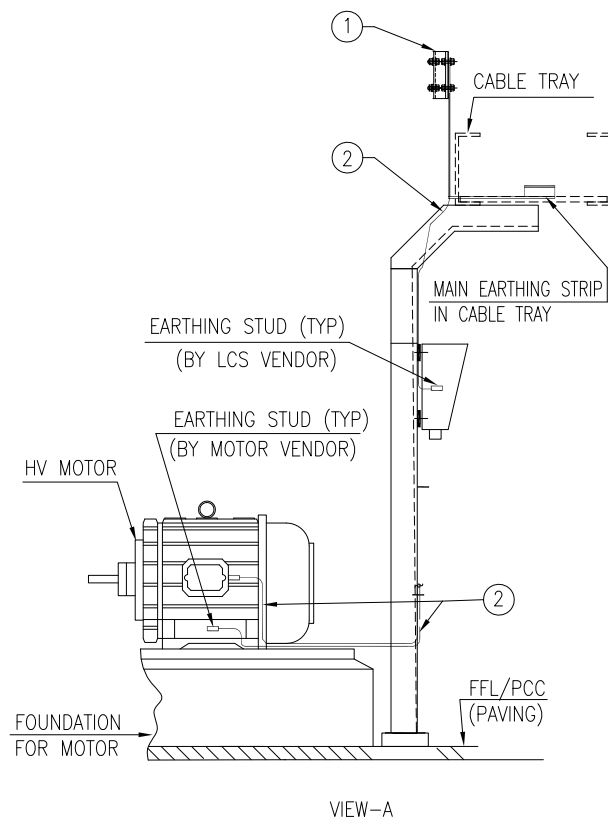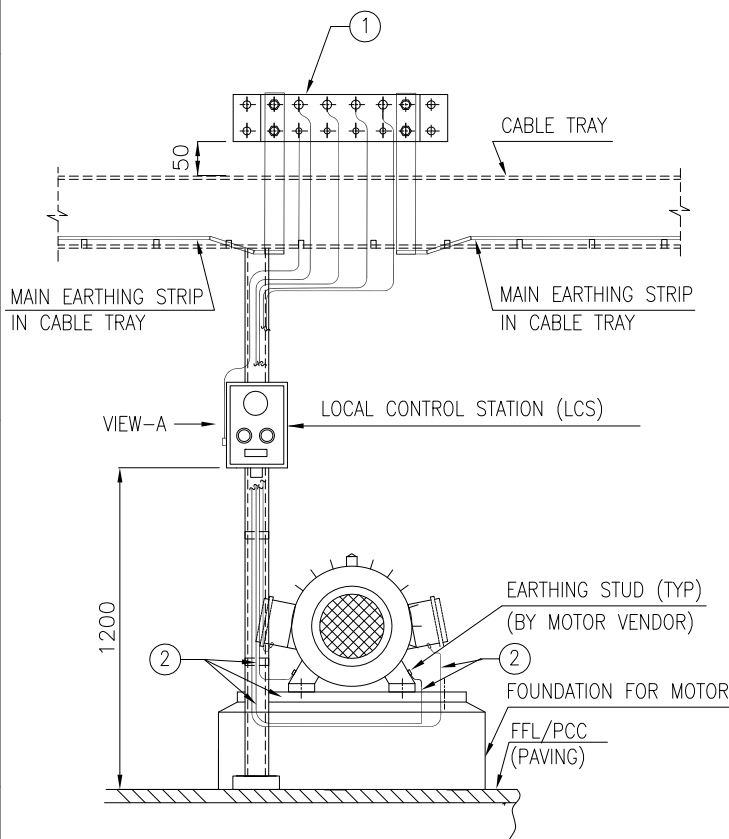

DRAWING NOT TO SCALE

NOTES

- 1) ALL DIMENSIONS ARE IN 'mm' UNLESS OTHERWISE SPECIFIED.
- 2) SIZE OF EARTHING CONDUCTOR SHALL BE AS PER THE 'EARTHING SCHEDULE' FOR THE PROJECT.

Code			Contract No.			Document ID				Part		Rev.
00	29/10/15	RDK	ANK	29/10/15	RPM	29/10/15	RPM	PIN-LEP-ELT-4002				00
Rev.	Date	Name		Date	Name	Date	Name	Description	Acc. Code	Cat. Code	Acc. Code	Status
	Drawn/Prepared			Checked		Approved						

BAR-Code

Store Location: Server/Share

Store Location: Folder

Store Name

Pro. Unit	TON	Group	Type of Document	Sheet
				1 / 1

Con. Unit	Scale	Order No.	
	NTS		thyssenkrupp

	Date	Name
Drawn	29/10/15	RDK
Prepared	29/10/15	ANK
Checked	29/10/15	RPM
Approved	29/10/15	RPM

Description
INSTALLATION STANDARDS - EARTHING
EARTHING OF HV MOTOR
ABOVE GROUND EARTHING
(EMH2)

1	2	3	4			
ITEM	DESCRIPTION	MATERIAL	QTY.	SUPPLY BY	INSTALLATION BY	
A	1	EARTHING CONDUCTOR-SIZE OF EARTHING CONDUTOR SHALL BE AS PER THE 'EARTHING SCHEDULE' FOR THE PROJECT.		AS REQUIRED	ELECTRICAL CONTRACTOR	ELECTRICAL CONTRACTOR
	2	8 DIA HEXAGONAL HEAD BOLTS-25mm LONG, WITH NUTS, SPRING & PLAIN WASHERS, SUITABLE FOR CONNECTIONS SHOWN IN THIS DRAWING (REFER DETAIL-2)	GI	AS REQUIRED	ELECTRICAL CONTRACTOR	ELECTRICAL CONTRACTOR
	3	LUG FOR EARTHING CONDUCTOR		AS REQUIRED	ELECTRICAL CONTRACTOR	ELECTRICAL CONTRACTOR

B

DETAIL-1

DETAIL-2

DRAWING NOT TO SCALE

NOTES:

1) ALL DIMENSIONS ARE IN 'mm' UNLESS OTHERWISE SPECIFIED.

2) USE TWO EARTH WIRES IF VOLTAGE IN THE POLE, JUNCTION BOX IS 415VOLTS.

Code		Contract No.		Document ID				Part		Rev.	
				PIN-LEP-ELT-4002						00	
00	29/10/15	RDK	ANK	29/10/15	RPM	29/10/15	RPM	ISSUED AS STANDARD	Cat. Code	Acc. Code	Status
Rev.	Date	Name		Date	Name		Date	Name		Description	Acc. Code
		Drawn/Prepared		Checked		Approved					

BAR-Code

Store Location: Server/Share

Store Location: Folder

Store Name

ESL1

Pro. Unit	TON	Group	Type of Document	Sheet
				1 / 1

Con. Unit	Scale	Order No.
	NTS	

ISO A4

Date	Name
Drawn	29/10/15 RDK
Prepared	29/10/15 ANK
Checked	29/10/15 RPM
Approved	29/10/15 RPM

Description

INSTALLATION STANDARDS – EARTHING
TYPICAL EARTH CONNECTION
FOR STREET LIGHT POLE
(ESL1)

1	2	3	4	5	6
ITEM	DESCRIPTION	MATERIAL	QTY.	SUPPLY BY	INSTALLATION BY
1	EARTHING CONDUCTOR—SIZE OF EARTHING CONDUCTOR SHALL BE AS PER THE 'EARTHING SCHEDULE' FOR THE PROJECT.		AS REQUIRED	ELECTRICAL CONTRACTOR	ELECTRICAL CONTRACTOR
2	8 DIA HEXAGONAL HEAD BOLTS—25mm LONG, WITH NUTS, SPRING & PLAIN WASHERS, SUITABLE FOR CONNECTIONS SHOWN IN THIS DRAWING (REFER DETAIL-2)	GI	AS REQUIRED	ELECTRICAL CONTRACTOR	ELECTRICAL CONTRACTOR
3	50mm DIA & 2500mm LONG PIPE	GI	1 NO.	ELECTRICAL CONTRACTOR	ELECTRICAL CONTRACTOR
4	LUG FOR EARTHING CONDUCTOR		AS REQUIRED	ELECTRICAL CONTRACTOR	ELECTRICAL CONTRACTOR

B

C

DRAWING NOT TO SCALE

DETAIL-1

DETAIL-3

DETAIL-2


NOTES:
 1) ALL DIMENSIONS ARE IN 'mm' UNLESS OTHERWISE SPECIFIED.
 2) USE TWO EARTH WIRES IF VOLTAGE IN THE POLE, JUNCTION BOX IS 415VOLTS.

Code		Contract No.		Document ID		Part		Rev.	
				PIN-LEP-ELT-4002				00	
00	29/10/15	RDK	ANK	29/10/15	RPM	29/10/15	RPM	ISSUED AS STANDARD	
Rev.	Date	Name		Date	Name	Date	Name	Description	Acc. Code
		Drawn/Prepared			Checked		Approved		


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Store Location: Folder	
Store Name ESL2	
Pro. Unit TON	Group Type of Document Sheet 1 / 1
Con. Unit Scale NTS	Order No. thyssenkrupp

ISO A4		Date	Name	Description INSTALLATION STANDARDS – EARTHING TYPICAL EARTH CONNECTION FOR STREET LIGHT POLE WITH EARTH ROD (ESL2)
	Drawn	29/10/15	RDK	
	Prepared	29/10/15	ANK	
	Checked	29/10/15	RPM	
	Approved	29/10/15	RPM	

1	2	3	4	5	6
ITEM	DESCRIPTION	MATERIAL	QTY.	SUPPLY BY	INSTALLATION BY
1	EARTHING CONDUCTOR. SIZE OF EARTHING CONDUCTOR & MATERIAL SHALL BE AS PER THE 'EARTHING SCHEDULE' FOR THE PROJECT.	—	AS REQUIRED	ELECTRICAL CONTRACTOR	ELECTRICAL CONTRACTOR
2	HEXAGONAL HEAD BOLTS—25mm LONG, WITH NUTS & WASHERS SUITABLE FOR CONNECTIONS SHOWN IN THIS DRAWING (REFER DETAIL-1)	GI	AS REQUIRED	ELECTRICAL CONTRACTOR	ELECTRICAL CONTRACTOR
3	CABLE LUG SUITABLE FOR THE EARTHING CONDUCTOR	—	AS REQUIRED	ELECTRICAL CONTRACTOR	ELECTRICAL CONTRACTOR

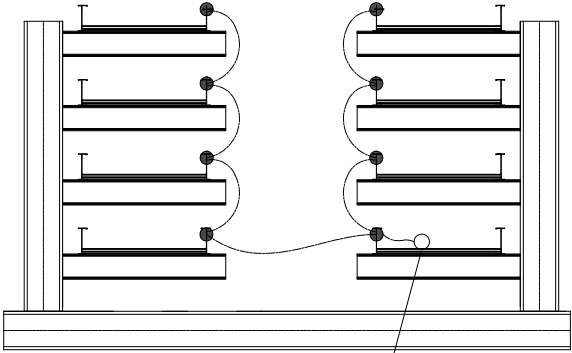


CABLE TRAY BONDING ON PIPERACK, (EVERY 50 METER)

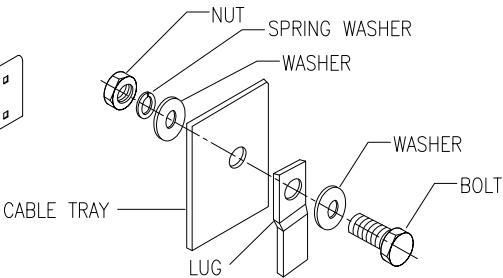


DETAIL-1

DRAWING NOT TO SCALE

Code		Contract No.		Document ID				Part		Rev.	
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Rev.	Date	Name		Date	Name	Date	Name	ISSUED AS STANDARD	Acc. Code	Cat. Code	Status
		Drawn/Prepared			Checked		Approved				

BAR-Code				Store Location: Server/Share			
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				Store Name ETB1			
Pro. Unit	TON	Group		Type of Document	Sheet	1 / 1	
Con. Unit	Scale	Order No.					
NTS							

	Date	Name	Description
Drawn	29/10/15	RDK	INSTALLATION STANDARDS – EARTHING EARTH BONDING OF CABLE TRAYS (ETB1)
Prepared	29/10/15	ANK	
Checked	29/10/15	RPM	
Approved	29/10/15	RPM	

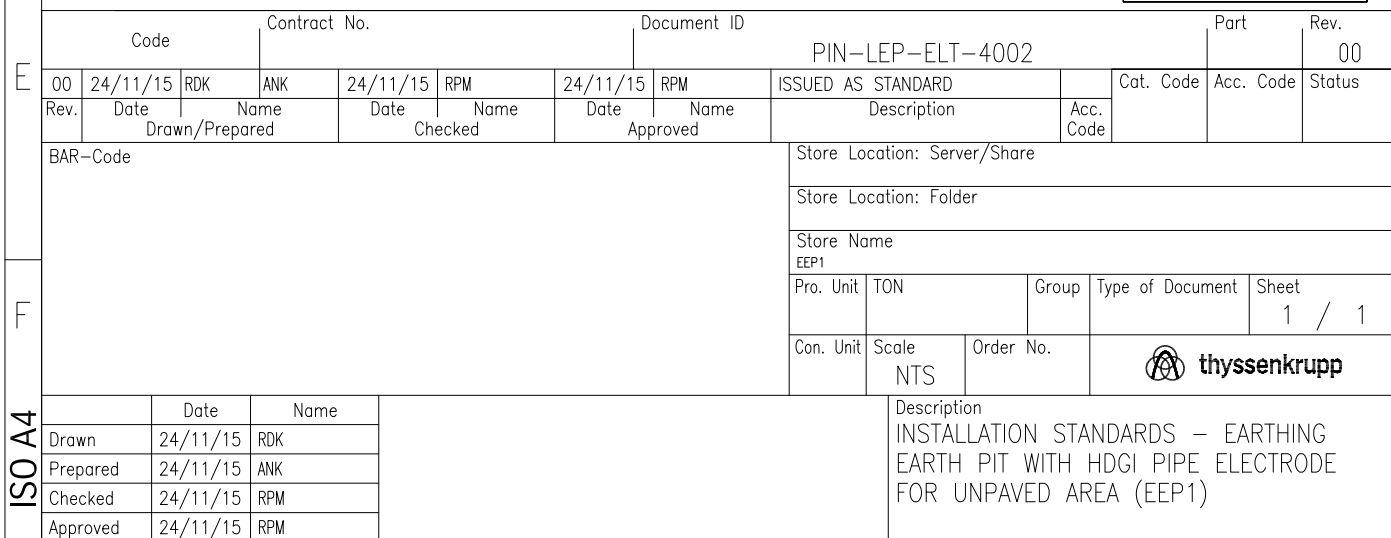

1	2	3	4
ITEM	DESCRIPTION	MATERIAL	QTY.
1	EARTHING ROD, 19 DIA, 3500mm LONG	COPPER COATED STEEL	1NO.
2	TEST LINK ASSEMBLY-50(W)X6(T), STRIP, BENT TO SHAPE OF ITEM-1, WITH 4 NOS 12 DIA HOLES AND ANOTHER STRIP WITH 6NOS 12 DIA HOLES(REFER DETAIL-1)	COPPER COATED STEEL	1 SET
3	10 DIA HEXAGONAL HEAD BOLTS-60mm LONG, WITH NUTS, SPRING & PLAIN WASHERS, SUITABLE FOR CONNECTIONS SHOWN IN THIS DRAWING (REFER DETAIL-4)	SS304	6 SETS
4	PIPE SLEEVE-150 DIA, FOR ENTRY OF EARTHING CONDUCTOR (REFER DETAIL-2)	PVC	0.8MTRS
5	EARTH PIT CHAMBER (TYPE B) REFER NOTE-3	REINFORCED CONCRETE	1NO.
6	EARTH PIT COVER (TYPE B) REFER NOTE-3	REINFORCED CONCRETE	1NO.

* CIVIL/ELECTRICAL SCOPE SHALL BE DECIDED PROJECT SPECIFIC

DETAIL-1

DETAIL-2

DETAIL-3

DETAIL-4

NOTES

- 1) ALL DIMENSION ARE IN 'mm' UNLESS OTHERWISE SPECIFIED.
- 2) SIZE OF EARTHING CONDUCTOR SHALL BE AS PER THE 'EARTHING SCHEDULE' FOR THE PROJECT.
- 3) IN GENERAL THE TOTAL LENGTH OF THE ROD ELECTRODE SHALL BE 3.5MTRS. IF ELECTRODES ARE TO BE DRIVEN DEEPER THAN 3.5MTRS, THIS REQUIREMENT SHALL BE SPECIFICALLY MENTIONED IN THE 'EARTHING LAYOUT' FOR THE PROJECT & THE SAME SHALL BE FOLLOWED DURING INSTALLATION.
- 4) FOR EARTHING PIT CHAMBER & EARTH PIT COVER DETAIL REFER CIVIL STANDARD DRG.NO. PIN-LEP-CVC-1013.


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
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Rev.	Date	Name		Date	Name	Date	Name	Description	Status
		Drawn/Prepared			Checked		Approved		

Store Location: Server/Share		Store Location: Folder		Store Name	
				EEP2	
Pro. Unit	TON	Group	Type of Document	Sheet	
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Con. Unit	Scale	Order No.			
	NTS		thyssenkrupp		


Date	Name	Description
Drawn	24/11/15 RDK	INSTALLATION STANDARDS – EARTHING EARTH PIT WITH DEEP ROD ELECTRODE FOR UNPAVED AREA (EEP2)
Prepared	24/11/15 ANK	
Checked	24/11/15 RPM	
Approved	24/11/15 RPM	

1		2		50 mm		3		4	
ITEM	DESCRIPTION			MATERIAL	QTY.	SUPPLY BY	INSTALLATION BY		
A	1	EARTHING PLATE-600(L)x600(W)x6.3(T), WITH 40 DIA HOLE AT CENTRE.			HDGI	1 NO	ELECTRICAL CONTRACTOR	ELECTRICAL CONTRACTOR	
	2	EARTHING STRIP-50(W)x12(T), WITH 12 DIA HOLES.			HDGI	AS REQUIRED	ELECTRICAL CONTRACTOR	ELECTRICAL CONTRACTOR	
	3	PIPE - 50 DIA N.B., CLASS-B, TAPERED AT ONE END, WITH 12 DIA THROUGH HOLES AT EVERY 75mm.			HDGI	AS REQUIRED	ELECTRICAL CONTRACTOR	ELECTRICAL CONTRACTOR	
	4	TEST LINK ASSEMBLY-50(W)x12(T), STRIP, BENT TO SHAPE OF ITEM-1, WITH 4 NOs 12 DIA HOLES AND ANOTHER STRIP WITH 6NOs 12 DIA HOLES(REFER DETAIL-1)			HDGI	1 SET	ELECTRICAL CONTRACTOR	ELECTRICAL CONTRACTOR	
	5	FUNNEL, WITH WIRE MESH-SUITABLE FOR TACK WELDED TO TIP OF ITEM-3.			HDGI	1 NO	ELECTRICAL CONTRACTOR	ELECTRICAL CONTRACTOR	
	6	CLAMPS-25(W)x3(T) STRIP BENT TO SHAPE OF ITEM-3, WITH 2 NOs 12 DIA HOLES.			HDGI	4 NOs	ELECTRICAL CONTRACTOR	ELECTRICAL CONTRACTOR	
	7	CLAMPS-25(W)x3(T) STRIP BENT TO SHAPE OF ITEM-3, WITH 2 NOs 10 DIA HOLES.			HDGI	2 NOs	ELECTRICAL CONTRACTOR	ELECTRICAL CONTRACTOR	
B	8	12 DIA HEXAGONAL HEAD BOLTS-60mm LONG, WITH NUTS & WASHERS, SUITABLE FOR CONNECTIONS SHOWN IN THIS DRAWING (REFER DETAIL-6)			GI	16 SETS	ELECTRICAL CONTRACTOR	ELECTRICAL CONTRACTOR	
	9	10 DIA HEXAGONAL HEAD BOLTS-40mm LONG WITH NUTS & WASHERS, SUITABLE FOR CONNECTIONS SHOWN IN THIS DRAWING (REFER DETAIL-6)			GI	4 SETS	ELECTRICAL CONTRACTOR	ELECTRICAL CONTRACTOR	
	10	PIPE SLEEVE-150 DIA, FOR ENTRY OF EARTHING CONDUCTOR (REFER DETAIL-2)			PVC	0.8 MTRS	*CIVIL/ELECTRICAL CONTRACTOR	*CIVIL/ELECTRICAL CONTRACTOR	
	11	EARTH PIT CHAMBER (TYPE B) FOR DETAIL REFER CIVIL STANDARD DRG.NO. PIN-LEP-CVC-1013.			REINFORCED CONCRETE	1 NO	*CIVIL/ELECTRICAL CONTRACTOR	*CIVIL/ELECTRICAL CONTRACTOR	
	12	EARTH PIT COVER (TYPE B) FOR DETAIL REFER CIVIL STANDARD DRG.NO. PIN-LEP-CVC-1013.			REINFORCED CONCRETE	1 NO	*CIVIL/ELECTRICAL CONTRACTOR	*CIVIL/ELECTRICAL CONTRACTOR	
	13	CHARCOAL AND SALT			-	1 LOT	ELECTRICAL CONTRACTOR	ELECTRICAL CONTRACTOR	

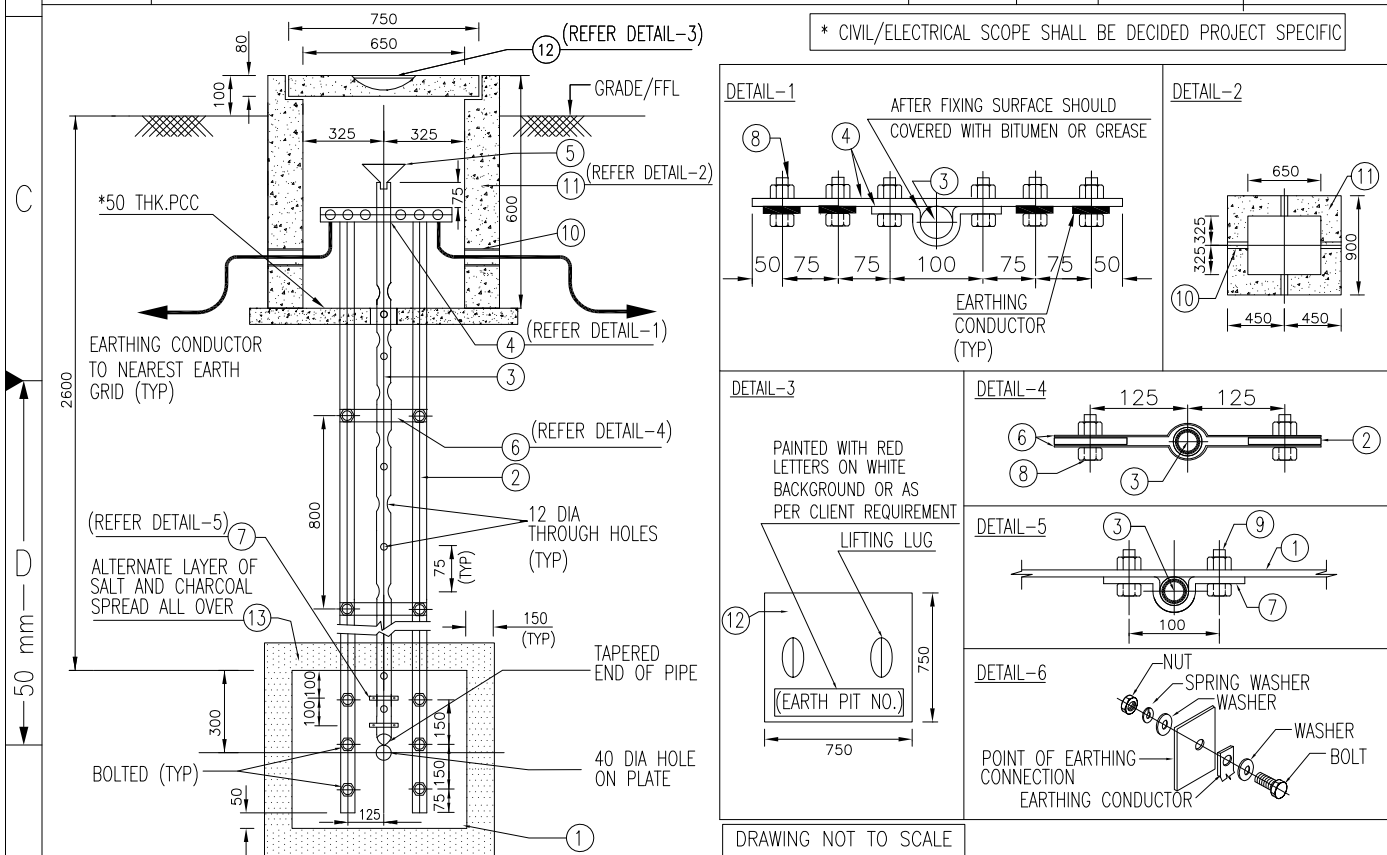


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			NTS					 thyssenkrupp								
ISO A4		Date	Name													
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	Prepared	24/11/15	ANK													
	Checked	24/11/15	RPM													
	Approved	24/11/15	RPM													
											Description					
											INSTALLATION STANDARDS – EARTHING					
											EARTH PIT WITH HDGI PLATE ELECTRODE					
											FOR UNPAVED AREA (EEP3)					


1		2		3		4	
ITEM	DESCRIPTION	MATERIAL	QTY.	SUPPLY BY	INSTALLATION BY		
1	EARTHING PLATE-1200(L)X1200(W)X12(T), WITH 40 DIA HOLE AT CENTRE.	CAST IRON	1 NO	ELECTRICAL CONTRACTOR	ELECTRICAL CONTRACTOR		
2	EARTHING STRIP-50(W)X12(T), WITH 12 DIA HOLES.	HDGI	AS REQUIRED	ELECTRICAL CONTRACTOR	ELECTRICAL CONTRACTOR		
3	PIPE - 50 DIA N.B., CLASS-B, TAPERED AT ONE END, WITH 12 DIA THROUGH HOLES AT EVERY 75mm.	HDGI	AS REQUIRED	ELECTRICAL CONTRACTOR	ELECTRICAL CONTRACTOR		
4	TEST LINK ASSEMBLY-50(W)X12(T), STRIP BENT TO SHAPE OF ITEM-1, WITH 4 NOs 12 DIA HOLES AND ANOTHER STRIP WITH 6NOs 12 DIA HOLES(REFER DETAIL-1)	HDGI	1 SET	ELECTRICAL CONTRACTOR	ELECTRICAL CONTRACTOR		
5	FUNNEL, WITH WIRE MESH-SUITABLE FOR TACK WELDED TO TIP OF ITEM-3.	HDGI	1 NO	ELECTRICAL CONTRACTOR	ELECTRICAL CONTRACTOR		
6	CLAMPS-25(W)X3(T) STRIP BENT TO SHAPE OF ITEM-3, WITH 2 NOs 12 DIA HOLES.	HDGI	4 NOs	ELECTRICAL CONTRACTOR	ELECTRICAL CONTRACTOR		
7	CLAMPS-25(W)X3(T) STRIP BENT TO SHAPE OF ITEM-3, WITH 2 NOs 10 DIA HOLES.	HDGI	2 NOs	ELECTRICAL CONTRACTOR	ELECTRICAL CONTRACTOR		
8	12 DIA HEXAGONAL HEAD BOLTS-60mm LONG, WITH NUTS & WASHERS, SUITABLE FOR CONNECTIONS SHOWN IN THIS DRAWING (REFER DETAIL-6)	GI	20 SETS	ELECTRICAL CONTRACTOR	ELECTRICAL CONTRACTOR		
9	10 DIA HEXAGONAL HEAD BOLTS-40mm LONG WITH NUTS & WASHERS, SUITABLE FOR CONNECTIONS SHOWN IN THIS DRAWING (REFER DETAIL-6)	GI	4 SETS	ELECTRICAL CONTRACTOR	ELECTRICAL CONTRACTOR		
10	PIPE SLEEVE-150 DIA, FOR ENTRY OF EARTHING CONDUCTOR (REFER DETAIL-2)	PVC	0.8 MTRS	*CIVIL/ELECTRICAL CONTRACTOR	*CIVIL/ELECTRICAL CONTRACTOR		
11	EARTH PIT CHAMBER (TYPE B) FOR DETAIL REFER CIVIL STANDARD DRG.NO. PIN-LEP-CVC-1013.	REINFORCED CONCRETE	1 NO	*CIVIL/ELECTRICAL CONTRACTOR	*CIVIL/ELECTRICAL CONTRACTOR		
12	EARTH PIT COVER (TYPE B) FOR DETAIL REFER CIVIL STANDARD DRG.NO. PIN-LEP-CVC-1013.	REINFORCED CONCRETE	1 NO	*CIVIL/ELECTRICAL CONTRACTOR	*CIVIL/ELECTRICAL CONTRACTOR		
13	CHARCOAL AND SALT	-	1 LOT	ELECTRICAL CONTRACTOR	ELECTRICAL CONTRACTOR		

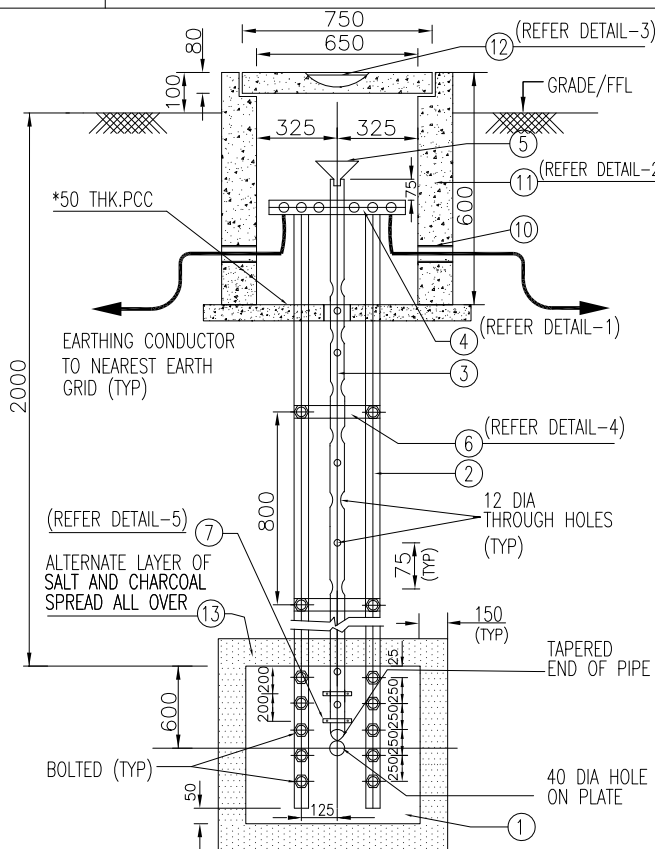


* CIVIL/ELECTRICAL SCOPE SHALL BE DECIDED PROJECT SPECIFIC

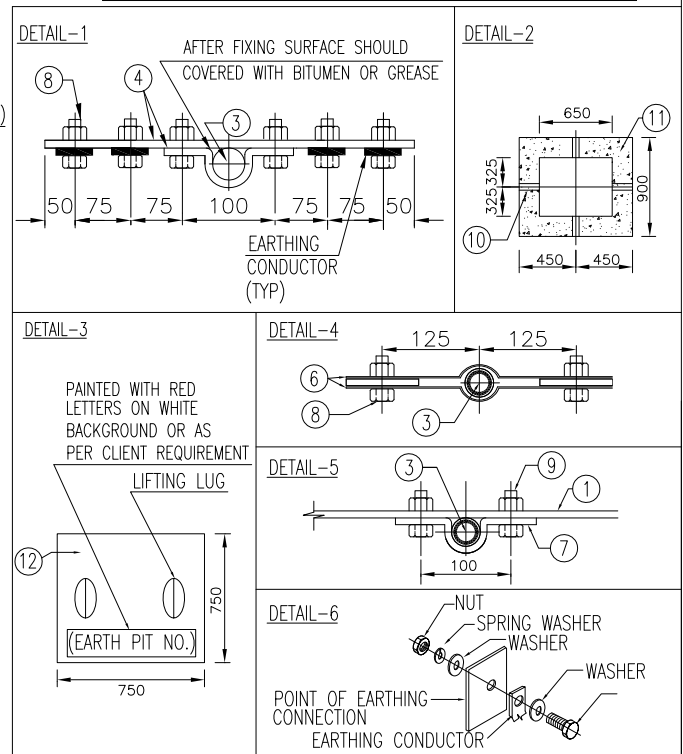


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Rev.	Date	Name		Date	Name		Date	Name		Description			Acc. Code					
		Drawn/Prepared				Checked												
BAR-Code										Store Location: Server/Share								
										Store Location: Folder								
										Store Name EEP4								
		Pro. Unit		TON			Group		Type of Document			Sheet 1 / 1						
		Con. Unit		Scale NTS		Order No.			 thyssenkrupp									
	Date	Name								Description								
Drawn	24/11/15	RDK								INSTALLATION STANDARDS – EARTHING								
Prepared	24/11/15	ANK								EARTH PIT WITH C.I. PLATE ELECTRODE								
Checked	24/11/15	RPM								FOR UNPAVED AREA (EEP4)								
Approved	24/11/15	RPM																

1		2		50 mm		3		4	
A	ITEM	DESCRIPTION				MATERIAL	QTY.	SUPPLY BY	INSTALLATION BY
	1	EARTHING PIPE – 3500mm LONG,100 DIA , 13mm THICK TAPERED AT ONE END, WITH 12 DIA THROUGH HOLES AT EVERY 75mm.				CAST IRON	1 NO.	ELECTRICAL CONTRACTOR	ELECTRICAL CONTRACTOR
	2	TEST LINK ASSEMBLY–50(W)X6(T), STRIP, BENT TO SHAPE OF ITEM–1, WITH 4 NOs 12 DIA HOLES AND ANOTHER STRIP WITH 6NOs 12 DIA HOLES(REFER DETAIL–1)				HDGI	1 SET	ELECTRICAL CONTRACTOR	ELECTRICAL CONTRACTOR
	3	FUNNEL, WITH WIRE MESH–SUITABLE FOR TACK WELDED TO TIP OF ITEM–1.				HDGI	1 NO.	ELECTRICAL CONTRACTOR	ELECTRICAL CONTRACTOR
	4	10 DIA HEXAGONAL HEAD BOLTS–60mm LONG, WITH NUTS,SPRING & PLAIN WASHERS, SUITABLE FOR CONNECTIONS SHOWN IN THIS DRAWING (REFER DETAIL–4)				GI	6 SETS	ELECTRICAL CONTRACTOR	ELECTRICAL CONTRACTOR
	5	PIPE SLEEVE–150 DIA, FOR ENTRY OF EARTHING CONDUCTOR (REFER DETAIL–2)				PVC	0.8MTRS	*CIVIL/ELECTRICAL CONTRACTOR	*CIVIL/ELECTRICAL CONTRACTOR
	6	EARTH PIT CHAMBER (TYPE B) REFER NOTE–3				REINFORCED CONCRETE	1 NO.	*CIVIL/ELECTRICAL CONTRACTOR	*CIVIL/ELECTRICAL CONTRACTOR
	7	EARTH PIT COVER (TYPE B) REFER NOTE–3				REINFORCED CONCRETE	1 NO.	*CIVIL/ELECTRICAL CONTRACTOR	*CIVIL/ELECTRICAL CONTRACTOR
8	CHARCOAL, SALT & SAND				–	1 LOT	ELECTRICAL CONTRACTOR	ELECTRICAL CONTRACTOR	

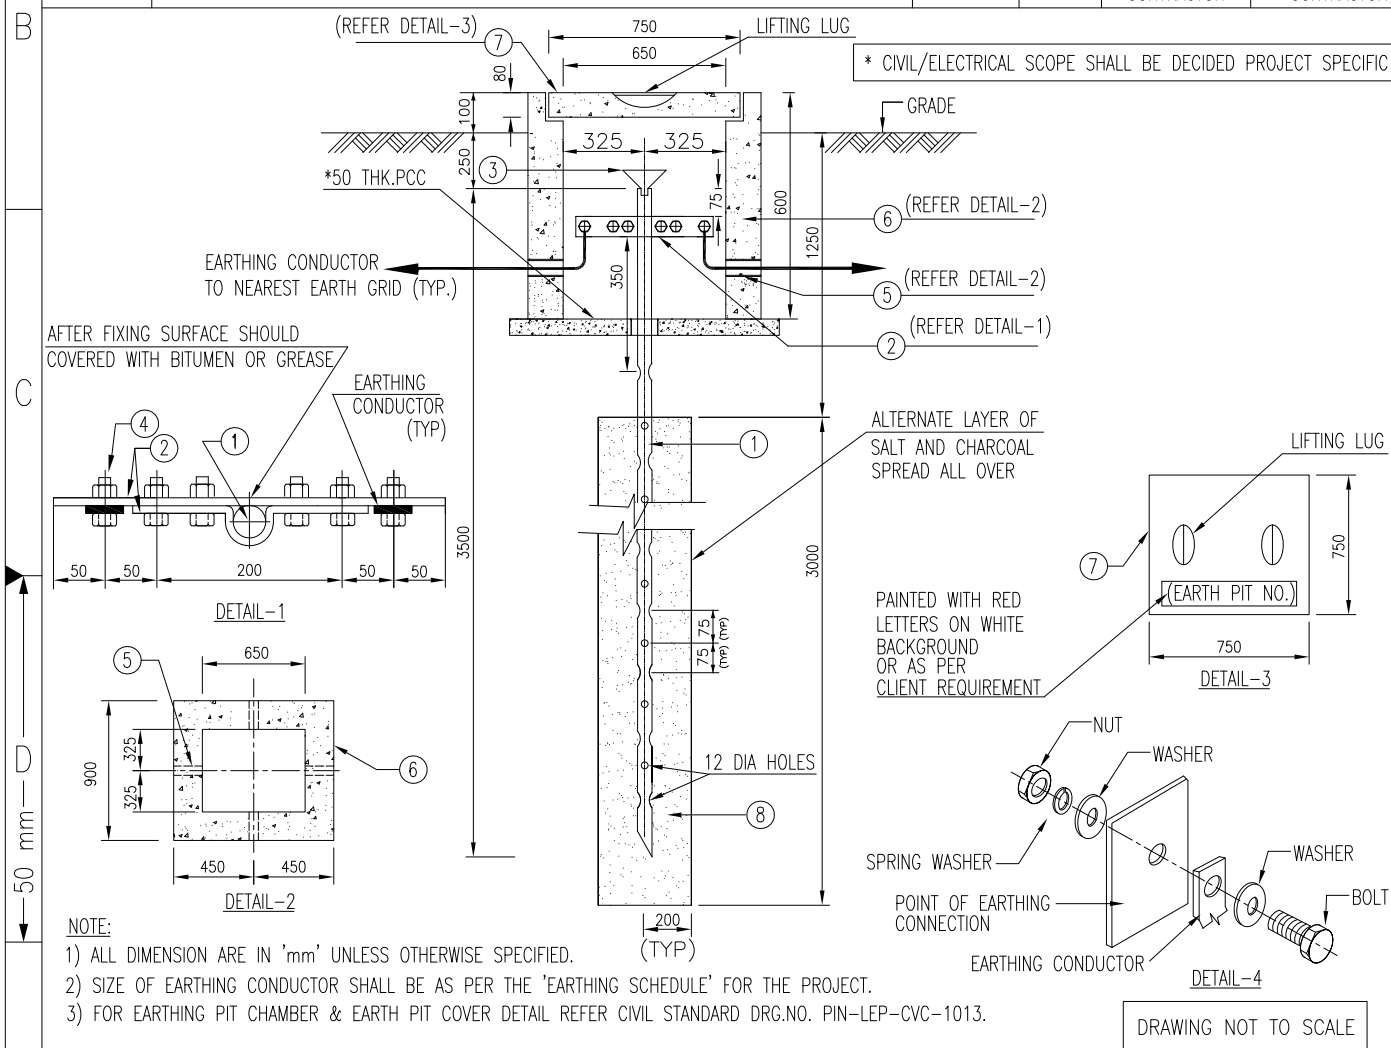



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Con. Unit		Scale NTS		Order No.			 thyssenkrupp												
	Date	Name		Description INSTALLATION STANDARDS – EARTHING EARTH PIT WITH CI PIPE ELECTRODE FOR UNPAVED AREA (EEP5)															
Drawn	24/11/15	RDK																	
Prepared	24/11/15	ANK																	
Checked	24/11/15	RPM																	
Approved	24/11/15	RPM																	

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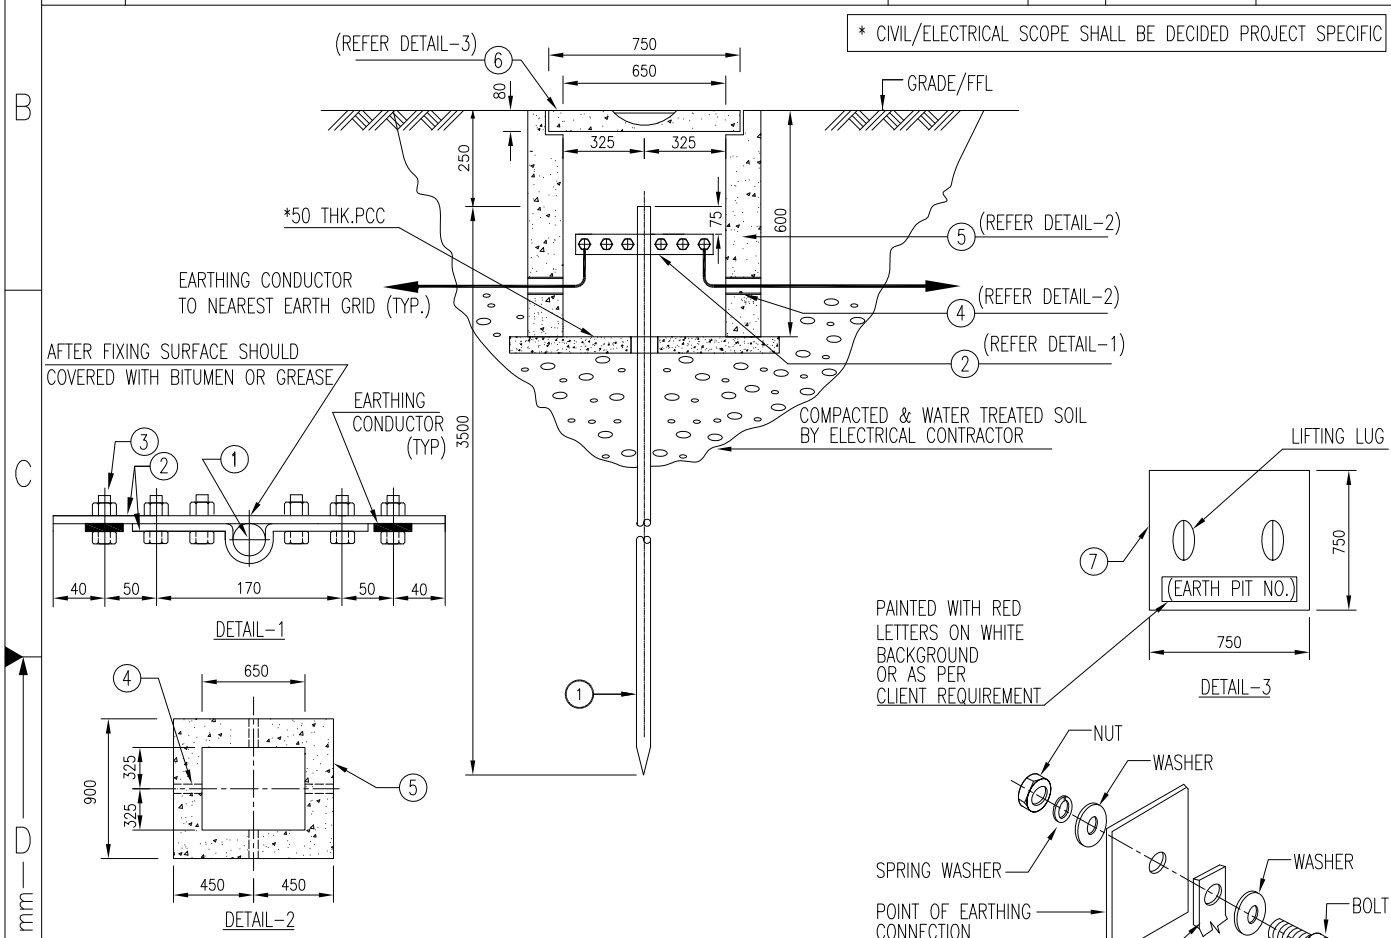
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		Con. Unit	Scale NTS	Order No.	 thyssenkrupp	

ISO A4		Date	Name	Description INSTALLATION STANDARDS – EARTHING EARTH PIT WITH GI PIPE ELECTRODE FOR PAVED AREA WITHOUT FORKLIFT MOVEMENT (EEP6)
	Drawn	24/11/15	RDK	
	Prepared	24/11/15	ANK	
	Checked	24/11/15	RPM	
	Approved	24/11/15	RPM	

A	1	2	50 mm	3	4		
	ITEM	DESCRIPTION	MATERIAL	QTY.	SUPPLY BY	INSTALLATION BY	
	1	EARTHING ROD, 19 DIA, 3500mm LONG	COPPER COATED STEEL	1NO.	ELECTRICAL CONTRACTOR	ELECTRICAL CONTRACTOR	
	2	TEST LINK ASSEMBLY-50(W)x6(T), STRIP, BENT TO SHAPE OF ITEM-1, WITH 4 NOS 12 DIA HOLES AND ANOTHER STRIP WITH 6NOS 12 DIA HOLES(REFER DETAIL-1)	COPPER COATED STEEL	1 SET	ELECTRICAL CONTRACTOR	ELECTRICAL CONTRACTOR	
	3	10 DIA HEXAGONAL HEAD BOLTS-60mm LONG, WITH NUTS,SPRING & PLAIN WASHERS, SUITABLE FOR CONNECTIONS SHOWN IN THIS DRAWING (REFER DETAIL-4)	SS304	6 SETS	ELECTRICAL CONTRACTOR	ELECTRICAL CONTRACTOR	
	4	PIPE SLEEVE-150 DIA, FOR ENTRY OF EARTHING CONDUCTOR (REFER DETAIL-2)	PVC	0.8MTRS	*CIVIL/ELECTRICAL CONTRACTOR	*CIVIL/ELECTRICAL CONTRACTOR	
	5	EARTH PIT CHAMBER (TYPE A) REFER NOTE-3	REINFORCED CONCRETE	1NO.	*CIVIL/ELECTRICAL CONTRACTOR	*CIVIL/ELECTRICAL CONTRACTOR	
	6	EARTH PIT COVER (TYPE A) REFER NOTE-3	REINFORCED CONCRETE	1NO.	*CIVIL/ELECTRICAL CONTRACTOR	*CIVIL/ELECTRICAL CONTRACTOR	

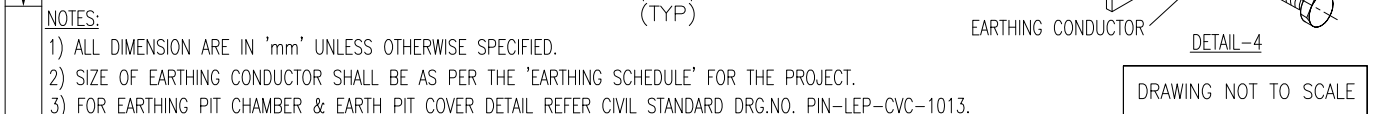


NOTES

- 1) ALL DIMENSION ARE IN 'mm' UNLESS OTHERWISE SPECIFIED.
- 2) SIZE OF EARTHING CONDUCTOR SHALL BE AS PER THE 'EARTHING SCHEDULE' FOR THE PROJECT.
- 3) IN GENERAL THE TOTAL LENGTH OF THE ROD ELECTRODE SHALL BE 3.5MTRS. IF ELECTRODES ARE TO BE DRIVEN DEEPER THAN 3.5MTRS, THIS REQUIREMENT SHALL BE SPECIFICALLY MENTIONED IN THE 'EARTHING LAYOUT' FOR THE PROJECT & THE SAME SHALL BE FOLLOWED DURING INSTALLATION.
- 4) FOR EARTHING PIT CHAMBER & EARTH PIT COVER DETAIL REFER CIVIL STANDARD DRG.NO. PIN-LEP-CVC-1013.

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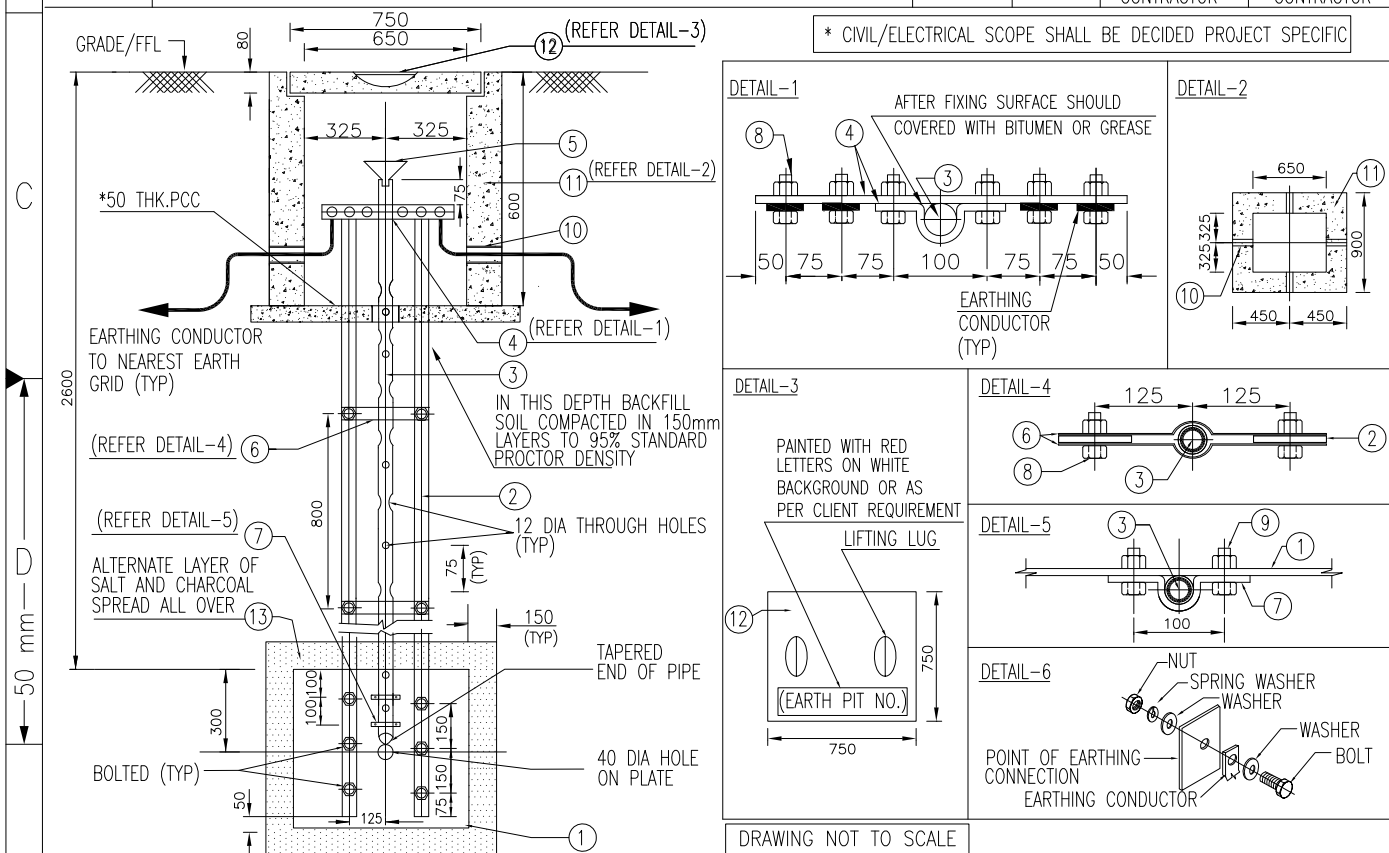
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Con. Unit		Scale NTS		Order No.			 thyssenkrupp												

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	Date	Name	Description INSTALLATION STANDARDS – EARTHING EARTH PIT WITH DEEP ROD ELECTRODE FOR PAVED AREA WITHOUT FORKLIFT MOVEMENT (EEP7)
Drawn	24/11/15	RDK	
Prepared	24/11/15	ANK	
Checked	24/11/15	RPM	
Approved	24/11/15	RPM	

ISO A4


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ITEM	DESCRIPTION			MATERIAL	QTY.	SUPPLY BY	INSTALLATION BY	
A	1	EARTHING PLATE-600(L)X600(W)X6.3(T), WITH 40 DIA HOLE AT CENTRE.			HDGI	1 NO	ELECTRICAL CONTRACTOR	ELECTRICAL CONTRACTOR
	2	EARTHING STRIP-50(W)X12(T), WITH 12 DIA HOLES.			HDGI	AS REQUIRED	ELECTRICAL CONTRACTOR	ELECTRICAL CONTRACTOR
	3	PIPE - 50 DIA N.B., CLASS-B, TAPERED AT ONE END, WITH 12 DIA THROUGH HOLES AT EVERY 75mm.			HDGI	AS REQUIRED	ELECTRICAL CONTRACTOR	ELECTRICAL CONTRACTOR
	4	TEST LINK ASSEMBLY-50(W)X12(T), STRIP, BENT TO SHAPE OF ITEM-1, WITH 4 NOs 12 DIA HOLES AND ANOTHER STRIP WITH 6NOs 12 DIA HOLES(REFER DETAIL-1)			HDGI	1 SET	ELECTRICAL CONTRACTOR	ELECTRICAL CONTRACTOR
	5	FUNNEL, WITH WIRE MESH-SUITABLE FOR TACK WELDED TO TIP OF ITEM-3.			HDGI	1 NO	ELECTRICAL CONTRACTOR	ELECTRICAL CONTRACTOR
B	6	CLAMPS-25(W)X3(T) STRIP BENT TO SHAPE OF ITEM-3, WITH 2 NOs 12 DIA HOLES.			HDGI	4 NOs	ELECTRICAL CONTRACTOR	ELECTRICAL CONTRACTOR
	7	CLAMPS-25(W)X3(T) STRIP BENT TO SHAPE OF ITEM-3, WITH 2 NOs 10 DIA HOLES.			HDGI	2 NOs	ELECTRICAL CONTRACTOR	ELECTRICAL CONTRACTOR
	8	12 DIA HEXAGONAL HEAD BOLTS-60mm LONG, WITH NUTS & WASHERS, SUITABLE FOR CONNECTIONS SHOWN IN THIS DRAWING (REFER DETAIL-6)			GI	16 SETS	ELECTRICAL CONTRACTOR	ELECTRICAL CONTRACTOR
	9	10 DIA HEXAGONAL HEAD BOLTS-40mm LONG WITH NUTS & WASHERS, SUITABLE FOR CONNECTIONS SHOWN IN THIS DRAWING (REFER DETAIL-6)			GI	4 SETS	ELECTRICAL CONTRACTOR	ELECTRICAL CONTRACTOR
	10	PIPE SLEEVE-150 DIA, FOR ENTRY OF EARTHING CONDUCTOR (REFER DETAIL-2)			PVC	0.8 MTRS	*CIVIL/ELECTRICAL CONTRACTOR	*CIVIL/ELECTRICAL CONTRACTOR
	11	EARTH PIT CHAMBER (TYPE A) FOR DETAIL REFER CIVIL STANDARD DRG.NO. PIN-LEP-CVC-1013.			REINFORCED CONCRETE	1 NO	*CIVIL/ELECTRICAL CONTRACTOR	*CIVIL/ELECTRICAL CONTRACTOR
	12	EARTH PIT COVER (TYPE A) FOR DETAIL REFER CIVIL STANDARD DRG.NO. PIN-LEP-CVC-1013.			REINFORCED CONCRETE	1 NO	*CIVIL/ELECTRICAL CONTRACTOR	*CIVIL/ELECTRICAL CONTRACTOR
	13	CHARCOAL AND SALT			-	1 LOT	ELECTRICAL CONTRACTOR	ELECTRICAL CONTRACTOR



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ISO A4

Code				Contract No.				Document ID				PIN-LEP-ELT-4002				Part		Rev.	
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	Date	Name		Description															
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Prepared	24/11/15	ANK		EARTH PIT WITH HDGI PLATE ELECTRODE															
Checked	24/11/15	RPM		FOR PAVED AREA															
Approved	24/11/15	RPM		WITHOUT FORKLIFT MOVEMENT (EEP8)															

GRADE/FFL

80

750

650

12 (REFER DETAIL-3)

325

325

5

11 (REFER DETAIL-2)

10

*50 THK.PCC

600

75

4 (REFER DETAIL-1)

3

IN THIS DEPTH BACKFILL SOIL COMPACTED IN 150mm LAYERS TO 95% STANDARD PROCTOR DENSITY

2

12 DIA THROUGH HOLES (TYP)

75 (TYP)

800

6

7

13

ALTERNATE LAYER OF SALT AND CHARCOAL SPREAD ALL OVER

150 (TYP)

TAPERED END OF PIPE

40 DIA HOLE ON PLATE

1

600

50

125

200±200

250±50±250±50

25

125

COVERED WITH BITUMEN OR GREASE

8

4

3

50

75

75

100

75

75

50

EARTHING CONDUCTOR (TYP)

650

325

325

900

450

450

10

11

DETAIL-3

PAINTED WITH RED LETTERS ON WHITE BACKGROUND OR AS PER CLIENT REQUIREMENT

LIFTING LUG

12

750

750

(EARTH PIT NO.)

DETAIL-4

125

125

6

8

3

2

DETAIL-5

3

9

1

7

100

DETAIL-6

NUT

SPRING WASHER

WASHER

POINT OF EARTHING CONNECTION

EARTHING CONDUCTOR


WASHER


BOLT


DRAWING NOT TO SCALE

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ITEM	DESCRIPTION	MATERIAL	QTY.	SUPPLY BY	INSTALLATION BY
1	EARTHING PIPE - 3500mm LONG, 100 DIA, 13mm THICK TAPERED AT ONE END, WITH 12 DIA THROUGH HOLES AT EVERY 75mm.	CAST IRON	1 NO.	ELECTRICAL CONTRACTOR	ELECTRICAL CONTRACTOR
2	TEST LINK ASSEMBLY-50(W)x6(T), STRIP, BENT TO SHAPE OF ITEM-1, WITH 4 NOS 12 DIA HOLES AND ANOTHER STRIP WITH 6NOS 12 DIA HOLES(REFER DETAIL-1)	HDGI	1 SET	ELECTRICAL CONTRACTOR	ELECTRICAL CONTRACTOR
3	FUNNEL, WITH WIRE MESH-SUITABLE FOR TACK WELDED TO TIP OF ITEM-1.	HDGI	1 NO.	ELECTRICAL CONTRACTOR	ELECTRICAL CONTRACTOR
4	10 DIA HEXAGONAL HEAD BOLTS-60mm LONG, WITH NUTS, SPRING & PLAIN WASHERS, SUITABLE FOR CONNECTIONS SHOWN IN THIS DRAWING (REFER DETAIL-4)	GI	6 SETS	ELECTRICAL CONTRACTOR	ELECTRICAL CONTRACTOR
5	PIPE SLEEVE-150 DIA, FOR ENTRY OF EARTHING CONDUCTOR (REFER DETAIL-2)	PVC	0.8MTRS	*CIVIL/ELECTRICAL CONTRACTOR	*CIVIL/ELECTRICAL CONTRACTOR
6	EARTH PIT CHAMBER (TYPE A) REFER NOTE-3	REINFORCED CONCRETE	1 NO.	*CIVIL/ELECTRICAL CONTRACTOR	*CIVIL/ELECTRICAL CONTRACTOR
7	EARTH PIT COVER (TYPE A) REFER NOTE-3	REINFORCED CONCRETE	1 NO.	*CIVIL/ELECTRICAL CONTRACTOR	*CIVIL/ELECTRICAL CONTRACTOR
8	CHARCOAL, SALT & SAND	-	1 LOT	ELECTRICAL CONTRACTOR	ELECTRICAL CONTRACTOR

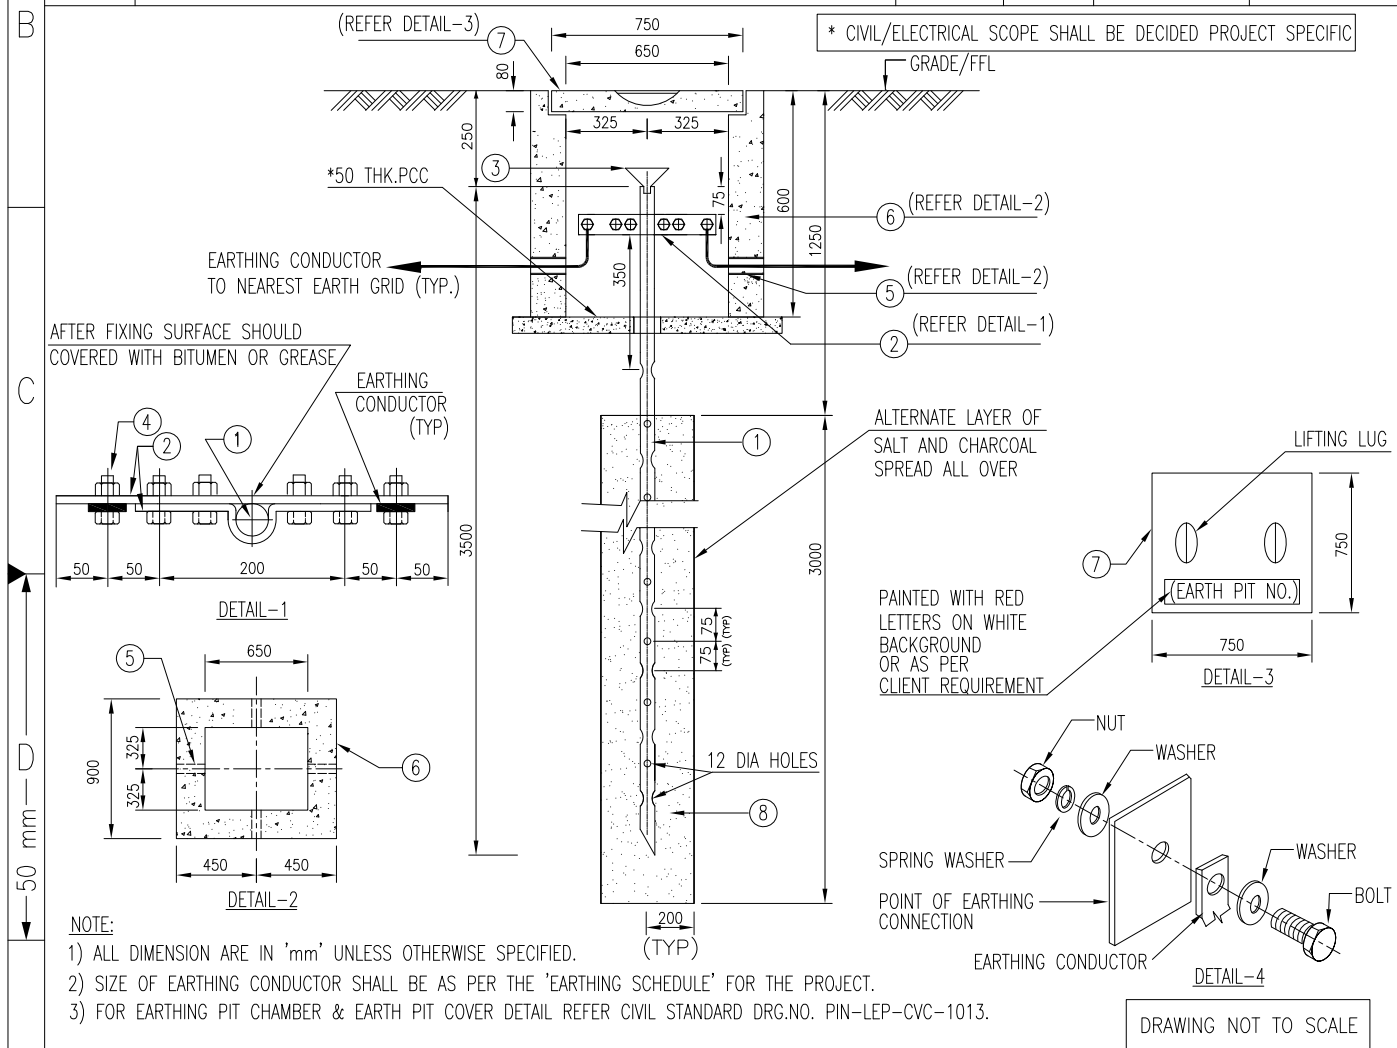


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ISO A4		Date	Name		Description INSTALLATION STANDARDS – EARTHING EARTH PIT WITH CI PIPE ELECTRODE FOR UNPAVED AREA WITHOUT FORKLIFT MOVEMENT (EEP10)													
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	Prepared	24/11/15	ANK															
	Checked	24/11/15	RPM															
	Approved	24/11/15	RPM															

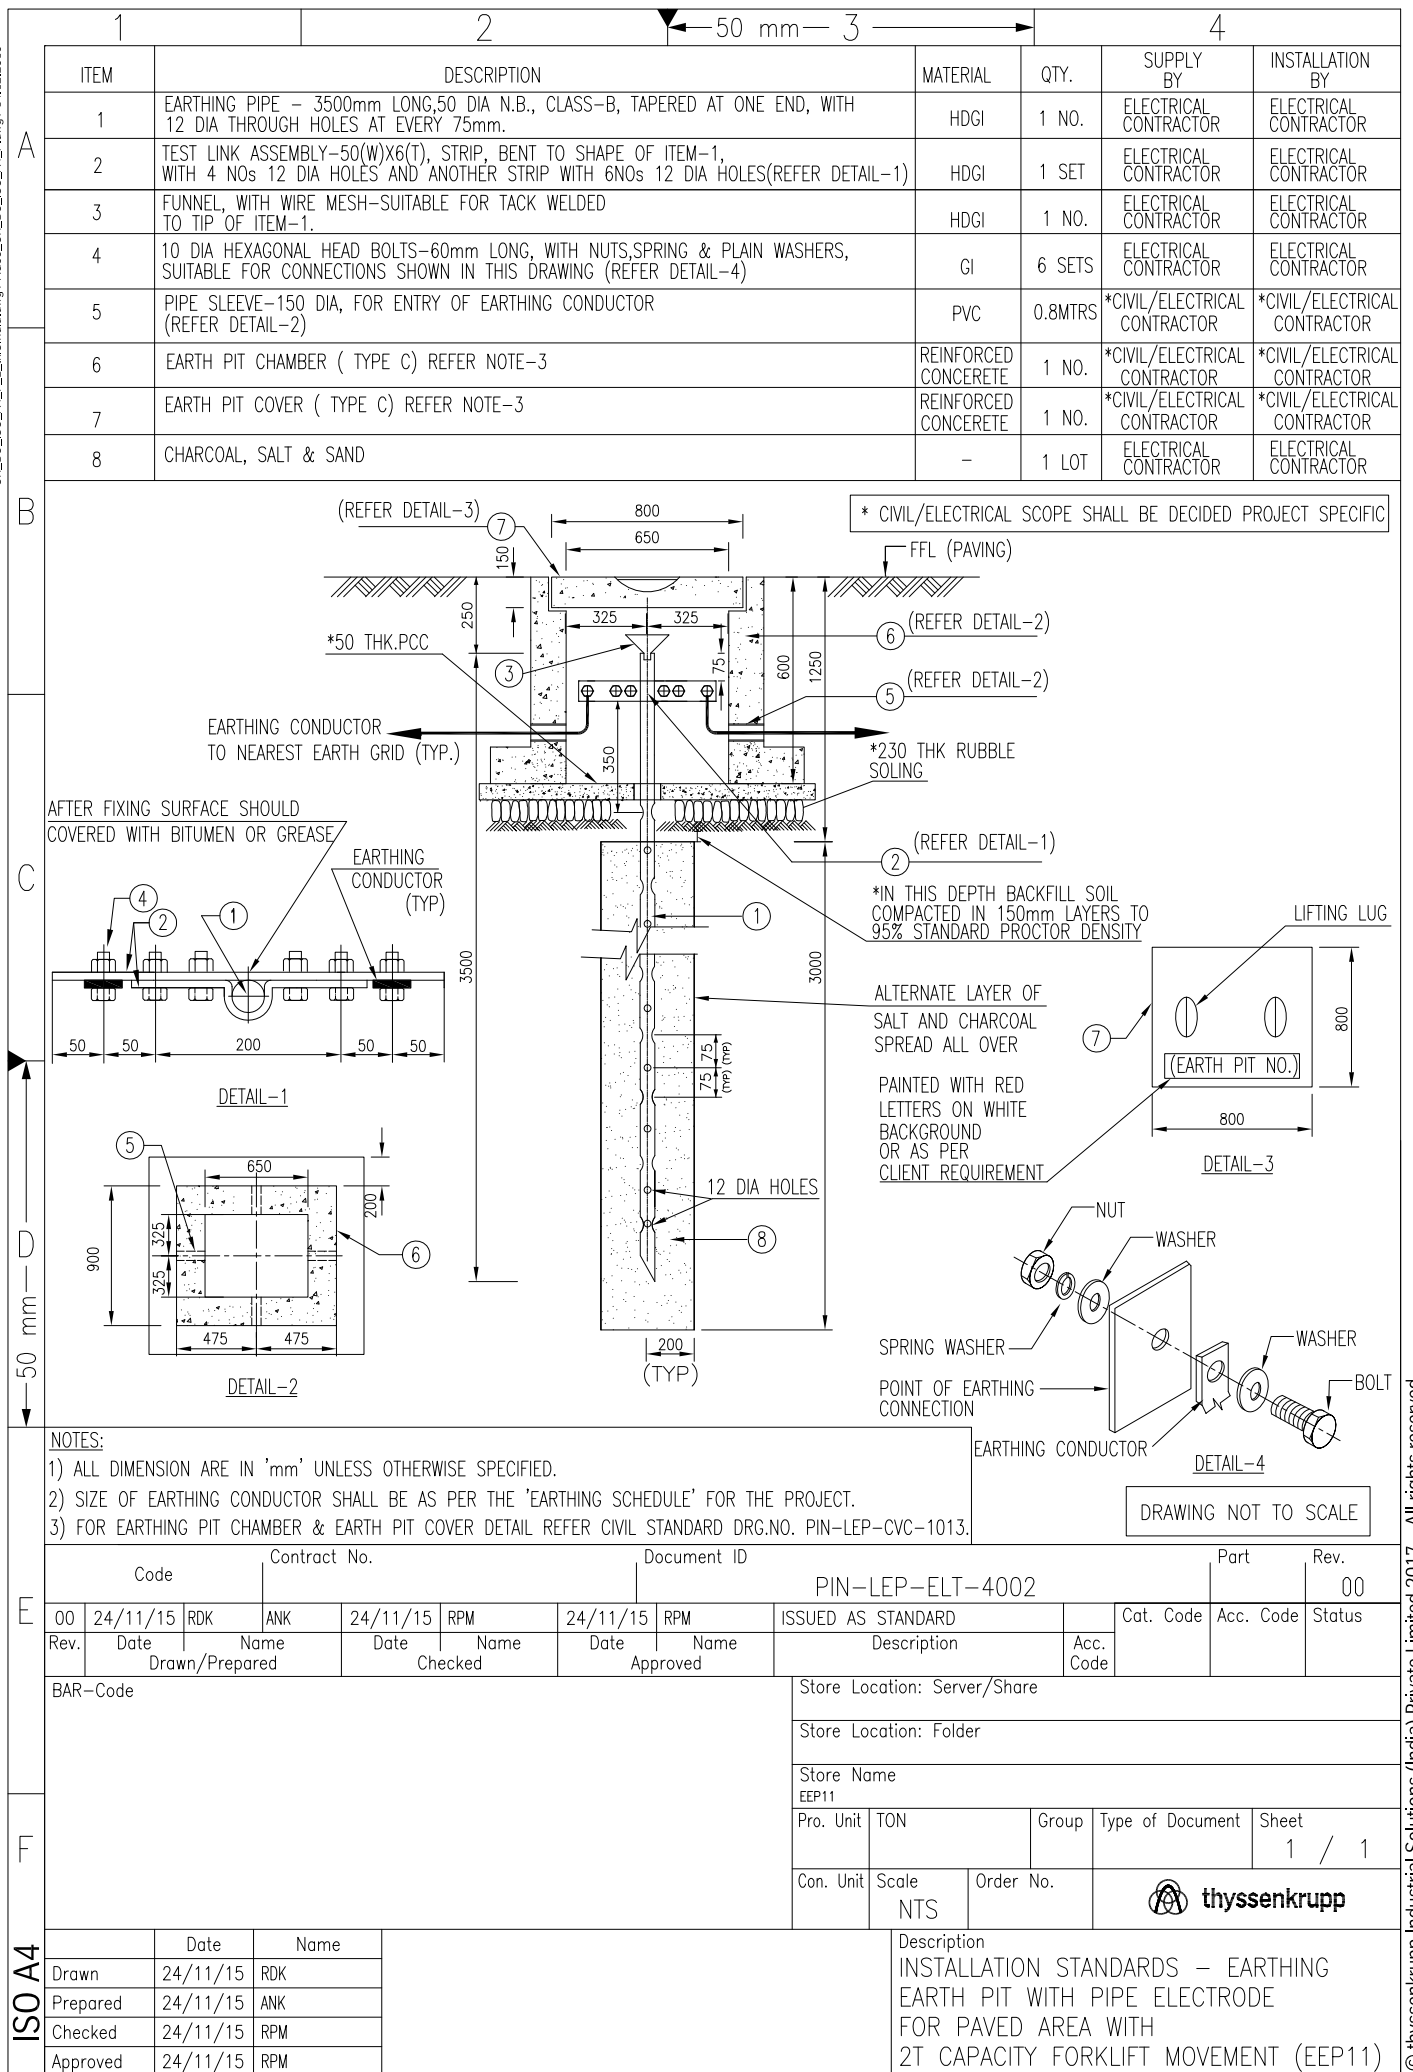

ITEM	DESCRIPTION	MATERIAL	QTY.	SUPPLY BY	INSTALLATION BY
1	EARTHING ROD, 19 DIA, 3500mm LONG	COPPER COATED STEEL	1NO.	ELECTRICAL CONTRACTOR	ELECTRICAL CONTRACTOR
2	TEST LINK ASSEMBLY-50(W)X6(T), STRIP, BENT TO SHAPE OF ITEM-1, WITH 4 NOS 12 DIA HOLES AND ANOTHER STRIP WITH 6NOS 12 DIA HOLES(REFER DETAIL-1)	COPPER COATED STEEL	1 SET	ELECTRICAL CONTRACTOR	ELECTRICAL CONTRACTOR
3	10 DIA HEXAGONAL HEAD BOLTS-60mm LONG, WITH NUTS, SPRING & PLAIN WASHERS, SUITABLE FOR CONNECTIONS SHOWN IN THIS DRAWING (REFER DETAIL-4)	SS304	6 SETS	ELECTRICAL CONTRACTOR	ELECTRICAL CONTRACTOR
4	PIPE SLEEVE-150 DIA, FOR ENTRY OF EARTHING CONDUCTOR (REFER DETAIL-2)	PVC	0.8MTRS	*CIVIL/ELECTRICAL CONTRACTOR	*CIVIL/ELECTRICAL CONTRACTOR
5	EARTH PIT CHAMBER (TYPE C) REFER NOTE-4	REINFORCED CONCRETE	1NO.	*CIVIL/ELECTRICAL CONTRACTOR	*CIVIL/ELECTRICAL CONTRACTOR
6	EARTH PIT COVER (TYPE C) REFER NOTE-4	REINFORCED CONCRETE	1NO.	*CIVIL/ELECTRICAL CONTRACTOR	*CIVIL/ELECTRICAL CONTRACTOR


* CIVIL/ELECTRICAL SCOPE SHALL BE DECIDED PROJECT SPECIFIC

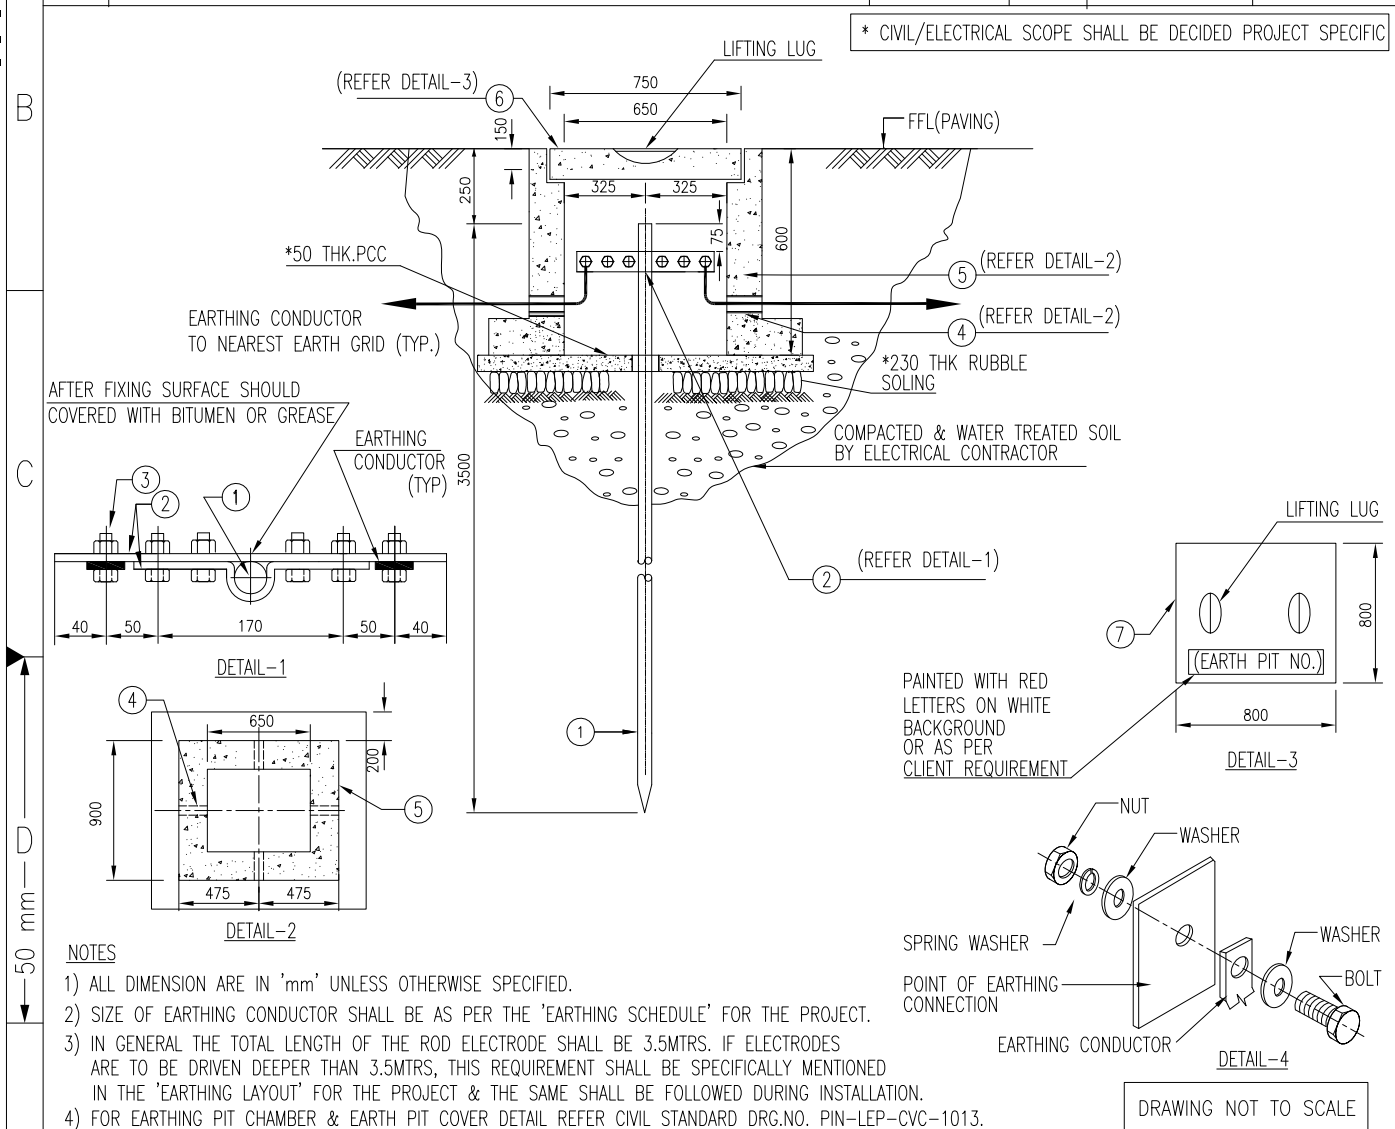

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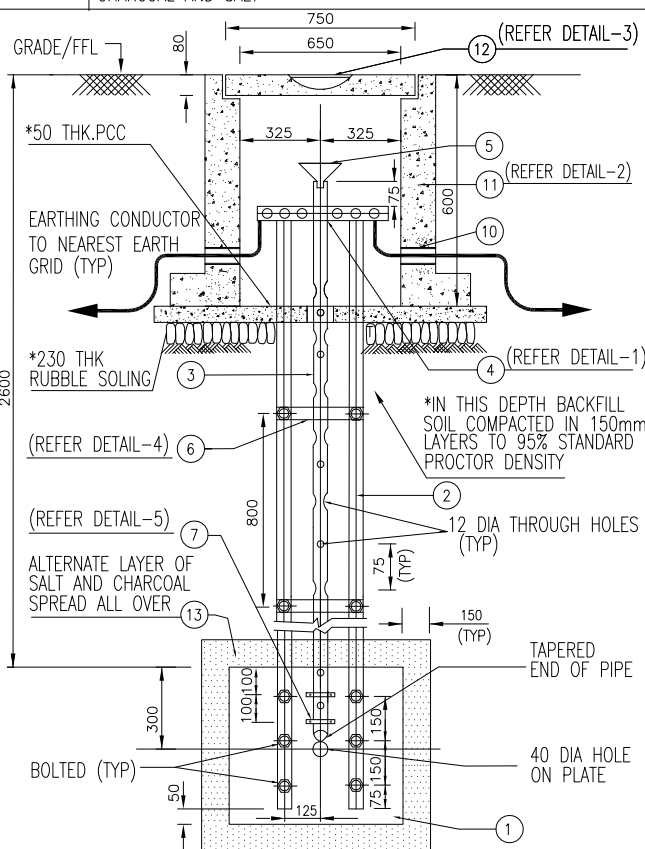
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		NTS																	
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Drawn	24/11/15	RDK		INSTALLATION STANDARDS – EARTHING															
Prepared	24/11/15	ANK		EARTH PIT WITH DEEP ROD ELECTRODE															
Checked	24/11/15	RPM		FOR PAVED AREA WITH															
Approved	24/11/15	RPM		2T CAPACITY FORKLIFT MOVEMENT (EEP12)															



ISO A4

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ITEM	DESCRIPTION	MATERIAL	QTY.	SUPPLY BY	INSTALLATION BY		
1	EARTHING PLATE-600(L)X600(W)X6.3(T), WITH 40 DIA HOLE AT CENTRE.	HDGI	1 NO	ELECTRICAL CONTRACTOR	ELECTRICAL CONTRACTOR		
2	EARTHING STRIP-50(W)X12(T), WITH 12 DIA HOLES.	HDGI	AS REQUIRED	ELECTRICAL CONTRACTOR	ELECTRICAL CONTRACTOR		
3	PIPE - 50 DIA N.B., CLASS-B, TAPERED AT ONE END, WITH 12 DIA THROUGH HOLES AT EVERY 75mm.	HDGI	AS REQUIRED	ELECTRICAL CONTRACTOR	ELECTRICAL CONTRACTOR		
4	TEST LINK ASSEMBLY-50(W)X12(T), STRIP, BENT TO SHAPE OF ITEM-1, WITH 4 NOs 12 DIA HOLES AND ANOTHER STRIP WITH 6NOs 12 DIA HOLES(REFER DETAIL-1)	HDGI	1 SET	ELECTRICAL CONTRACTOR	ELECTRICAL CONTRACTOR		
5	FUNNEL, WITH WIRE MESH-SUITABLE FOR TACK WELDED TO TIP OF ITEM-3.	HDGI	1 NO	ELECTRICAL CONTRACTOR	ELECTRICAL CONTRACTOR		
6	CLAMPS-25(W)X3(T) STRIP BENT TO SHAPE OF ITEM-3, WITH 2 NOs 12 DIA HOLES.	HDGI	4 NOs	ELECTRICAL CONTRACTOR	ELECTRICAL CONTRACTOR		
7	CLAMPS-25(W)X3(T) STRIP BENT TO SHAPE OF ITEM-3, WITH 2 NOs 10 DIA HOLES.	HDGI	2 NOs	ELECTRICAL CONTRACTOR	ELECTRICAL CONTRACTOR		
8	12 DIA HEXAGONAL HEAD BOLTS-60mm LONG, WITH NUTS & WASHERS, SUITABLE FOR CONNECTIONS SHOWN IN THIS DRAWING (REFER DETAIL-6)	GI	16 SETS	ELECTRICAL CONTRACTOR	ELECTRICAL CONTRACTOR		
9	10 DIA HEXAGONAL HEAD BOLTS-40mm LONG WITH NUTS & WASHERS, SUITABLE FOR CONNECTIONS SHOWN IN THIS DRAWING (REFER DETAIL-6)	GI	4 SETS	ELECTRICAL CONTRACTOR	ELECTRICAL CONTRACTOR		
10	PIPE SLEEVE-150 DIA, FOR ENTRY OF EARTHING CONDUCTOR (REFER DETAIL-2)	PVC	0.8 MTRS	*CIVIL/ELECTRICAL CONTRACTOR	*CIVIL/ELECTRICAL CONTRACTOR		
11	EARTH PIT CHAMBER (TYPE C) FOR DETAIL REFER CIVIL STANDARD DRG.NO. PIN-LEP-CVC-1013.	REINFORCED CONCRETE	1 NO	*CIVIL/ELECTRICAL CONTRACTOR	*CIVIL/ELECTRICAL CONTRACTOR		
12	EARTH PIT COVER (TYPE C) FOR DETAIL REFER CIVIL STANDARD DRG.NO. PIN-LEP-CVC-1013.	REINFORCED CONCRETE	1 NO	*CIVIL/ELECTRICAL CONTRACTOR	*CIVIL/ELECTRICAL CONTRACTOR		
13	CHARCOAL AND SALT	-	1 LOT	ELECTRICAL CONTRACTOR	ELECTRICAL CONTRACTOR		




* CIVIL/ELECTRICAL SCOPE SHALL BE DECIDED PROJECT SPECIFIC

DETAIL-1

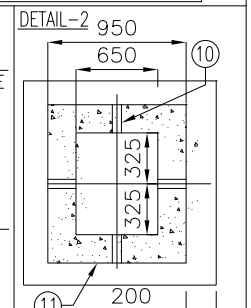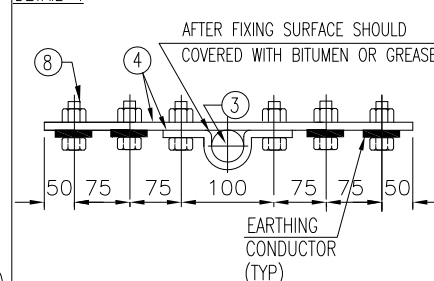


DETAIL-3

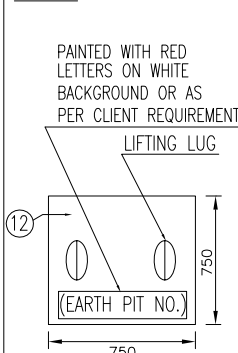



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DETAIL-4

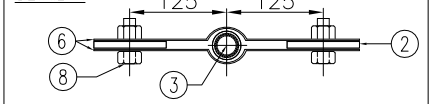

DETAIL - 5



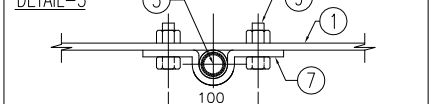
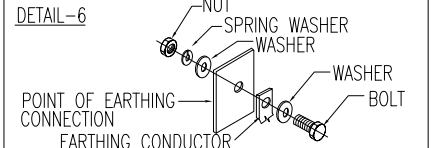
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
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Store Location: Server/Share

Store Location: Folder

Store Name	EEP13
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Pro. Unit	TON	Group	Type of Document	Sheet 1 / 1
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Con. Unit	Scale NTS	Order No.	 thyssenkrupp
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	Description
	INSTALLATION STANDARDS – EARTHING EARTH PIT WITH HDGI PLATE ELECTRODE FOR PAVED AREA WITH 2T CAPACITY FORKLIFT (EEP13)

MAIN EARTH PIT DETAIL:

- GRADE/FFL** (Finish Floor Level) is indicated at the top.
- *50 THK. PCC** (50mm thick Portland Cement Concrete) is shown at the base.
- EARTHING CONDUCTOR TO NEAREST EARTH GRID (TYP)** is shown connecting to the base.
- *230 THK RUBBLE SOLING** (230mm thick rubble soling) is shown below the PCC.
- *IN THIS DEPTH BACKFILL SOIL COMPACTED IN 150mm LAYERS TO 95% STANDARD PROCTOR DENSITY** is shown in the central shaft.
- 12 DIA THROUGH HOLES (TYP)** are shown in the shaft walls.
- ALTERNATE LAYER OF SALT AND CHARCOAL SPREAD ALL OVER** is shown in the shaft.
- 40 DIA HOLE ON PLATE** is shown at the bottom.
- TAPERED END OF PIPE** is shown at the bottom.
- 200/200** (200mm x 200mm) is shown for the bottom plate.
- 250/250** (250mm x 250mm) is shown for the bottom plate.
- 125** (125mm) is shown for the bottom plate.
- 150 (TYP)** (150mm typical) is shown for the bottom plate.
- 75 (TYP)** (75mm typical) is shown for the bottom plate.
- 25** (25mm) is shown for the bottom plate.
- 50** (50mm) is shown for the bottom plate.
- 600** (600mm) is shown for the bottom plate.
- 2000** (2000mm) is shown for the total height.
- 750** (750mm) is shown for the width.
- 650** (650mm) is shown for the width.
- 325** (325mm) is shown for the width.
- 325** (325mm) is shown for the width.
- 75** (75mm) is shown for the width.
- 600** (600mm) is shown for the height.
- 80** (80mm) is shown for the height.
- 12** (12mm) is shown for the diameter.
- 5** (5mm) is shown for the diameter.
- 11** (11mm) is shown for the diameter.
- 10** (10mm) is shown for the diameter.
- 4** (4mm) is shown for the diameter.
- 3** (3mm) is shown for the diameter.
- 6** (6mm) is shown for the diameter.
- 7** (7mm) is shown for the diameter.
- 13** (13mm) is shown for the diameter.
- 1** (1mm) is shown for the diameter.
- (REFER DETAIL-1)** is shown for the bottom plate.
- (REFER DETAIL-2)** is shown for the bottom plate.
- (REFER DETAIL-3)** is shown for the bottom plate.
- (REFER DETAIL-4)** is shown for the bottom plate.
- (REFER DETAIL-5)** is shown for the bottom plate.


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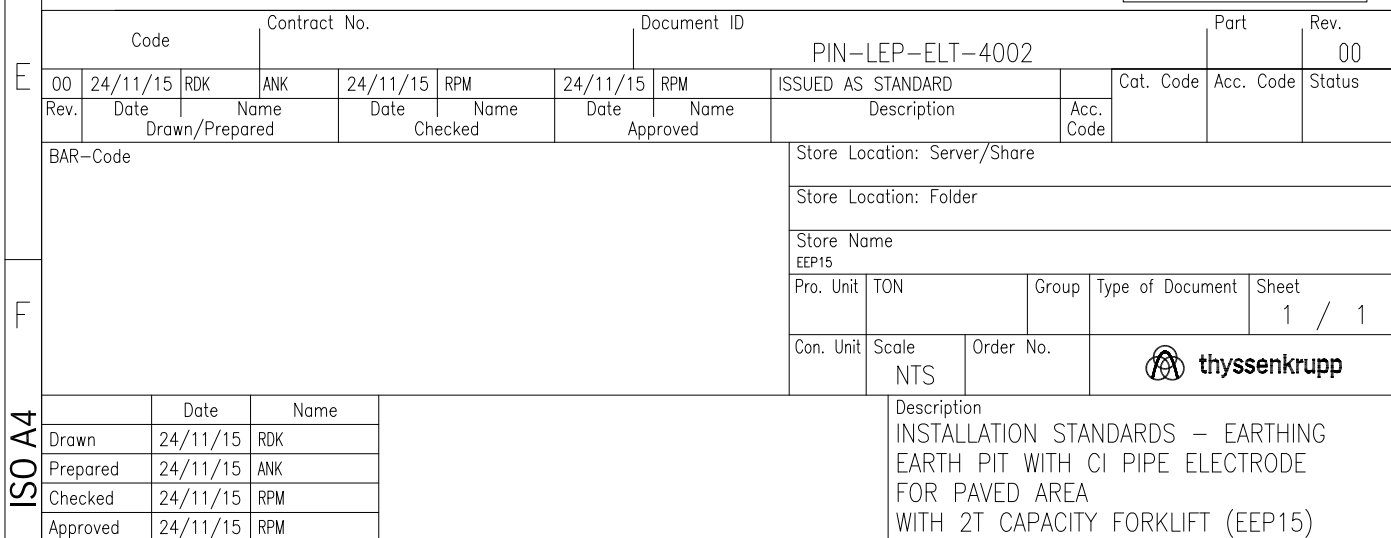
- DETAIL-1:** Shows the top view of the earth pit with dimensions: 750, 650, 325, 325, 75, 600, 80, 12, 5, 11, 10, 4, 3, 6, 7, 13, 1. It also shows the text: "AFTER FIXING SURFACE SHOULD COVERED WITH BITUMEN OR GREASE" and "EARTHING CONDUCTOR (TYP)".
- DETAIL-2:** Shows the side view of the earth pit with dimensions: 950, 650, 325, 325, 75, 600, 80, 12, 5, 11, 10, 4, 3, 6, 7, 13, 1.
- DETAIL-3:** Shows the bottom view of the earth pit with dimensions: 750, 650, 325, 325, 75, 600, 80, 12, 5, 11, 10, 4, 3, 6, 7, 13, 1.
- DETAIL-4:** Shows the top view of the earth pit with dimensions: 125, 125, 75, 600, 80, 12, 5, 11, 10, 4, 3, 6, 7, 13, 1.
- DETAIL-5:** Shows the side view of the earth pit with dimensions: 125, 125, 75, 600, 80, 12, 5, 11, 10, 4, 3, 6, 7, 13, 1.
- DETAIL-6:** Shows the bottom view of the earth pit with dimensions: 750, 650, 325, 325, 75, 600, 80, 12, 5, 11, 10, 4, 3, 6, 7, 13, 1.

LEGEND:


- PAINTED WITH RED LETTERS ON WHITE BACKGROUND OR AS PER CLIENT REQUIREMENT**
- LIFTING LUG**
- (EARTH PIT NO.)**
- NUT**
- SPRING WASHER**
- WASHER**
- POINT OF EARTHING CONNECTION**
- EARTHING CONDUCTOR**
- WASHER**
- BOLT**

DRAWING NOT TO SCALE


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Rev.	Date	Name		Date	Name		Date	Name		Description			Acc. Code		
		Drawn/Prepared				Checked				Approved					
BAR-Code										Store Location: Server/Share					
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										Store Name EEP14					
								Pro. Unit		TON		Group	Type of Document		Sheet 1 / 1
								Con. Unit		Scale NTS		Order No.		 thyssenkrupp	
	Date	Name								Description					
Drawn	24/11/15	RDK								INSTALLATION STANDARDS – EARTHING					
Prepared	24/11/15	ANK								EARTH PIT WITH CI PLATE ELECTRODE					
Checked	24/11/15	RPM								FOR PAVED AREA					
Approved	24/11/15	RPM								WITH 2T CAPACITY FORKLIFT (EEP14)					



1		2		3		4	
ITEM	DESCRIPTION	MATERIAL	QTY.	SUPPLY BY	INSTALLATION BY		
A	1	EARTHING PLATE-600(L)X600(W)X3(T), WITH 50 DIA HOLE AT CENTRE.	CU	1 NO	ELECTRICAL CONTRACTOR	ELECTRICAL CONTRACTOR	
	2	EARTHING STRIP-35(W)X6(T), WITH 12 DIA HOLES.	CU	AS REQUIRED	ELECTRICAL CONTRACTOR	ELECTRICAL CONTRACTOR	
	3	PIPE - 50 DIA N.B., CLASS-B, TAPERED AT ONE END, WITH 12 DIA THROUGH HOLES AT EVERY 75mm.	HDGI	AS REQUIRED	ELECTRICAL CONTRACTOR	ELECTRICAL CONTRACTOR	
	4	TEST LINK ASSEMBLY-35(W)X6(T), STRIP, BENT TO SHAPE OF ITEM-1, WITH 2 NOs 12 DIA HOLES AND ANOTHER STRIP WITH 6NOs 12 DIA HOLES(REFER DETAIL-1)	CU	1 SET	ELECTRICAL CONTRACTOR	ELECTRICAL CONTRACTOR	
	5	FUNNEL, WITH WIRE MESH-SUITABLE FOR TACK WELDED TO TIP OF ITEM-3.	HDGI	1 NO	ELECTRICAL CONTRACTOR	ELECTRICAL CONTRACTOR	
B	6	CLAMPS-25(W)X4(T) STRIP BENT TO SHAPE OF ITEM-3, WITH 2 NOs 12 DIA HOLES.	CU	4 NOs	ELECTRICAL CONTRACTOR	ELECTRICAL CONTRACTOR	
	7	CLAMPS-25(W)X4(T) STRIP BENT TO SHAPE OF ITEM-3, WITH 2 NOs 10 DIA HOLES.	CU	2 NOs	ELECTRICAL CONTRACTOR	ELECTRICAL CONTRACTOR	
	8	12 DIA HEXAGONAL HEAD BOLTS-40mm LONG, WITH NUTS & WASHERS, SUITABLE FOR CONNECTIONS SHOWN IN THIS DRAWING (REFER DETAIL-6)	BRASS	AS REQUIRED	ELECTRICAL CONTRACTOR	ELECTRICAL CONTRACTOR	
	9	10 DIA HEXAGONAL HEAD BOLTS-30mm LONG WITH NUTS & WASHERS, SUITABLE FOR CONNECTIONS SHOWN IN THIS DRAWING (REFER DETAIL-6)	BRASS	AS REQUIRED	ELECTRICAL CONTRACTOR	ELECTRICAL CONTRACTOR	
	10	PIPE SLEEVE-150 DIA, FOR ENTRY OF EARTHING CONDUCTOR (REFER DETAIL-2)	PVC	0.8 MTRS	*CIVIL/ELECTRICAL CONTRACTOR	*CIVIL/ELECTRICAL CONTRACTOR	
	11	EARTH PIT CHAMBER (TYPE A) FOR DETAIL REFER CIVIL STANDARD DRG.NO. PIN-LEP-CVC-1013.	REINFORCED CONCRETE	1 NO	*CIVIL/ELECTRICAL CONTRACTOR	*CIVIL/ELECTRICAL CONTRACTOR	
	12	EARTH PIT COVER (TYPE A) FOR DETAIL REFER CIVIL STANDARD DRG.NO. PIN-LEP-CVC-1013.	REINFORCED CONCRETE	1 NO	*CIVIL/ELECTRICAL CONTRACTOR	*CIVIL/ELECTRICAL CONTRACTOR	
	13	CHARCOAL AND SALT	-	1 LOT	ELECTRICAL CONTRACTOR	ELECTRICAL CONTRACTOR	

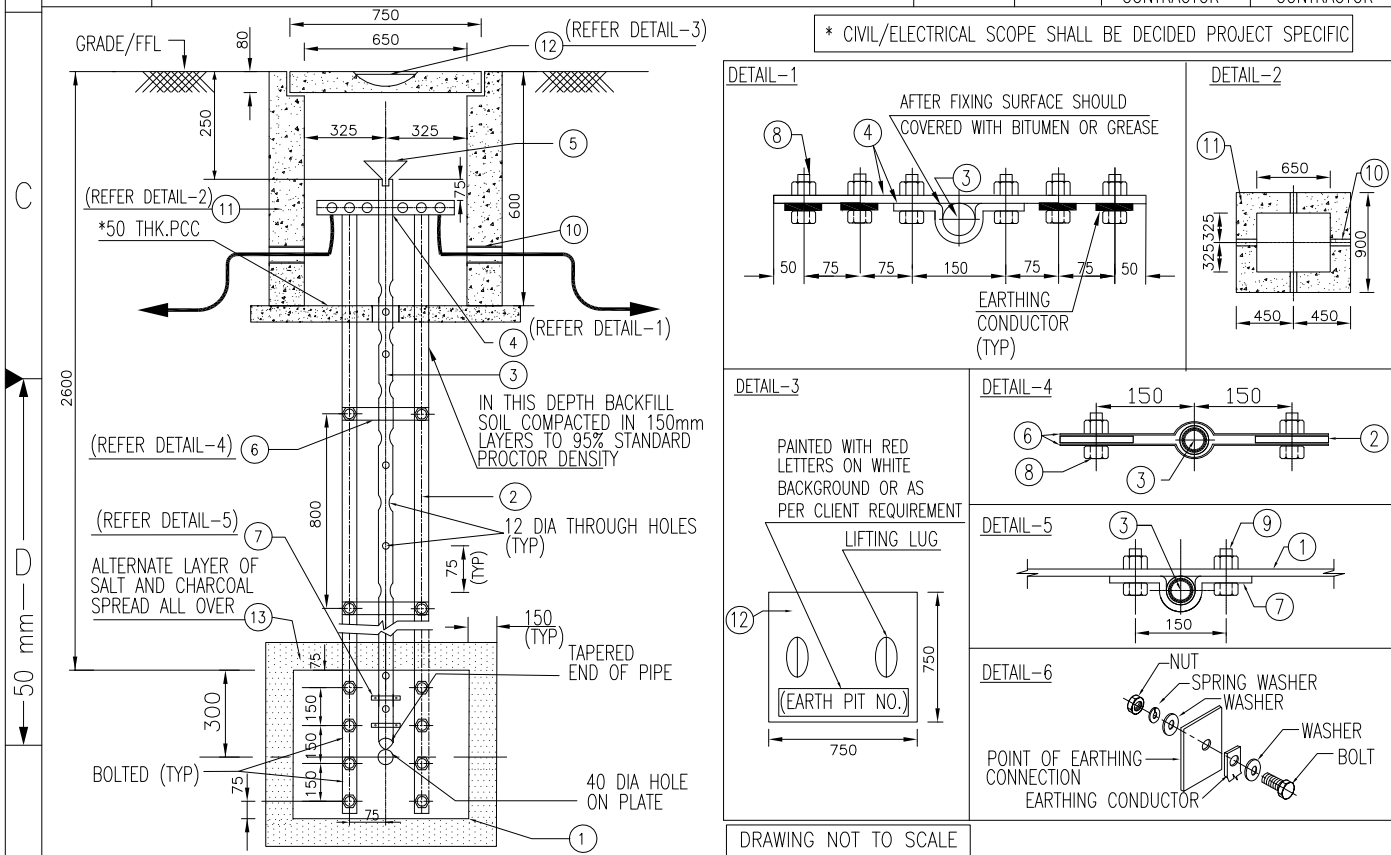

E


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00	15/11/16	RDK	ANK	15/11/16	RPM	15/11/16	RPM	ISSUED AS STANDARD					Cat. Code	Acc. Code	Status		
Rev.	Date	Name		Date	Name		Date	Name		Description				Acc. Code			
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Pro. Unit		TON				Group		Type of Document				Sheet 1 / 1					
Con. Unit		Scale NTS		Order No.				 thyssenkrupp									

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
	Date	Name	Description INSTALLATION STANDARDS – EARTHING EARTH PIT WITH CU PLATE ELECTRODE FOR PAVED AREA WITHOUT FORKLIFT MOVEMENT (EEP17)
Drawn	15/11/16	RDK	
Prepared	15/11/16	ANK	
Checked	15/11/16	RPM	
Approved	15/11/16	RPM	

ISO A4

1		2		3		4	
ITEM	DESCRIPTION		MATERIAL	QTY.	SUPPLY BY	INSTALLATION BY	
A	1	EARTHING PLATE-600(L)X600(W)X3(T), WITH 50 DIA HOLE AT CENTRE.	CU	1 NO	ELECTRICAL CONTRACTOR	ELECTRICAL CONTRACTOR	
	2	EARTHING STRIP-35(W)X6(T), WITH 12 DIA HOLES.	CU	AS REQUIRED	ELECTRICAL CONTRACTOR	ELECTRICAL CONTRACTOR	
	3	PIPE - 50 DIA N.B., CLASS-B, TAPERED AT ONE END, WITH 12 DIA THROUGH HOLES AT EVERY 75mm.	HDGI	AS REQUIRED	ELECTRICAL CONTRACTOR	ELECTRICAL CONTRACTOR	
	4	TEST LINK ASSEMBLY-35(W)X6(T), STRIP, BENT TO SHAPE OF ITEM-1, WITH 2 Nos 12 DIA HOLES AND ANOTHER STRIP WITH 6Nos 12 DIA HOLES(REFER DETAIL-1)	CU	1 SET	ELECTRICAL CONTRACTOR	ELECTRICAL CONTRACTOR	
	5	FUNNEL, WITH WIRE MESH-SUITABLE FOR TACK WELDED TO TIP OF ITEM-3.	HDGI	1 NO	ELECTRICAL CONTRACTOR	ELECTRICAL CONTRACTOR	
B	6	CLAMPS-25(W)X4(T) STRIP BENT TO SHAPE OF ITEM-3, WITH 2 Nos 12 DIA HOLES.	CU	4 NOs	ELECTRICAL CONTRACTOR	ELECTRICAL CONTRACTOR	
	7	CLAMPS-25(W)X4(T) STRIP BENT TO SHAPE OF ITEM-3, WITH 2 Nos 10 DIA HOLES.	CU	2 NOs	ELECTRICAL CONTRACTOR	ELECTRICAL CONTRACTOR	
	8	12 DIA HEXAGONAL HEAD BOLTS-40mm LONG, WITH NUTS & WASHERS, SUITABLE FOR CONNECTIONS SHOWN IN THIS DRAWING (REFER DETAIL-6)	BRASS	AS REQUIRED	ELECTRICAL CONTRACTOR	ELECTRICAL CONTRACTOR	
	9	10 DIA HEXAGONAL HEAD BOLTS-30mm LONG WITH NUTS & WASHERS, SUITABLE FOR CONNECTIONS SHOWN IN THIS DRAWING (REFER DETAIL-6)	BRASS	AS REQUIRED	ELECTRICAL CONTRACTOR	ELECTRICAL CONTRACTOR	
	10	PIPE SLEEVE-150 DIA, FOR ENTRY OF EARTHING CONDUCTOR (REFER DETAIL-2)	PVC	0.8 MTRS	*CIVIL/ELECTRICAL CONTRACTOR	*CIVIL/ELECTRICAL CONTRACTOR	
	11	EARTH PIT CHAMBER (TYPE C) FOR DETAIL REFER CIVIL STANDARD DRG.NO. PIN-LEP-CVC-1013.	REINFORCED CONCRETE	1 NO	*CIVIL/ELECTRICAL CONTRACTOR	*CIVIL/ELECTRICAL CONTRACTOR	
	12	EARTH PIT COVER (TYPE C) FOR DETAIL REFER CIVIL STANDARD DRG.NO. PIN-LEP-CVC-1013.	REINFORCED CONCRETE	1 NO	*CIVIL/ELECTRICAL CONTRACTOR	*CIVIL/ELECTRICAL CONTRACTOR	
	13	CHARCOAL AND SALT	-	1 LOT	ELECTRICAL CONTRACTOR	ELECTRICAL CONTRACTOR	

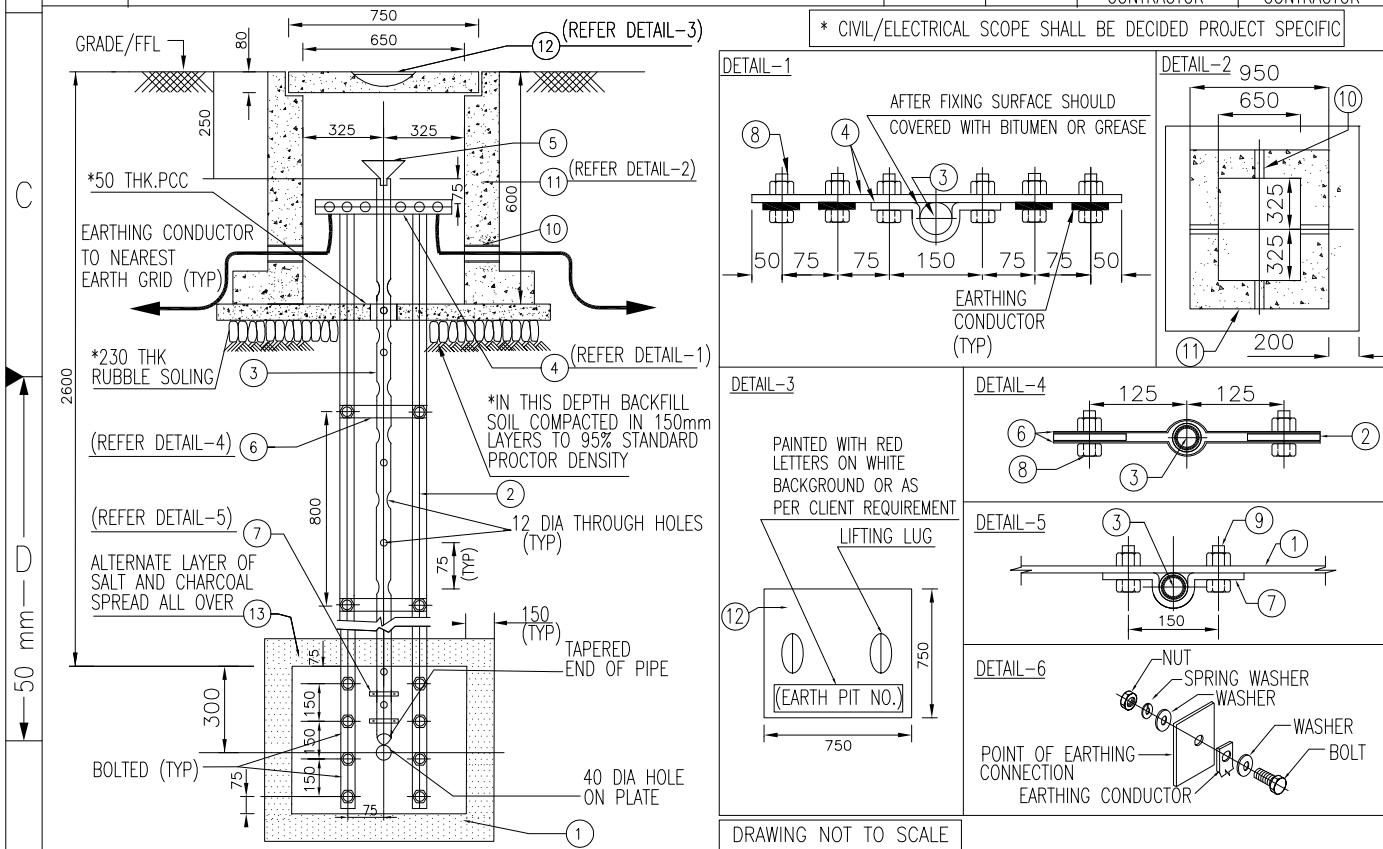





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Code				Contract No.				Document ID				Part				Rev.									
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Rev.		Date		Name				Date		Name		Date		Name		ISSUED AS STANDARD				Cat. Code		Acc. Code		Status	
		Drawn/Prepared						Checked				Approved				Description		Acc. Code							
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														Store Name EEP18											
Pro. Unit		TON				Group		Type of Document				Sheet 1 / 1													
Con. Unit		Scale NTS		Order No.				 thyssenkrupp																	

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		Date		Name		Description									
Drawn		15/11/16		RDK		INSTALLATION STANDARDS – EARTHING									
Prepared		15/11/16		ANK		EARTH PIT WITH CU PLATE ELECTRODE									
Checked		15/11/16		RPM		FOR PAVED AREA WITH									
Approved		15/11/16		RPM		2T CAPACITY FORKLIFT MOVEMENT(EEP18)									

ISO A4



NOTES:

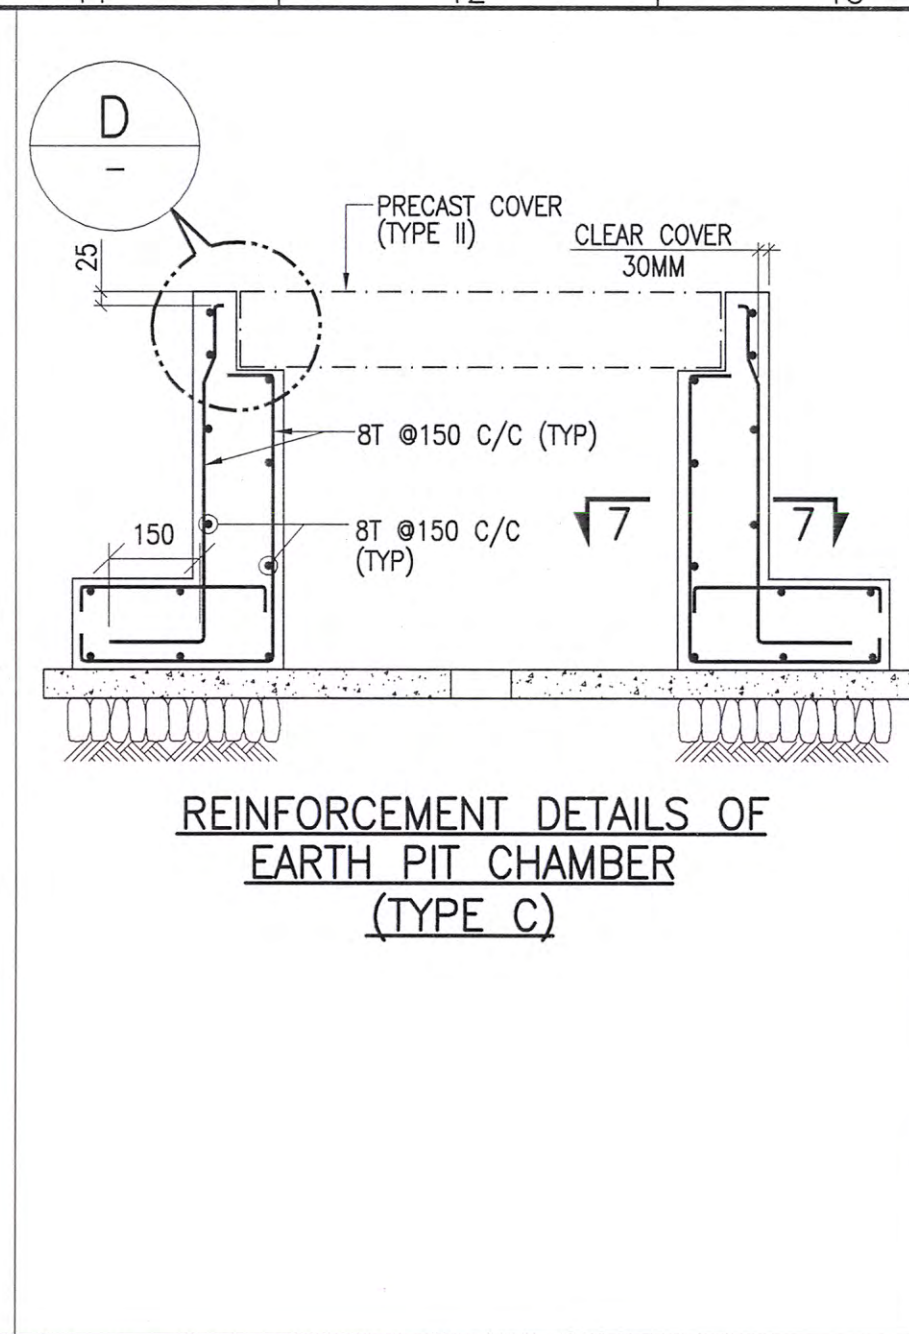
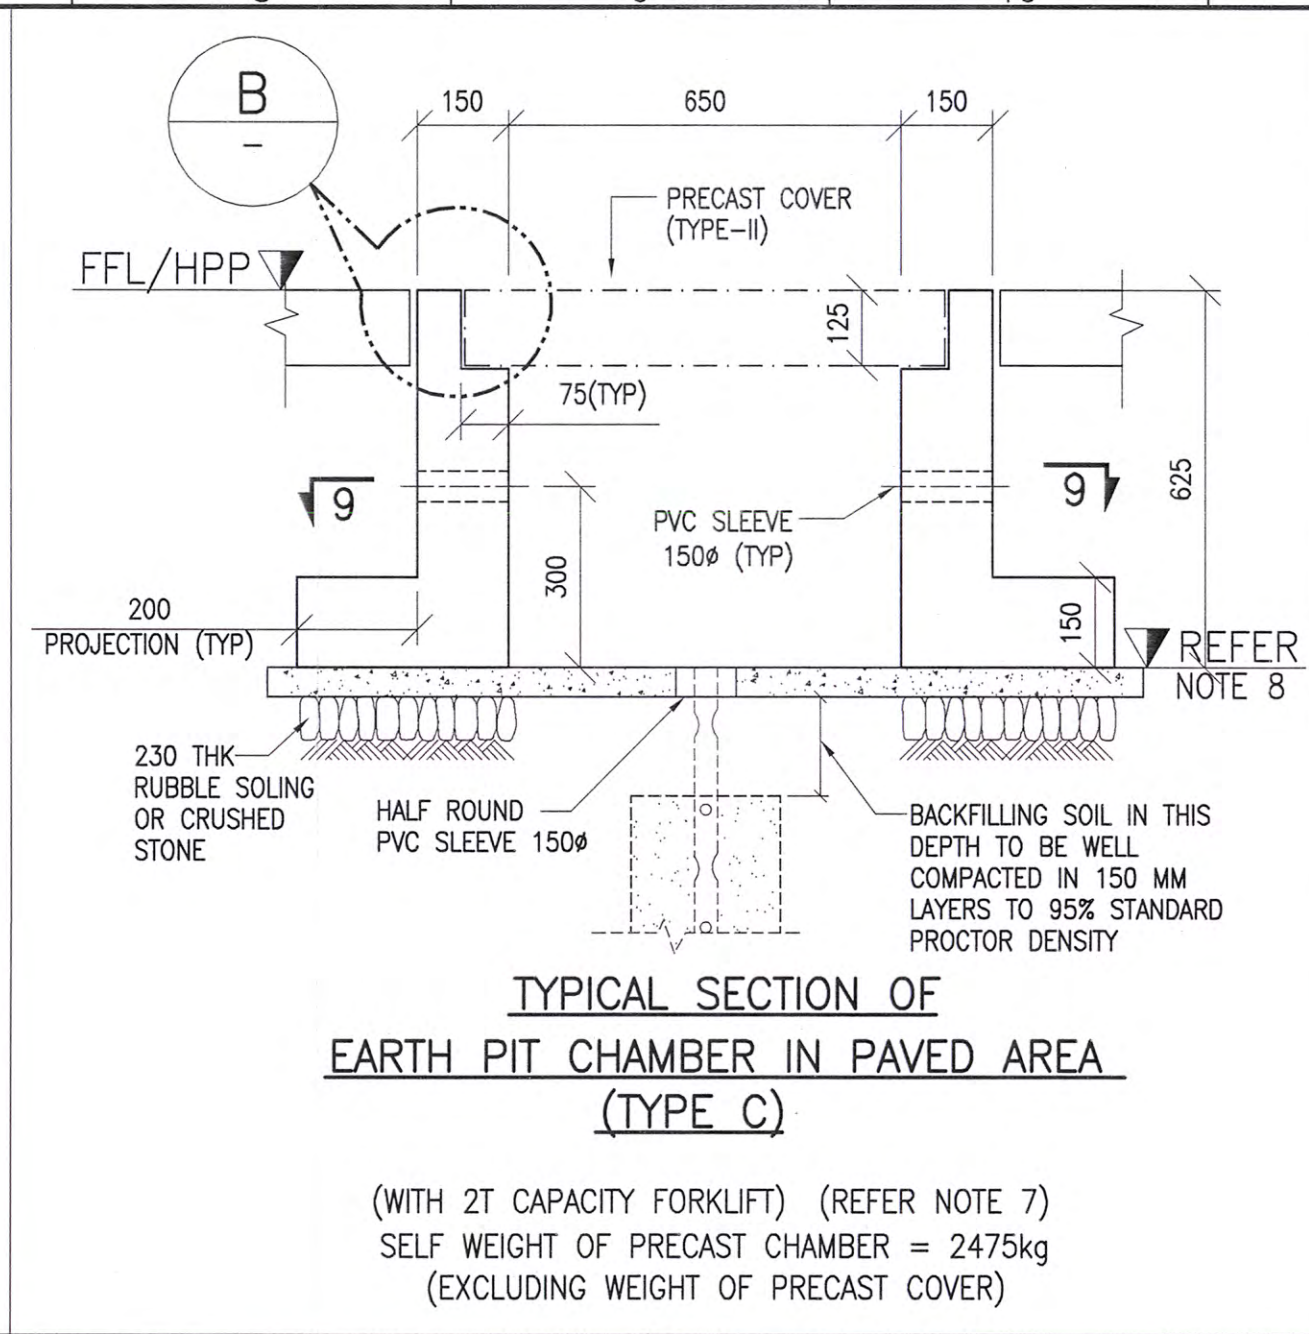
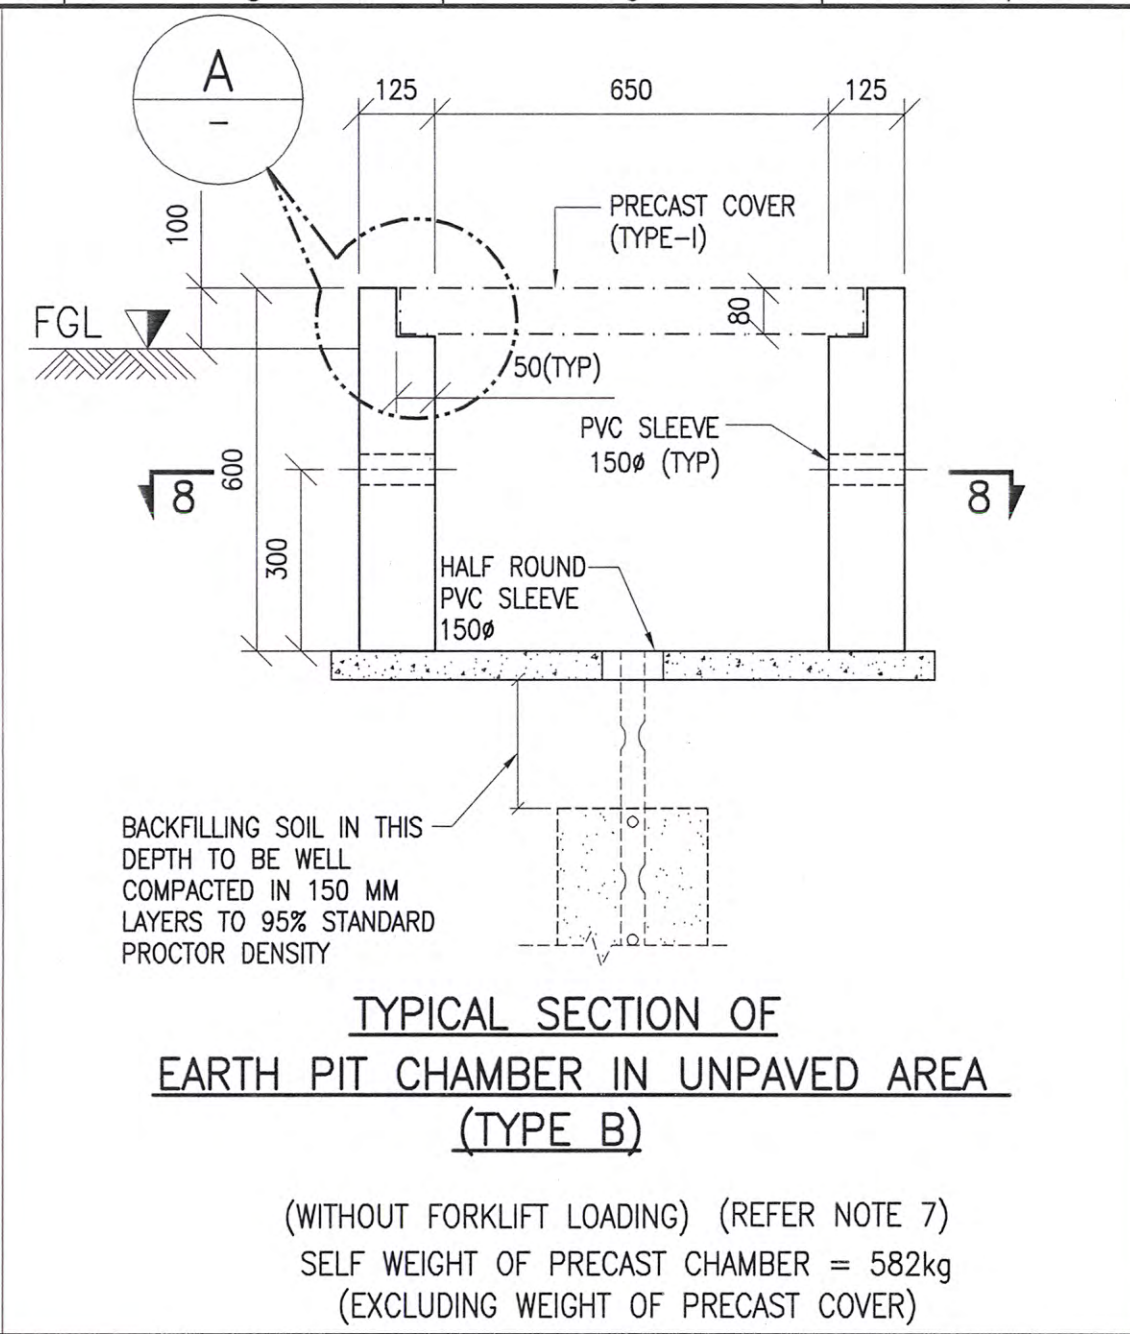
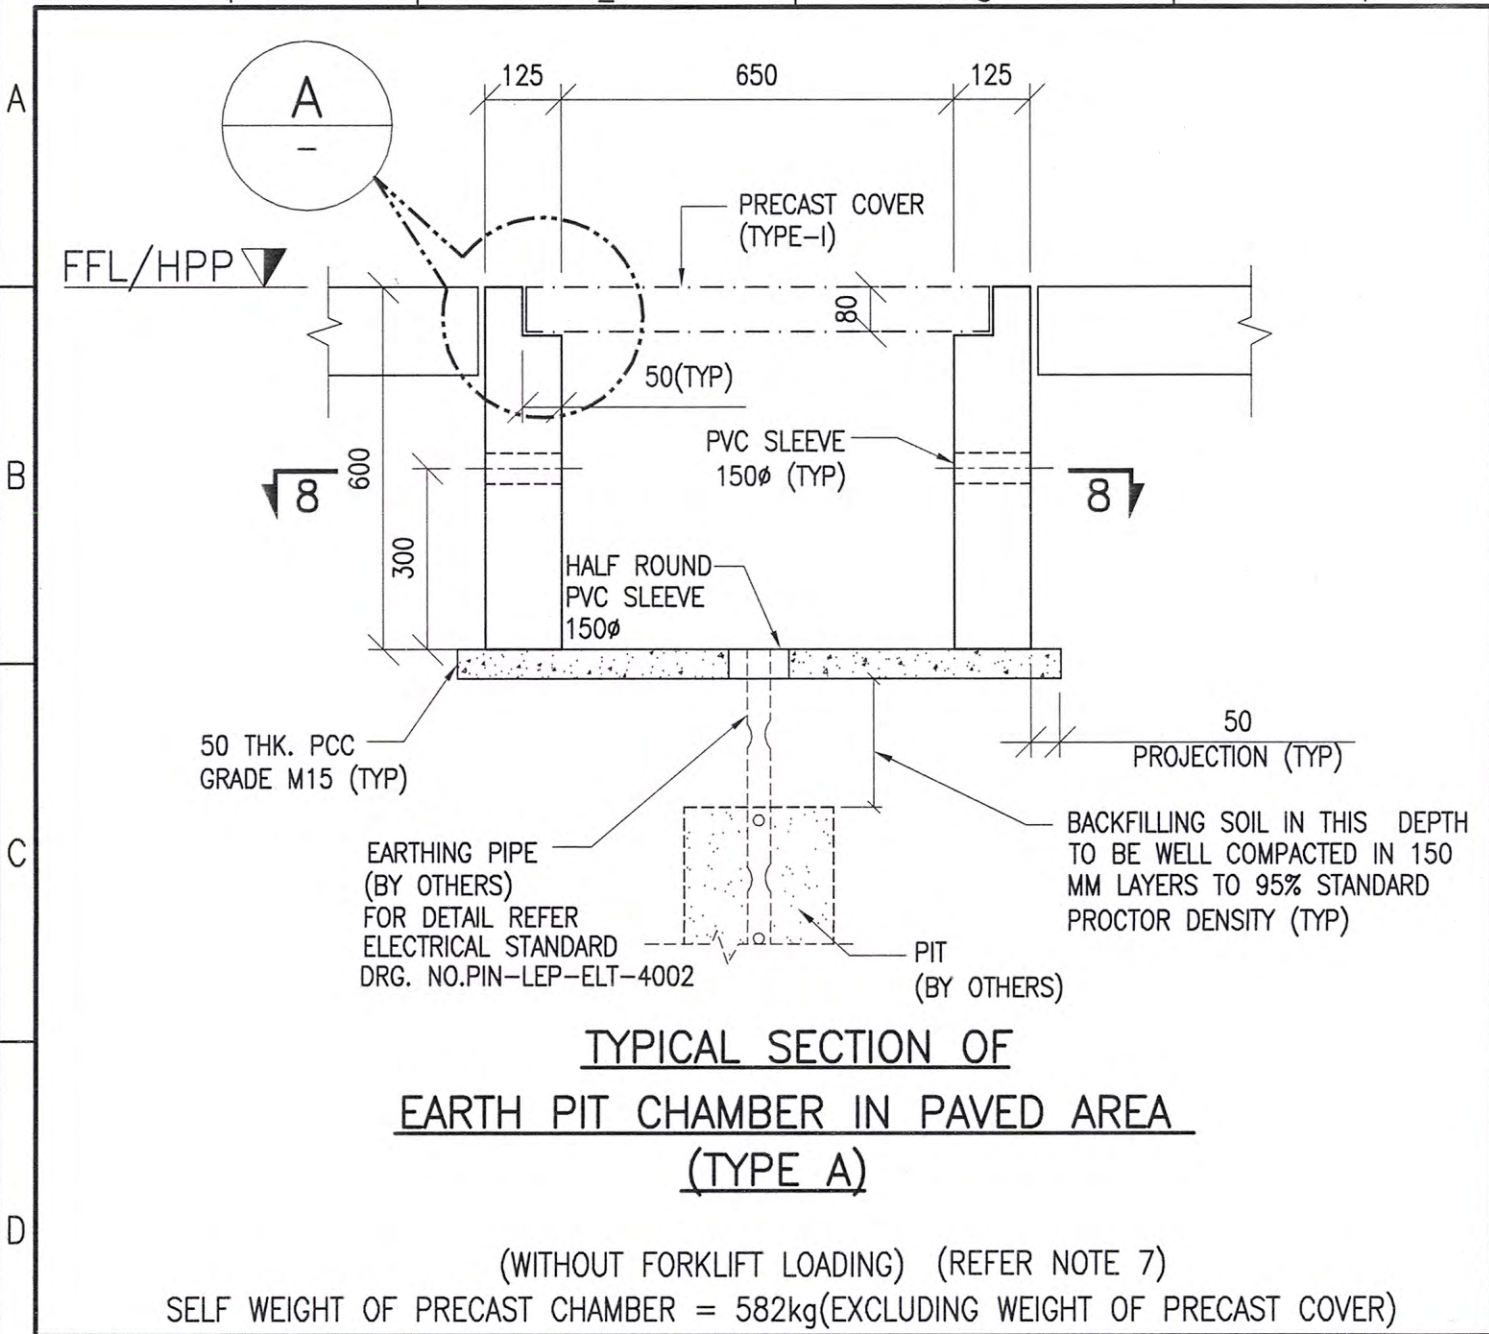
- ALL DIMENSIONS ARE IN MILLIMETERS.
- GRADE OF CONCRETE FOR PRECAST CONCRETE COVER IS M30.
GRADE OF CONCRETE FOR RCC PIT IS
(A) M25 FOR CAST IN SITU RCC PIT.
(B) M30 FOR PRECAST RCC PIT.
IF DUE TO PROJECT REQUIREMENT, HIGHER CONCRETE GRADES ARE TO BE USED, THEN, SAME SHALL BE FOLLOWED.
- GRADE OF REINFORCEMENT SHALL BE TOR STEEL Fe 500D AS PER IS 1786: 2008.
- MINIMUM GRADE OF STEEL FOR LIFTING HOOK SHOULD BE MILD STEEL Fe 250 AS PER IS432(PART I).
ALTERNATIVELY TOR STEEL FE 415D AS PER IS 1786: 2008 CAN BE USED, IF MILD STEEL IS NOT AVAILABLE.
- CONTRACTOR MAY MAKE THIS EARTH PITS AS PRECAST UNITS.CONTRACTOR CAN USE SLEEVE OPENINGS TO FIX THE LIFTING ASSEMBLY.
- PRECAST CONCRETE COVER(TYPE II) IS DESIGNED TO SUPPORT 2T CAPACITY FORKLIFT, FOR FORKLIFT LOADS, REFER DRAWING PIN-LEP-1011.
- LAYING OF PCC AND CONSTRUCTION OF PIT CHAMBER SHALL BE CARRIED OUT AFTER CARRYING OF FOLLOWING ACTIVITIES:
(a) MAKING OF HOLE IN THE GROUND & FILLING THE SAME WITH CHARCOAL,SALT & SAND AS GIVEN IN ELECTRICAL DWG. NO. PIN-LEP-CVC-1011.
(b) BACK FILLING UPTO BOTTOM OF PCC & COMPACTING THE SAME AS SHOWN IN THE DRAWING.
- MINIMUM SAFE BEARING CAPACITY OF SOIL AT THIS LEVEL SHALL BE 6T/M².

LEGEND:

HPP - HIGH POINT PAVING
FFL - FINISHED FLOOR LEVEL
FGL - FINISHED GRADE LEVEL

SYMBOL:

T - TOR STEEL
R - MILD STEEL

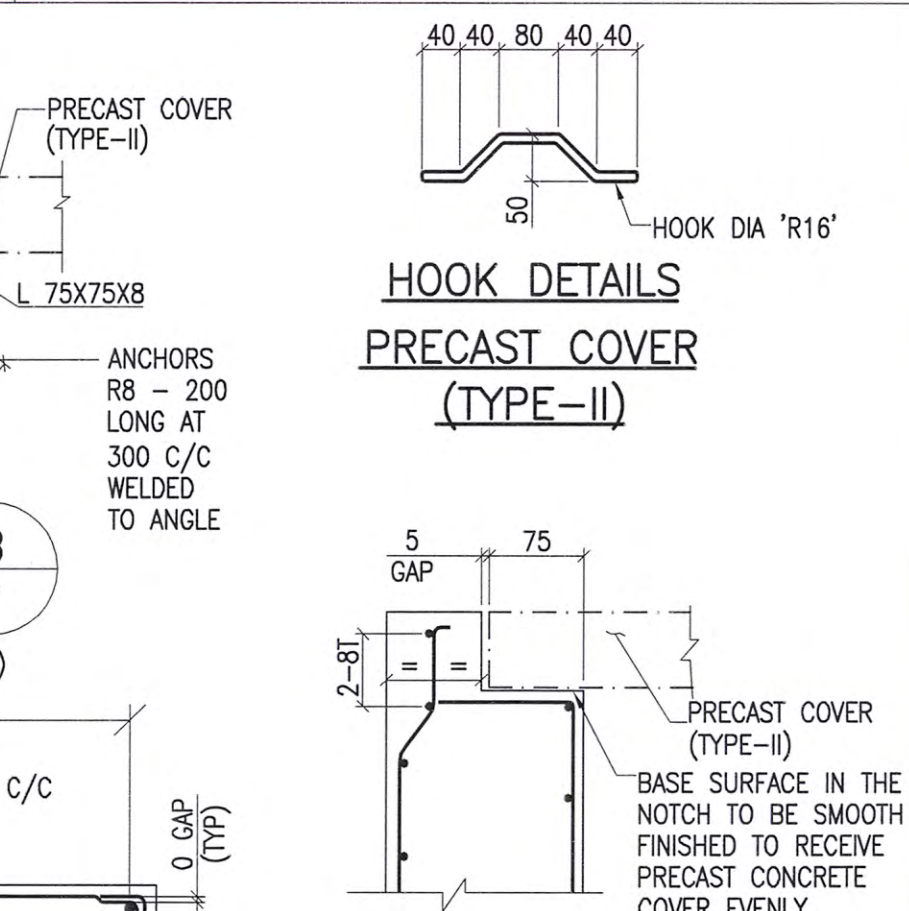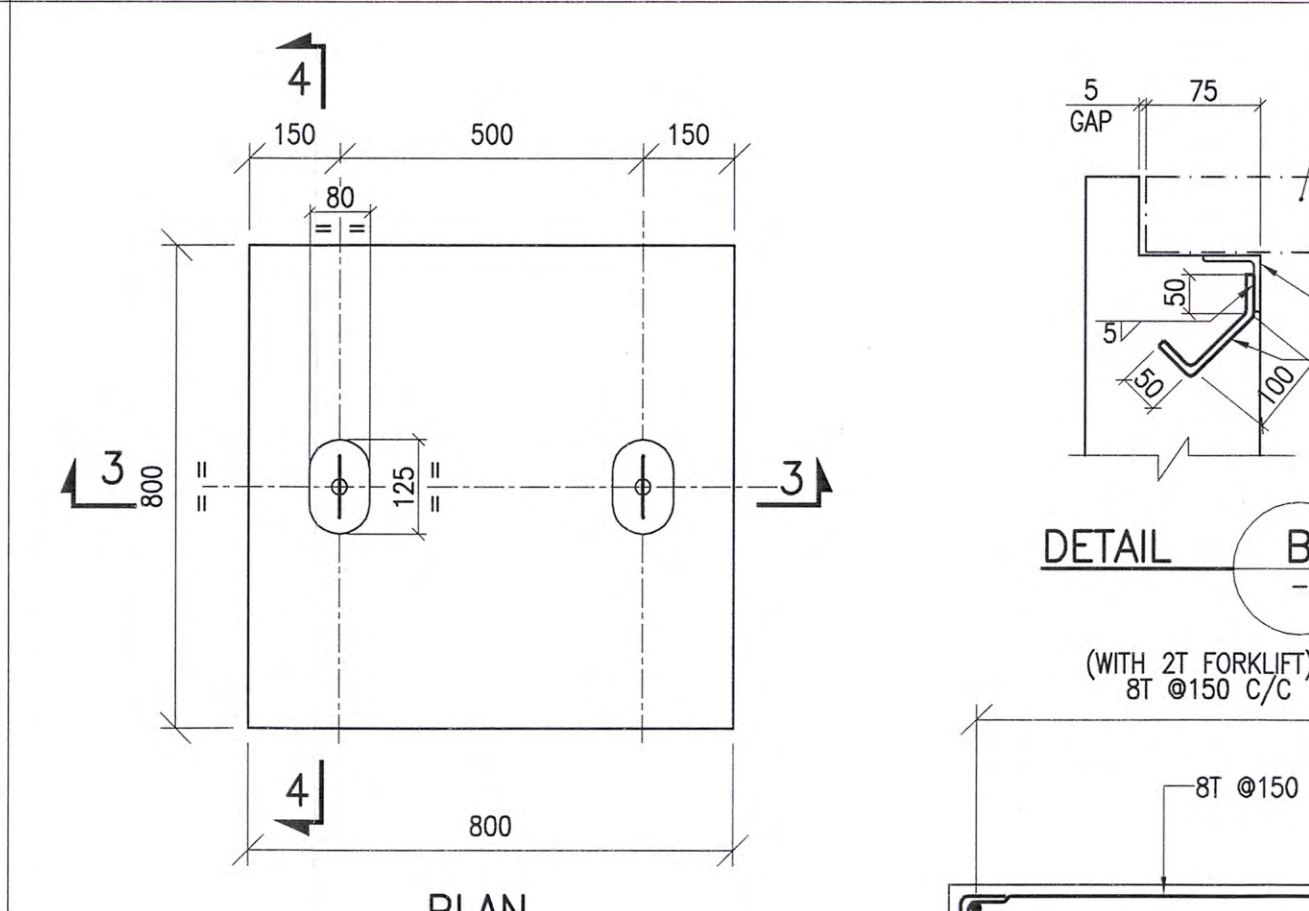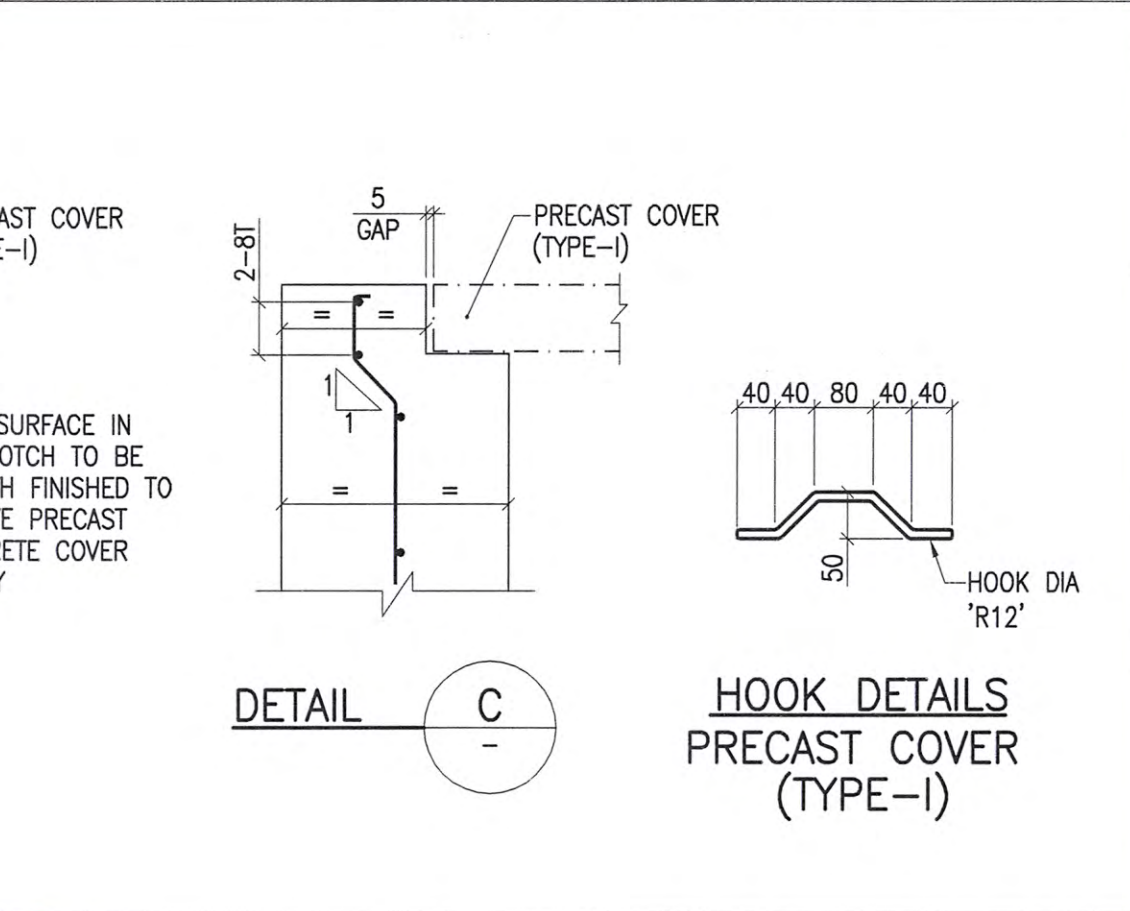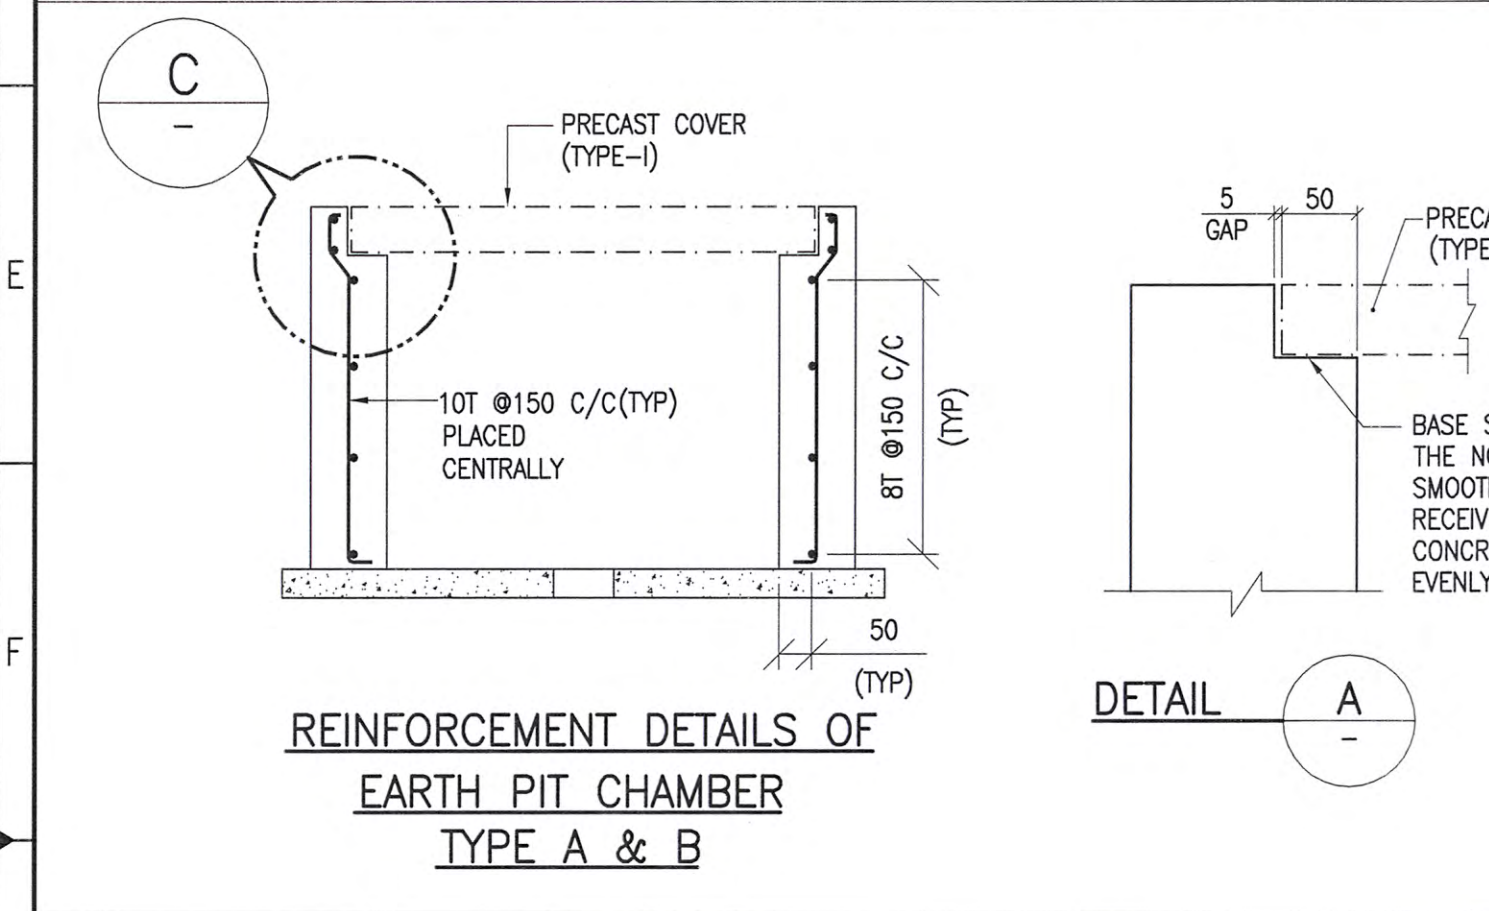

HOOK DETAILS PRECAST COVER (TYPE-II)

HOOK DIA 'R16'





ANCHORS R8 - 200 LONG AT 300 C/C WELDED TO ANGLE

DETAIL B

(WITH 2T FORKLIFT) 8T @150 C/C

DETAIL D

BASE SURFACE IN THE NOTCH TO BE SMOOTH FINISHED TO RECEIVE PRECAST CONCRETE COVER EVENLY

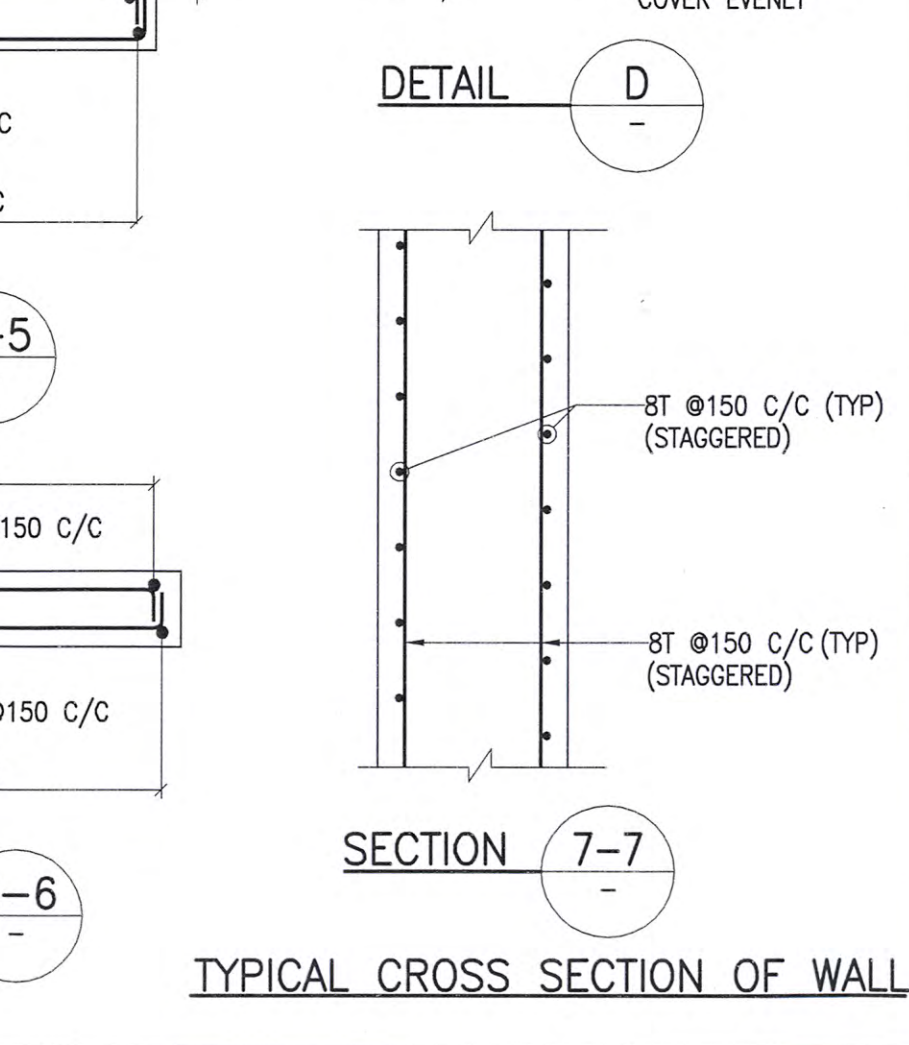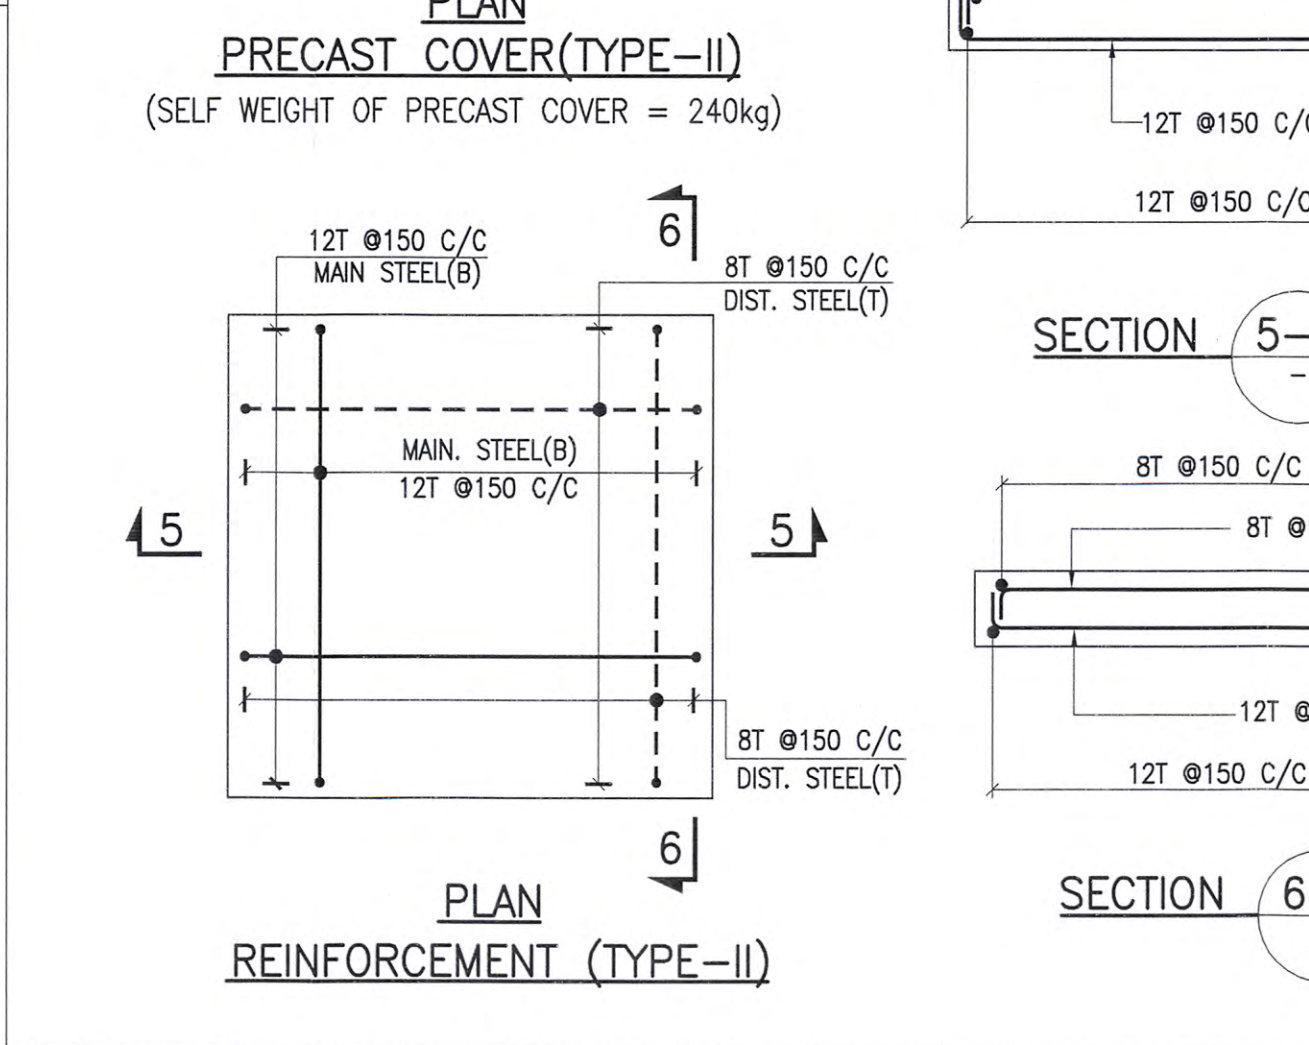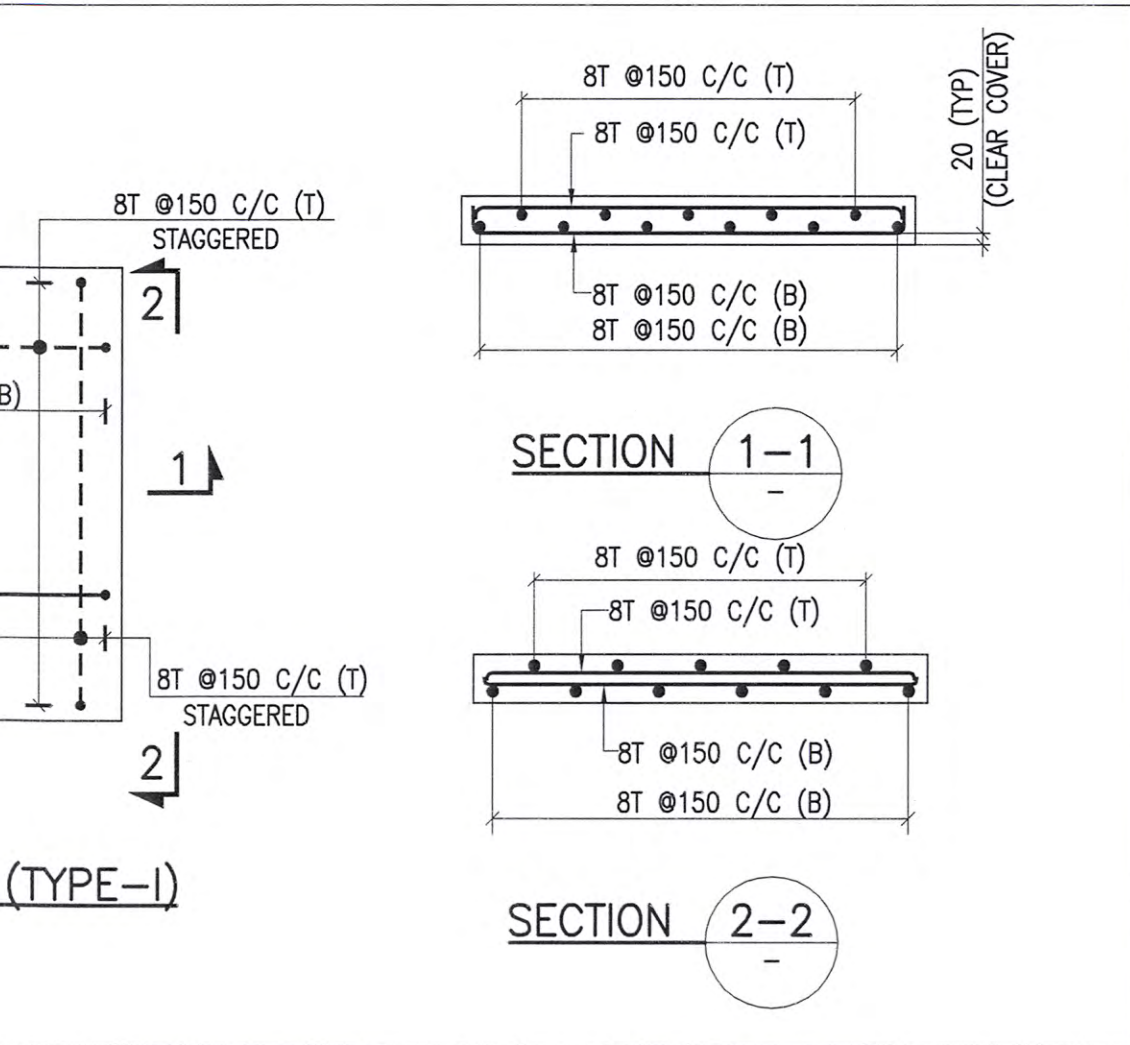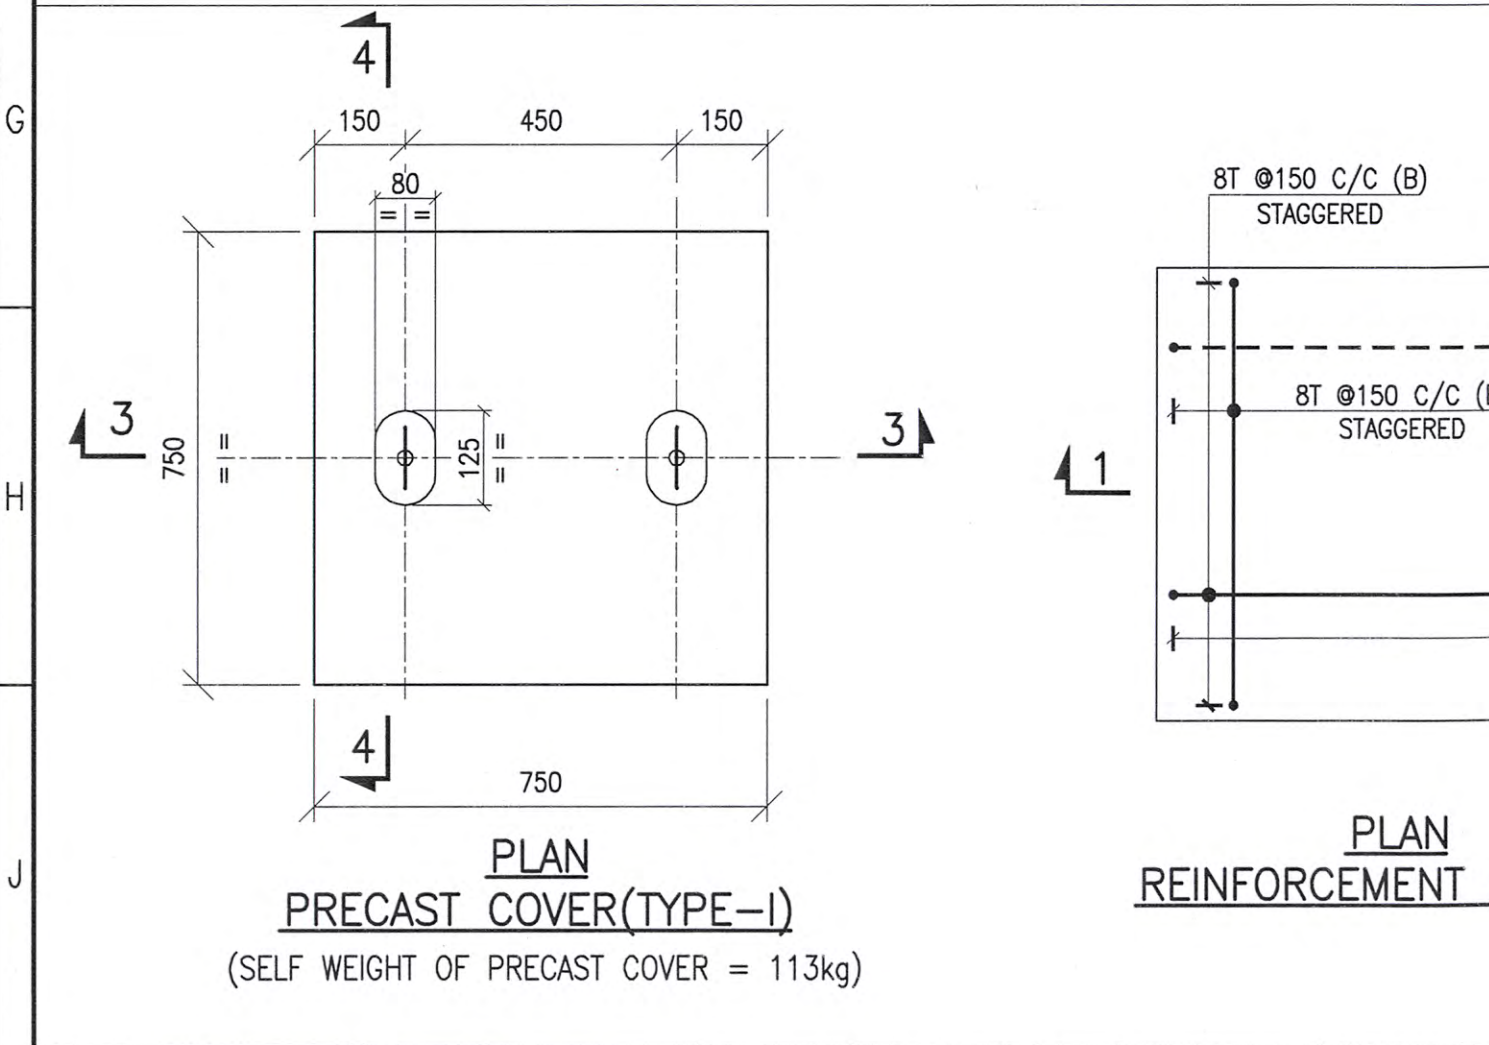

PLAN PRECAST COVER (TYPE-I)

(SELF WEIGHT OF PRECAST COVER = 113kg)

PLAN REINFORCEMENT (TYPE-I)

PLAN REINFORCEMENT (TYPE-II)

SECTION 1-1

SECTION 2-2

SECTION 5-5

SECTION 6-6





SECTION 7-7

SECTION 3-3

SECTION 4-4

SECTION 8-8

SECTION 9-9

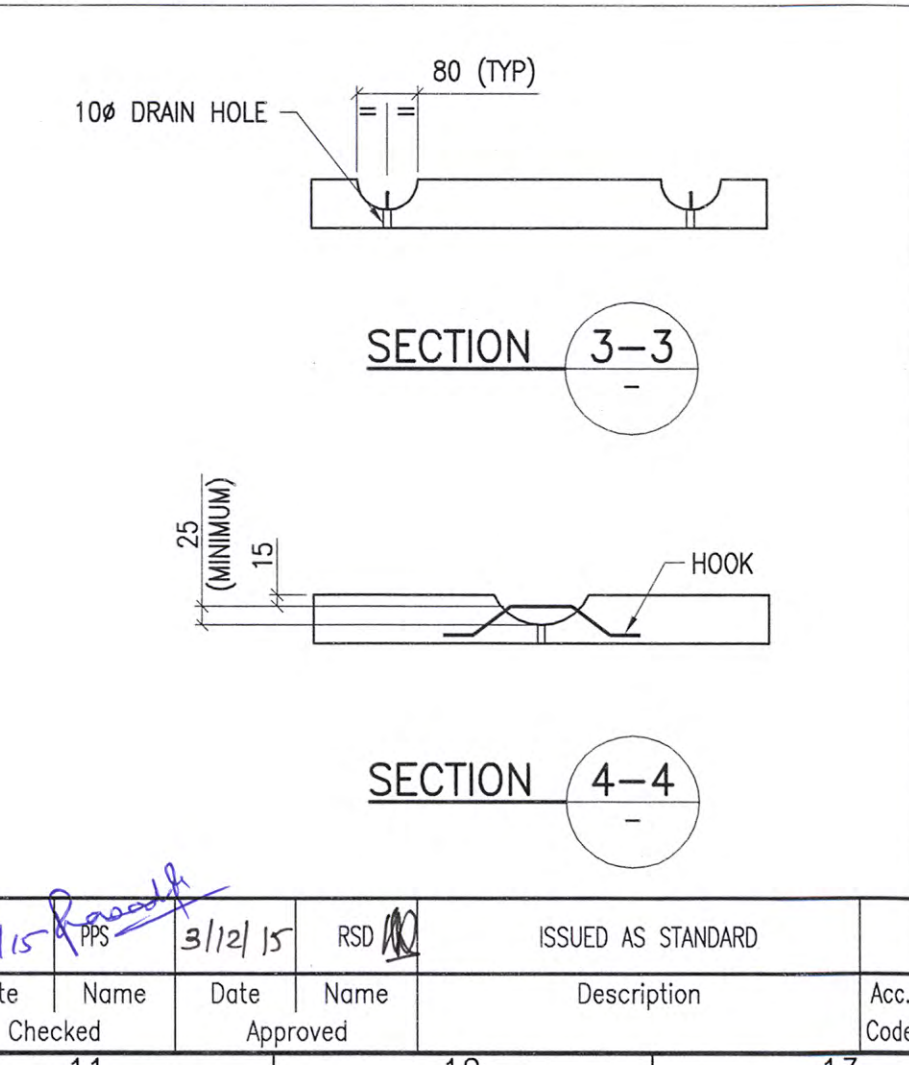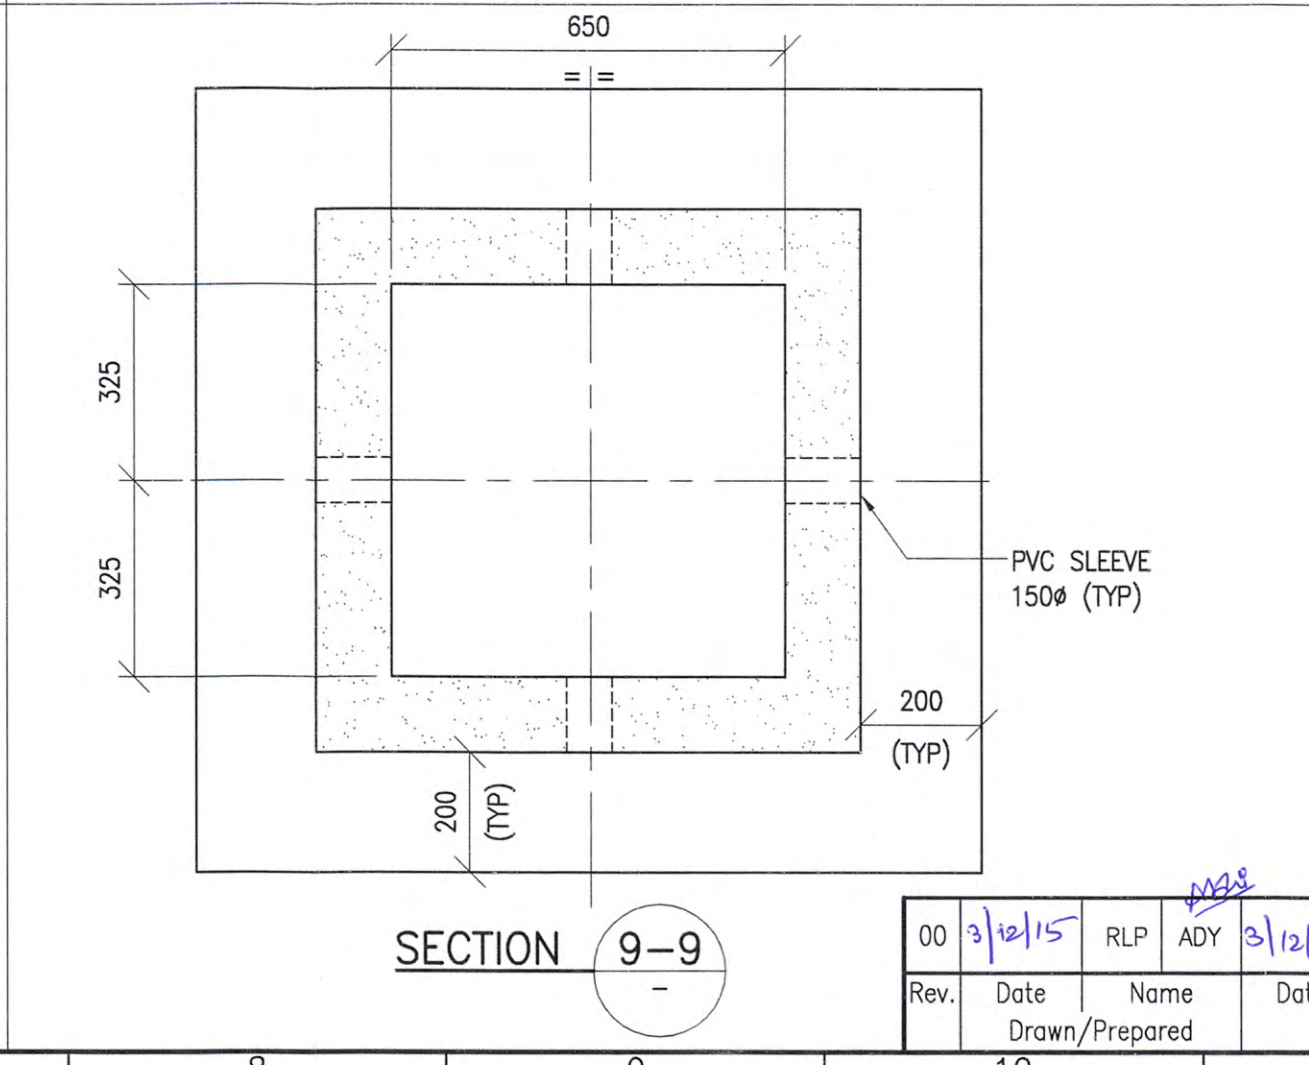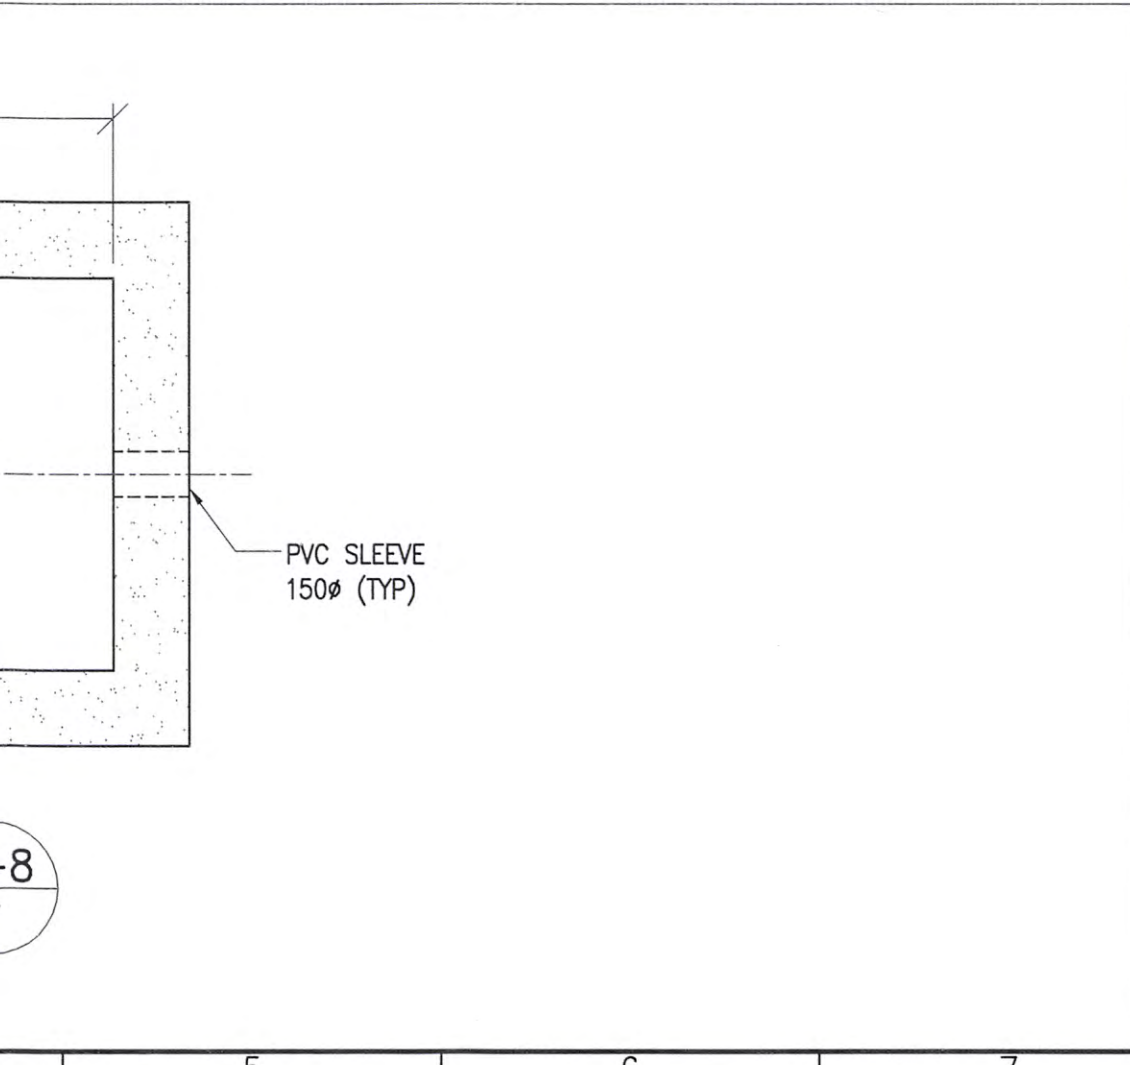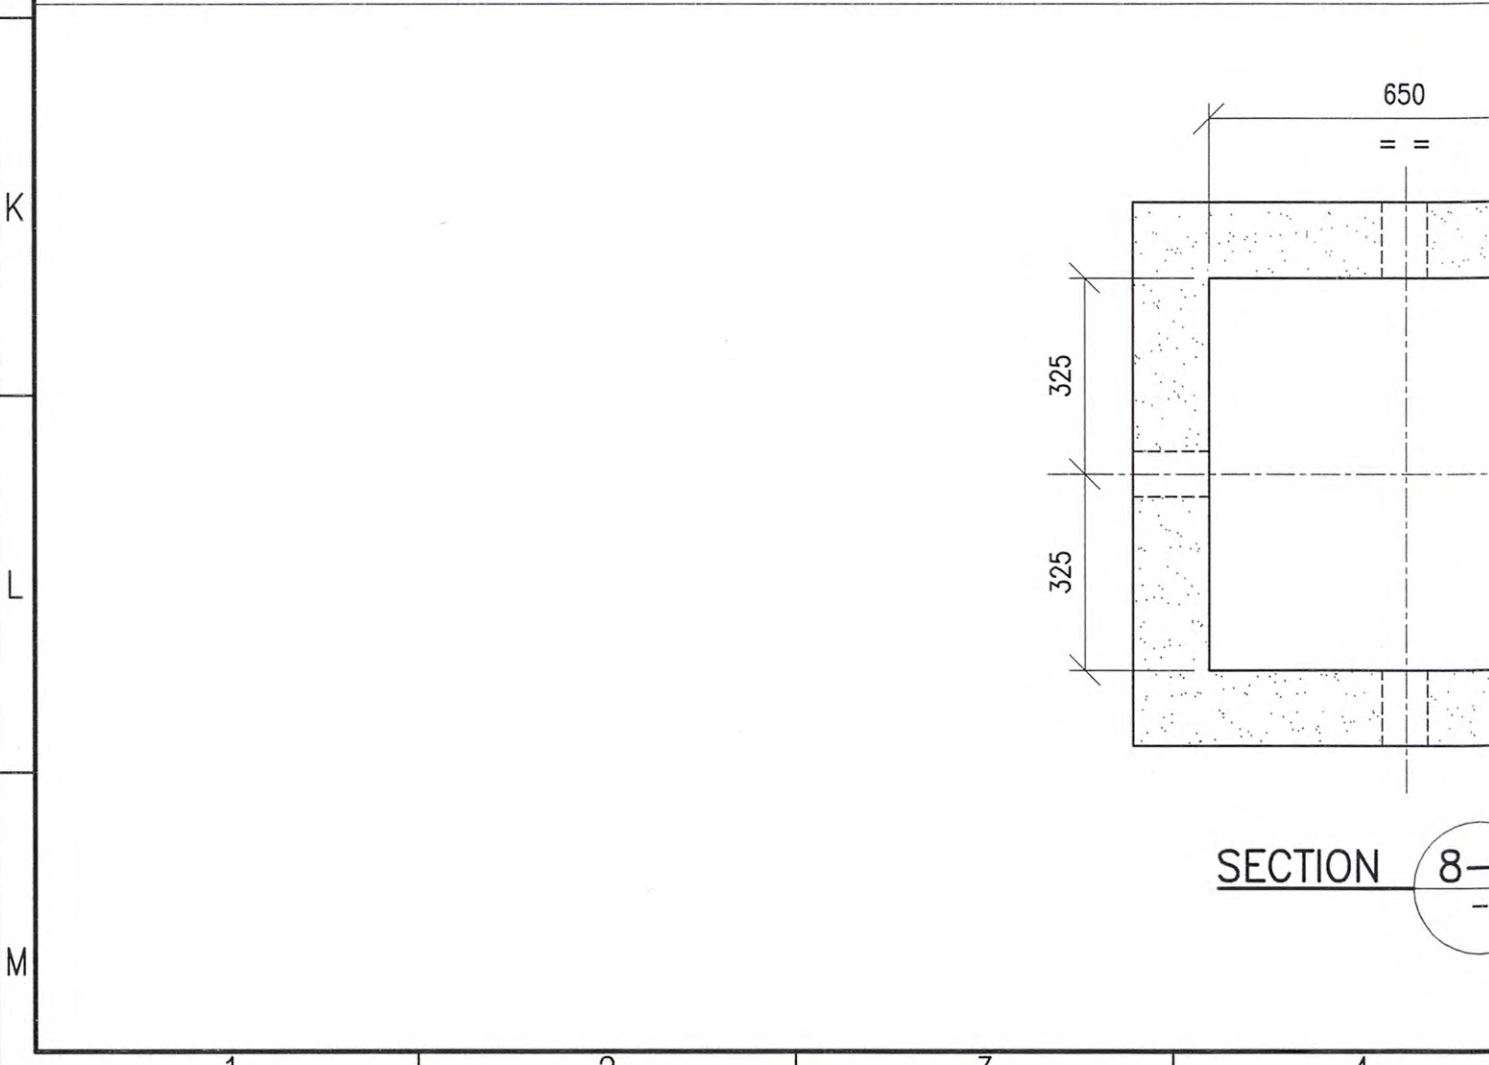

BASED ON PIN-LEP-CVC-1013_Rev.00

TKIS - India / Owner/Client

☐ 1 For Approval
☐ 2 For Review / Comments
☐ 3 For Information
☐ 4 For Engineering
☐ 5 For Enquiry
☐ 6 For Order Placement
☐ 7 Final & Approved
☐ 8 Released for Construction

TKIS - India / Owner/Client

☐ 1 Approved
☐ 2 Approved for Manufacturing/
Fabrication With Comments
as Marked
☐ 3 Not Approved/Resubmit
☐ 4 Retained for Information/Records
☐ 5 Reviewed
☐ 6 Reviewed as Noted/Resubmit

Date : / / Name :

Contract No. Document ID Code Part Rev.
PIN-LEP-CVC-1013 00

Store Location: Server/Share
\\KUMUS871\REFER\CIVIL
Store Location: Folder
VOLUME-6
Store Name
PIN-LEP-CVC-1013_00.dwg
Pro. Unit Con. Unit TON Group Order No. Type of Document Sheet

ThyssenKrupp Industrial Solutions (India)

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

STANDARD DETAILS OF EARTH PIT CHAMBER

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3/12/15 RLP
Prepared Date Name
3/12/15 ADY
Checked Date Name
3/12/15 PPS
Approved Date Name
3/12/15 RSD



ISSUED AS STANDARD

Acc. Code Scale Cat. Code Acc. Code Status

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

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	ELECTRICAL INSTALLATION PART- III - INSTALLATION DETAIL-LIGHTING			नालको  NALCO नेशनल एल्युमिनियम कम्पनी लिमिटेड National Aluminium Company Ltd.
				Rev 0 Page 1 of 5

INSTALLATION DETAIL-LIGHTING



Plant 1.0 MTPA ALUMINA REFINERY STREAM-5	Client NALCO	Contract Code NAL	Document ID 6695-ELT-G00-EC-0027	Contract No. 66-6695		
 thyssenkrupp	ELECTRICAL INSTALLATION PART- III - INSTALLATION DETAIL-LIGHTING			 नेशनल एल्युमिनियम कम्पनी लिमिटेड National Aluminium Company Ltd.		
				Rev	0	Page

LIST OF INSTALLATION STANDARDS

Sr. No.	Description	Typical No.	No. of Sheets	Rev
1	AVIATION LIGHT FIXTURE MOUNTED ON BRACKET, ON CONCRETE/ BRICK WALL	LAVC1	1	0
2	AVIATION LIGHT FIXTURE ON POLE ON STRUCTURAL STEEL RAILING	LAVR1	1	0
3	CONTROL GEAR BOX/JUNCTION BOX MOUNTED ON CONCRETE WALL/COLUMN	LCGC1	1	0
4	CONTROL GEAR BOX/JUNCTION BOX MOUNTED ON POLE/HANDRAIL	LCGR1	1	0
5	CONTROL GEAR BOX/JUNCTION BOX MOUNTED ON STEEL COLUMN	LCGS1	1	0
6	EXIT SIGN FIXTURE ON CONCRETE/BRICK WALL: TYPE 1	LESC1	1	0
7	EXIT SIGN FIXTURE ON CONCRETE/BRICK WALL: TYPE 2	LESC2	1	0
8	EXIT SIGN FIXTURE ON CEILING/SIDE OF CONCRETE COLUMN	LESC3	1	0
9	EXIT SIGN FIXTURE ON STEEL BEAM/COLUMN	LESS1	1	0
10	DECORATIVE TYPE EXIT SIGN FIXTURE AT FALSE CEILING/RECESS MOUNTED	LESZ1	1	0
11	DECORATIVE TYPE EXIT SIGN FIXTURE ON GYPSUM/BRICK WALL	LESZ2	1	0
12	FLOOD LIGHT FIXTURE ON BRACKET,ON CONCRETE CEILING/BEAM	LFDC1	1	0
13	FLOOD LIGHT FIXTURE ON BRACKET,ON CONCRETE WALL/COLUMN	LFDC2	1	0
14	FLOOD LIGHT FIXTURE ON POLE AT GROUND LEVEL	LFDP1	1	0
15	FLOOD LIGHT FIXTURE ON POLE,ON STRUCTURAL STEEL RAILING	LFDR1	1	0
16	FLOOD LIGHT FIXTURE ON BRACKET,ON STRUCTURAL STEEL COLUMN	LFDS1	1	0
17	FLOOD LIGHT FIXTURE ON BRACKET,ON STRUCTURAL STEEL BEAM	LFDS2	1	0
18	FLUORESCENT/LED LIGHTING FIXTURE MOUNTED ON CONCRETE CEILING	LFLC1	1	0
19	FLUORESCENT/LED LIGHTING FIXTURE SUSPENDED FROM CONCRETE CEILING	LFLC2	1	0
20	FLUORESCENT/LED LIGHTING FIXTURE ON POLE BRACKET ON WALL/COLUMN	LFLC3	1	0
21	FLUORESCENT/LED LIGHTING FIXTURE MOUNTED ON CONCRETE WALL/COLUMN	LFLC4	1	0
22	FLUORESCENT/LED LIGHTING FIXTURE RECESSED IN FALSE CEILING	LFLF1	1	0
23	FLUORESCENT/LED LIGHTING FIXTURE (SQUARE TILE) RECESSED IN FALSE CEILING	LFLF2	1	0
24	FLUORESCENT/LED LIGHTING FIXTURE FOR CELLRACK ILLUMINATION	LFLK1	1	0
25	FLUORESCENT/LED LIGHTING FIXTURE ON POLE ON STRUCTURAL STEEL RAILING	LFLR1	1	0
26	FLUORESCENT/LED LIGHTING FIXTURE MOUNTED UNDER STEEL CEILING	LFLS1	1	0
27	FLUORESCENT/LED LIGHTING FIXTURE SUSPENDED FROM STEEL CEILING	LFLS2	1	0
28	FLUORESCENT/LED LIGHTING FIXTURE ON POLE BRACKET ON STEEL COLUMN	LFLS3	1	0
29	FLUORESCENT/LED LIGHTING FIXTURE SUPPORTED FROM CABLE TRAY	LFLT1	1	0
30	HIGH/MEDIUM/LOW BAY FIXTURE ON BRACKET, ON CONCRETE CEILING	LHBC1	1	0
31	HIGH/MEDIUM/LOW BAY FIXTURE ON BRACKET, ON STRUCTURAL STEEL BEAM	LHBS1	1	0

Plant 1.0 MTPA ALUMINA REFINERY STREAM-5	Client NALCO	Contract Code NAL	Document ID 6695-ELT-G00-EC-0027	Contract No. 66-6695		
 thyssenkrupp	ELECTRICAL INSTALLATION PART- III - INSTALLATION DETAIL-LIGHTING			 नेशनल एल्युमिनियम कम्पनी लिमिटेड National Aluminium Company Ltd.		
				Rev	0	Page

Sr. No.	Description	Typical No.	No. of Sheets	Rev
32	STREET LIGHTING FIXTURE ON CONCRETE COLUMN/WALL	LSTC1	1	0
33	STREET LIGHTING FIXTURE ON STREET LIGHT POLE	LSTP1	1	0
34	STREET LIGHTING FIXTURE ON STRUCTURAL STEEL COLUMN	LSTS1	1	0
35	WELL GLASS FIXTURE ON BRACKET, ON CONCRETE WALL/COLUMN	LWGC1	1	0
36	WELL GLASS FIXTURE ON BRACKET, ON CONCRETE CEILING	LWGC2	1	0
37	WELL GLASS FIXTURE ON LONG BRACKET, ON CONCRETE CEILING	LWGC3	1	0
38	WELL GLASS FIXTURE ON POLE ON CONCRETE FLOOR	LWGP1	1	0
39	WELL GLASS FIXTURE ON POLE ON STRUCTURE STEEL RAILING	LWGR1	1	0
40	WELL GLASS FIXTURE ON BRACKET, ON STRUCTURAL COLUMN	LWGS1	1	0
41	WELL GLASS FIXTURE ON SHORT BRACKET, ON STRUCTURAL STEEL BEAM	LWGS2	1	0
42	WELL GLASS FIXTURE ON LONG BRACKET, ON STRUCTURAL STEEL BEAM	LWGS3	1	0
43	SWITCH SOCKET ON CONCRETE COLUMN/BRICK WALL	LSSC1	1	0
44	SWITCH SOCKET ON SELF-STANDING PEDESTAL	LSSP1	1	0
45	SWITCH SOCKET ON STEEL PLATFORM/GRATING	LSSP2	1	0
46	SWITCH SOCKET ON RAILING	LSSR1	1	0
47	SWITCH SOCKET ON STEEL STRUCTURE	LSSS1	1	0
48	JUNCTION BOX ON WALL/CONCRETE COLUMN: TYPE 1	LJBC1	1	0
49	JUNCTION BOX ON WALL/CONCRETE COLUMN: TYPE 2	LJBC2	1	0
50	JUNCTION BOX ON RAILING	LJBR1	1	0
51	JUNCTION BOX ON STEEL STRUCTURE	LJBS1	1	0

Plant 1.0 MTPA ALUMINA REFINERY STREAM-5	Client NALCO	Contract Code NAL	Document ID 6695-ELT-G00-EC-0027	Contract No. 66-6695		
 thyssenkrupp	ELECTRICAL INSTALLATION PART- III - INSTALLATION DETAIL-LIGHTING			नालको  NALCO नेशनल एल्युमिनियम कम्पनी लिमिटेड National Aluminium Company Ltd.		
				Rev	0	Page

1. General:

- The documents/drawings as indicated below shall be prepared by the LSTK Contractor as a part of detail Engineering.
- These notes shall be read and construed in conjunction with Lighting layout drawings and Installation Standards - Lighting.

2. Installation of Light Fixtures:



- Light fixtures shall be mounted as per mounting type indicated in the layout drawing and as detailed in installation standard. Fabrication of supports for fixtures shall be done as per installation standard. Where insert plates are not provided, contractor shall provide the same using anchor fasteners.
- Installation of light fixtures includes assembly of accessories of light fixture and internal wiring, if supplied loose, and installation of control gear boxes for non-integral type fixtures.
- Before installation of light fixtures, Inspection of internal assembly of light fixture shall be done by contractor as per manufacturer's instructions.
- Clearance for installation of light fixtures and their supports shall be obtained from electrical site engineer before commencement of the work.
- The control gear boxes for non-integral fixtures shall be grouped and installed at accessible location as close to the fixture as possible, if not already indicated in layout.
- SLDBs, JBs, Control gear boxes, Single phase switch socket outlets etc. shall be mounted at 1.2 meter elevation measured from finished floor level to the bottom of the equipment unless otherwise specified.
- In some Installation types bottom elevation of every fixture is indicated in the Installation Standards – Lighting. In case the same is not included in the Installation standards or is different, then the bottom elevation of the fixture (from FFL) is included in the layout drawing.
- Lamps shall be installed after installation of light fixtures and completion of circuit cabling.
- Installation of supports for lighting fixtures, sockets, junction boxes, etc. shall be completed prior to fireproofing on steel beam/ column wherever applicable.
- For fire proofed structures, the bracket of light fittings shall be suitably decided such that fixture lies outside fire proofed column.
- Symbols shown in broken lines represent equipment installed below platforms/ under steel.

3. Laying of Lighting cable:

- All looping cables for lighting and sockets shall be routed in LV cable trays wherever available. Otherwise looping cables with multiple runs (>3) shall preferably be routed in 50/ 100/ 150 width perforated cable trays with prior consultation of Engineer-In-Charge. Single or double looping cables shall preferably be cleated on wall/ steel structure using GI spacers (min. 3 mm thick) and saddles (min. 2.5 mm thick) at every interval of 300 mm.
- Lighting cable shall be laid through hume pipe at the road crossing. Cables crossing storm water drain, shall be laid 300 mm below drain, in hume pipe.

4. Street Lighting:


- The cabling from street lighting distribution board to street lighting JB on pole shall be carried out with 4C (armoured) cable buried underground and wiring from JB on street lighting pole to light fixture shall be carried out with 3C flexible (unarmoured) cable.
- Junction box on street lighting pole shall be earthed along with pole at two distinct points.
- Street lighting cable shall be laid along the road 750 mm (min) below ground.
- In general the street light pole foundations are designed and constructed by civil group. Alternatively the same could be Electrical contractor's scope as defined in the project specific Installation standard. Based on the project specific Installation standard, concrete grade & reinforcement details for the street lighting pole foundation shall be provided by erection contractor for approval after consultation with the pole vendor.

Plant 1.0 MTPA ALUMINA REFINERY STREAM-5	Client NALCO	Contract Code NAL	Document ID 6695-ELT-G00-EC-0027	Contract No. 66-6695		
 thyssenkrupp	ELECTRICAL INSTALLATION PART- III - INSTALLATION DETAIL-LIGHTING			नालको  NALCO नेशनल एल्युमिनियम कम्पनी लिमिटेड National Aluminium Company Ltd.		
				Rev	0	Page

5. Miscellaneous:


- a. After the lighting installation is completed, load on individual circuits shall be checked and further balancing of load if required shall be done as per the instructions of Engineer-In-Charge. The details of the same shall be indicated on all the corresponding as-built drawings.

ITEM	DESCRIPTION	MATERIAL	QTY.	SUPPLY BY	INSTALLATION BY
1	AVIATION LIGHTING FIXTURE	-	1 NO.	CLIENT	ELECTRICAL CONTRACTOR
2	ISMC 75	M.S. PAINTED	AS REQUIRED	REFER NOTE-3 & 4	
3	HEXAGONAL HEAD BOLT M10 X 30mm LONG, THREADS UPTO HEAD, WITH NUTS & WASHERS SUITABLE FOR CONNECTIONS SHOWN IN THIS DRAWING	H.D.G.I.	3 SETS	ELECTRICAL CONTRACTOR	ELECTRICAL CONTRACTOR
4	HEXAGONAL HEAD BOLT M10 X 30mm LONG, THREADS UPTO HEAD, WITH NUTS & WASHERS SUITABLE FOR ORDERED LIGHTING FIXTURE (REFER NOTE-3)	H.D.G.I.	2 SETS	ELECTRICAL CONTRACTOR	ELECTRICAL CONTRACTOR
5	M10 x 75mm LONG ANCHOR FASTENER, WITH SUITABLE NUT & WASHERS	GALVANISED STEEL/SS	2 SETS	ELECTRICAL CONTRACTOR	ELECTRICAL CONTRACTOR

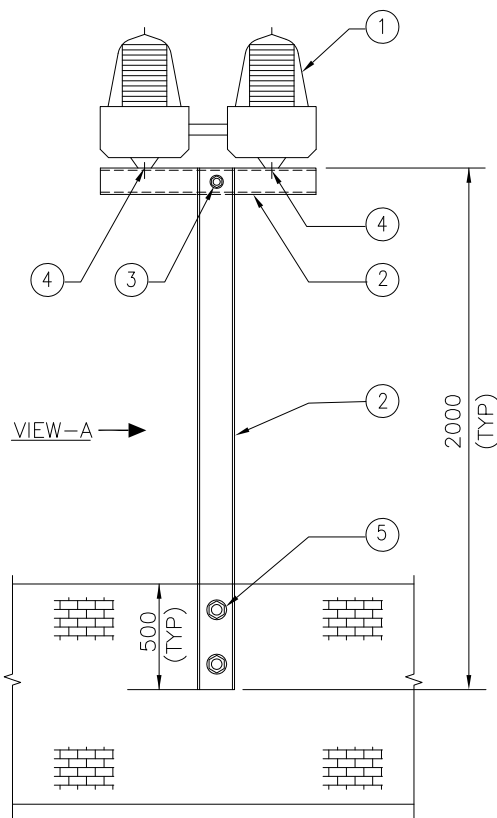

VIEW-A →

FRONT VIEW

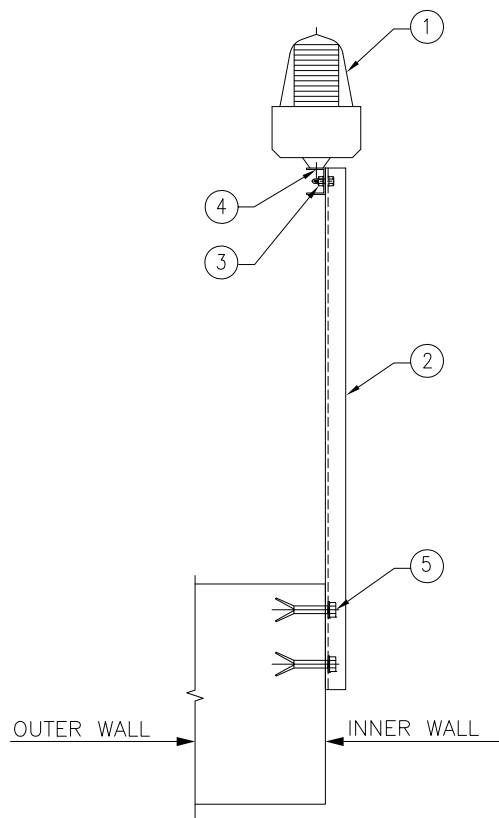

OUTER WALL →


← INNER WALL

VIEW-A

DRAWING NOT TO SCALE

NOTES:-

- 1) ALL DIMENSION ARE IN 'mm' UNLESS OTHERWISE SPECIFIED.
- 2) THE SUPPORT SHALL BE PREFABRICATED AND PAINTED BEFORE INSTALLATION.
- 3) THE DETAILS (SIZE AND DIMENSIONS) SHALL BE VERIFIED WITH ORDERED LIGHTING FIXTURE.
- 4) SUPPLY & INSTALLATION OF STEEL IS NOT PART OF THIS INSTALLATION ARRANGEMENT. SAME IS COVERED ELSEWHERE.

Code			Contract No.				Document ID				PIN-LEP-ELT-4003			Part	Rev.
00	01/08/16	RDK	ANK	01/08/16	RPM	01/08/16	RPM	ISSUED AS STANDARD				Cat. Code	Acc. Code	Status	
Rev.	Date	Name		Date	Name		Date	Name		Description					Acc. Code
BAR-Code												Store Location: Server/Share			
												Store Location: Folder			
												Store Name LAVC1			
Pro. Unit				TON			Group		Type of Document		Sheet 1 / 1				
Con. Unit				Scale		Order No.		 thyssenkrupp							
				NTS											
	Date	Name		Description INSTALLATION STANDARDS – LIGHTING AVIATION LIGHT FIXTURE ON BRACKET, ON CONCRETE/ BRICK WALL (LAVC1)											
Drawn	01/08/16	RDK													
Prepared	01/08/16	ANK													
Checked	01/08/16	RPM													
Approved	01/08/16	RPM													

1		2		3		4	
ITEM	DESCRIPTION			MATERIAL	QTY.	SUPPLY BY	INSTALLATION BY
1	AVIATION LIGHTING FIXTURE			-	1 NO.	CLIENT	ELECTRICAL CONTRACTOR
2	ISMC 75			M.S. PAINTED	AS REQUIRED	REFER NOTE-3 & 4	
3	HEXAGONAL HEAD BOLT M10 X 30mm LONG, THREADS UPTO HEAD, WITH NUTS & WASHERS SUITABLE FOR CONNECTIONS SHOWN IN THIS DRAWING			H.D.G.I.	3 SETS	ELECTRICAL CONTRACTOR	ELECTRICAL CONTRACTOR
4	HEXAGONAL HEAD BOLT M10 X 30mm LONG, THREADS UPTO HEAD, WITH NUTS & WASHERS SUITABLE FOR ORDERED LIGHTING FIXTURE (REFER NOTE-3)			H.D.G.I.	2 SETS	ELECTRICAL CONTRACTOR	ELECTRICAL CONTRACTOR
5	U BOLT M10 SIZE THREADED AT THE END SUITABLE FOR POLE / HANDRAIL WITH NUT & WASHERS.			H.D.G.I.	2 SETS	ELECTRICAL CONTRACTOR	ELECTRICAL CONTRACTOR

VIEW-A

FRONT VIEW

VIEW-B

VIEW-B

DRAWING NOT TO SCALE

NOTES:-

- 1) ALL DIMENSION ARE IN 'mm' UNLESS OTHERWISE SPECIFIED.
- 2) THE SUPPORT SHALL BE PREFABRICATED AND PAINTED BEFORE INSTALLATION.
- 3) THE DETAILS (SIZE AND DIMENSIONS) SHALL BE VERIFIED WITH ORDERED LIGHTING FIXTURE.
- 4) SUPPLY & INSTALLATION OF STEEL IS NOT PART OF THIS INSTALLATION ARRANGEMENT. SAME IS COVERED ELSEWHERE.

Code		Contract No.		Document ID				Part		Rev.		
				PIN-LEP-ELT-4003						00		
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Rev.	Date	Name		Date	Name		Date	Name		Description	Acc. Code	
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BAR-Code								Store Location: Server/Share				
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Con. Unit		Scale		Order No.								
		NTS								thyssenkrupp		
		Date		Name						Description		
Drawn		01/08/16		RDK						INSTALLATION STANDARDS - LIGHTING		
Prepared		01/08/16		ANK						AVIATION LIGHTING FIXTURE ON POLE		
Checked		01/08/16		RPM						ON STRUCTURAL STEEL RAILING		
Approved		01/08/16		RPM						(LAVR1)		

ITEM	DESCRIPTION	MATERIAL	QTY.	SUPPLY BY	INSTALLATION BY
1	CONTROL GEAR BOX	PROJECT SPECIFIC	AS PER LAYOUT	CLIENT	ELECTRICAL CONTRACTOR
2	ISMC 75	M.S. PAINTED	AS REQUIRED	REFER NOTE-3 & 4	
3	HEXAGONAL HEAD BOLT M10 X 30mm LONG, THREADS UPTO HEAD, WITH NUTS & WASHERS SUITABLE FOR CONNECTIONS SHOWN IN THIS DRAWING (REFER NOTE-3)	H.D.G.I.	4 SETS	ELECTRICAL CONTRACTOR	ELECTRICAL CONTRACTOR
4	M8 x 60mm LONG ANCHOR FASTENER, WITH SUITABLE NUT & WASHERS	GALVANISED STEEL/SS	4 SETS	ELECTRICAL CONTRACTOR	ELECTRICAL CONTRACTOR

FRONT VIEW

VIEW-B

FRONT VIEW FOR MULTIPLE C.G. BOXES

VIEW-B

DRAWING NOT TO SCALE

NOTES:-

- 1) ALL DIMENSION ARE IN 'mm' UNLESS OTHERWISE SPECIFIED.
- 2) THE SUPPORT SHALL BE PREFABRICATED AND PAINTED BEFORE INSTALLATION.
- 3) THE DETAILS (SIZE AND DIMENSIONS) SHALL BE VERIFIED WITH ORDERED C.G. BOX.
- 4) SUPPLY & INSTALLATION OF STEEL IS NOT PART OF THIS INSTALLATION ARRANGEMENT. SAME IS COVERED ELSEWHERE.

Code		Contract No.		Document ID				Part		Rev.		
				PIN-LEP-ELT-4003						00		
00	01/08/16	RDK	ANK	01/08/16	RPM	01/08/16	RPM	ISSUED AS STANDARD		Cat. Code	Acc. Code	Status
Rev.	Date	Name		Date	Name		Date	Name		Acc. Code		
		Drawn/Prepared		Date		Checked		Date		Approved		

BAR-Code				Store Location: Server/Share					
				Store Location: Folder					
				Store Name LCGC1					
Pro. Unit		TON		Group		Type of Document		Sheet 1 / 1	
Con. Unit		Scale		Order No.					
		NTS							

	Date	Name	Description
Drawn	01/08/16	RDK	INSTALLATION STANDARDS – LIGHTING CONTROL GEAR BOX MOUNTED ON BRICK WALL/CONCRTE COLUMN (LCGC1)
Prepared	01/08/16	ANK	
Checked	01/08/16	RPM	
Approved	01/08/16	RPM	

ITEM	DESCRIPTION	MATERIAL	QTY.	SUPPLY BY	INSTALLATION BY
1	CONTROL GEAR BOX	PROJECT SPECIFIC	1 NO.	CLIENT	ELECTRICAL CONTRACTOR
2	ISMC 75	M.S. PAINTED	AS REQUIRED	REFER NOTE-3 & 4	
3	HEXAGONAL HEAD BOLT M10 X 30mm LONG, THREADS UPTO HEAD, WITH NUTS & WASHERS SUITABLE FOR CONNECTIONS SHOWN IN THIS DRAWING (REFER NOTE-3)	H.D.G.I.	4 SETS	ELECTRICAL CONTRACTOR	ELECTRICAL CONTRACTOR
4	U BOLT M10 SIZE THREADED AT THE END SUITABLE FOR POLE / HANDRAIL WITH NUT & WASHERS.	H.D.G.I.	2 SETS	ELECTRICAL CONTRACTOR	ELECTRICAL CONTRACTOR

VIEW-B

VIEW-A

VIEW-A

FRONT VIEW

VIEW-B

VIEW-B

DRAWING NOT TO SCALE

NOTES:-

- ALL DIMENSION ARE IN 'mm' UNLESS OTHERWISE SPECIFIED.
- THE SUPPORT SHALL BE PREFABRICATED AND PAINTED BEFORE INSTALLATION. AREA AFFECTED DUE TO SITE WELDING SHALL BE CLEANED AND PAINTED.
- THE DETAILS (SIZE AND DIMENSIONS) SHALL BE VERIFIED WITH ORDERED C.G. BOX.
- SUPPLY & INSTALLATION OF STEEL IS NOT PART OF THIS INSTALLATION ARRANGEMENT. SAME IS COVERED ELSEWHERE.

Code		Contract No.		Document ID		Part		Rev.	
00	01/08/16	RDK	ANK	01/08/16	RPM	01/08/16	RPM	PIN-LEP-ELT-4003	
Rev.	Date	Name	Date	Name	Date	Name	Description	Acc. Code	Status
		Drawn/Prepared		Checked		Approved			

Store Location: Server/Share		Store Location: Folder		Store Name		Pro. Unit		Group		Type of Document		Sheet	
				LCGR1		TON						1 / 1	
Con. Unit		Scale		Order No.									
		NTS											

Date		Name		Description	
Drawn	01/08/16	RDK		INSTALLATION STANDARDS - LIGHTING	
Prepared	01/08/16	ANK		CONTROL GEAR BOX MOUNTED ON	
Checked	01/08/16	RPM		POLE/HANDRAIL	
Approved	01/08/16	RPM		(LCGR1)	

ITEM	DESCRIPTION	MATERIAL	QTY.	SUPPLY BY	INSTALLATION BY
1	CONTROL GEAR BOX	PROJECT SPECIFIC	AS PER LAYOUT	CLIENT	ELECTRICAL CONTRACTOR
2	ISMC 75	M.S. PAINTED	AS REQUIRED	REFER NOTE-3 & 4	
3	HEXAGONAL HEAD BOLT M10 X 30mm LONG, THREADS UPTO HEAD, WITH NUTS & WASHERS SUITABLE FOR CONNECTIONS SHOWN IN THIS DRAWING (REFER NOTE-3)	H.D.G.I.	4 SETS	ELECTRICAL CONTRACTOR	ELECTRICAL CONTRACTOR

FRONT VIEW

VIEW-B

FRONT VIEW FOR MULTIPLE C.G. BOXES

VIEW-B

NOTES:-

- ALL DIMENSION ARE IN 'mm' UNLESS OTHERWISE SPECIFIED.
- THE SUPPORT SHALL BE PREFABRICATED AND PAINTED BEFORE INSTALLATION. AREA AFFECTED DUE TO SITE WELDING SHALL BE CLEANED AND PAINTED.
- THE DETAILS (SIZE AND DIMENSIONS) SHALL BE VERIFIED WITH ORDERED C.G. BOX.
- SUPPLY & INSTALLATION OF STEEL IS NOT PART OF THIS INSTALLATION ARRANGEMENT. SAME IS COVERED ELSEWHERE.

DRAWING NOT TO SCALE

Code		Contract No.		Document ID				Part		Rev.	
00	01/08/16	RDK	ANK	01/08/16	RPM	01/08/16	RPM	PIN-LEP-ELT-4003		00	
Rev.	Date	Name		Date	Name	Date	Name	Description	Acc. Code	Cat. Code	Status
		Drawn/Prepared			Checked		Approved				

Store Location: Server/Share			
Store Location: Folder			
Store Name LCGS1			
Pro. Unit	TON	Group	Type of Document
Con. Unit	Scale	Order No.	Sheet 1 / 1

Date			Name		
Drawn	01/08/16	RDK			
Prepared	01/08/16	ANK			
Checked	01/08/16	RPM			
Approved	01/08/16	RPM			

Description	
INSTALLATION STANDARDS – LIGHTING CONTROL GEAR BOX MOUNTED ON STEEL COLUMN (LCGS1)	

1	2	3	4
ITEM	DESCRIPTION	MATERIAL	QTY.
1	EXIT SIGN FIXTURE	-	1 NO.
2	ACCESSORIES TO FIX EXIT SIGN FIXTURE SUCH AS PLASTIC ANCHORS, M10 X 30 HDGI SCREWS ETC. (REFER NOTE-2)	-	4 SETS
		SUPPLY BY	INSTALLATION BY
		CLIENT	ELECTRICAL CONTRACTOR
		ELECTRICAL CONTRACTOR	ELECTRICAL CONTRACTOR

VIEW-A

FRONT VIEW

VIEW-A

DRAWING NOT TO SCALE

NOTES

1) ALL DIMENSION ARE IN 'mm' UNLESS OTHERWISE STATED.



2) THESE DETAILS SHALL BE VERIFIED WITH ORDERED LIGHTING FIXTURE.

Code				Contract No.				Document ID				Part		Rev.	
								PIN-LEP-ELT-4003						00	
00	01.08.2017	KRP	MLD	01.08.2017	RPM	01.08.2017	RPM	ISSUED AS STANDARD				Cat. Code	Acc. Code	Status	
Rev.	Date	Name		Date	Name	Date	Name	Description				Acc. Code			
Drawn/Prepared				Checked				Approved							

BAR-Code				Store Location: Server/Share			
				Store Location: Folder			
				Store Name LESC1			
Pro. Unit		TON		Group		Type of Document	
						Sheet 1 / 1	
Con. Unit		Scale		Order No.			
		NTS					

	Date	Name	
Drawn	01.08.2017	KRP	Description INSTALLATION STANDARDS - LIGHTING EXIT SIGN FIXTURE ON CONCRETE/BRICK WALL: TYPE-1 (LESC1)
Prepared	01.08.2017	MLD	
Checked	01.08.2017	RPM	
Approved	01.08.2017	RPM	


ITEM	DESCRIPTION	MATERIAL	QTY.	SUPPLY BY	INSTALLATION BY
1	EXIT SIGN FIXTURE	—	1 NO.	CLIENT	ELECTRICAL CONTRACTOR
2	HEXAGONAL HEAD BOLT M10 X 30mm LONG, THREADS UPTO HEAD, WITH SUITABLE NUTS & WASHERS (REFER NOTE-3)	H.D.G.I.	4 SETS	ELECTRICAL CONTRACTOR	ELECTRICAL CONTRACTOR
3	ISM 75	M.S. PAINTED	AS REQUIRED	(REFER NOTE-3 & 4)	
4	ANCHOR FASTENER M8 x 60mm LONG WITH SUITABLE NUT & WASHER	GALVANISED STEEL / SS	2 SETS	ELECTRICAL CONTRACTOR	ELECTRICAL CONTRACTOR

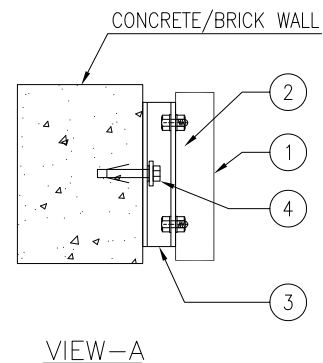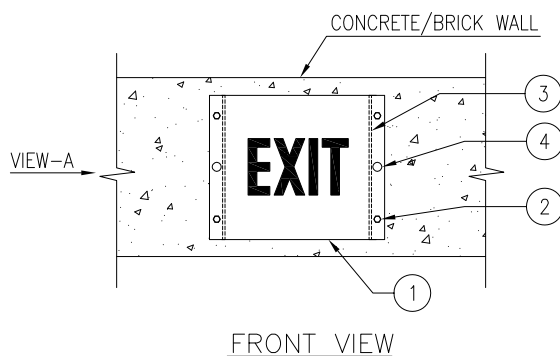

DRAWING NOT TO SCALE

NOTES

- 1) ALL DIMENSION ARE IN 'mm' UNLESS OTHERWISE STATED.
- 2) STEEL SECTIONS SHALL BE PREFABRICATED & PAINTED BEFORE INSTALLATION.
- 3) THESE DETAILS SHALL BE VERIFIED WITH ORDERED LIGHTING FIXTURE.
- 4) SUPPLY & INSTALLATION OF STEEL IS NOT PART OF THIS INSTALLATION ARRANGEMENT. SAME IS COVERED ELSEWHERE.

Code				Contract No.				Document ID				PIN-LEP-ELT-4003				Part		Rev.									
00		01.08.2017		KRP		MLD		01.08.2017		RPM		01.08.2017		RPM		ISSUED AS STANDARD						Cat. Code		Acc. Code		Status	
Rev.		Date		Name				Date		Name		Date		Name		Description				Acc. Code							
				Drawn/Prepared						Checked				Approved													
BAR-Code																Store Location: Server/Share											
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																Store Name LESC2											
				Pro. Unit				TON				Group		Type of Document				Sheet 1 / 1									
				Con. Unit				Scale				Order No.				 thyssenkrupp											
								NTS																			
		Date		Name		Description																					
Drawn		01.08.2017		KRP		INSTALLATION STANDARDS – LIGHTING																					
Prepared		01.08.2017		MLD		EXIT SIGN FIXTURE ON																					
Checked		01.08.2017		RPM		CONCRETE/BRICK WALL: TYPE 2																					
Approved		01.08.2017		RPM		(LESC2)																					

ISO A4

1	2	3	4
ITEM	DESCRIPTION	MATERIAL	QTY.
1	EXIT SIGN FIXTURE	—	1 NO.
2	HEXAGONAL HEAD BOLT M10 X 30mm LONG, THREADS UPTO HEAD, WITH SUITABLE NUTS & WASHERS (REFER NOTE-3)	H.D.G.I.	4 SETS
3	ISA 50 (50x50x6)	M.S. PAINTED	AS REQUIRED
4	ANCHOR FASTENER M8 x 60mm LONG WITH SUITABLE NUT & WASHER	GALVANISED STEEL / SS	2 SETS
5	250 x 100 X 10mm THK PLATE	M.S. PAINTED	1 NO.

FRONT VIEW

VIEW X-X

FRONT VIEW

VIEW Y-Y

NOTES

- 1) ALL DIMENSION ARE IN 'mm' UNLESS OTHERWISE STATED.
- 2) STEEL SECTIONS SHALL BE PREFABRICATED & PAINTED BEFORE INSTALLATION.
- 3) THESE DETAILS SHALL BE VERIFIED WITH ORDERED EQUIPMENT DRAWING.
- 4) SUPPLY & INSTALLATION OF STEEL IS NOT PART OF THIS INSTALLATION ARRANGEMENT. SAME IS COVERED ELSEWHERE.

DRAWING NOT TO SCALE

Code	Contract No.	Document ID	Part	Rev.
00	01.08.2017 KRP	MLD	01.08.2017 RPM	00

Rev.	Date	Name	Date	Name	Date	Name	Description	Acc. Code	Cat. Code	Acc. Code	Status
00	01.08.2017	KRP	01.08.2017	RPM	01.08.2017	RPM	ISSUED AS STANDARD				

Store Location: Server/Share	Part
Store Location: Folder	Rev.
Store Name	00
LESC3	
Pro. Unit	TON
Group	Type of Document
Sheet	1 / 1
Con. Unit	Scale
Order No.	
NTS	

Date	Name	Description
01.08.2017	KRP	INSTANTATION STANDARDS - LIGHTING
01.08.2017	MLD	EXIT SIGN ON CEILING/ SIDE OF
01.08.2017	RPM	CONCRETE COLUMN
01.08.2017	RPM	(LESC3)

1	2	3	4
ITEM	DESCRIPTION	MATERIAL	QTY.
1	EXIT SIGN FIXTURE	—	1 NO.
2	HEXAGONAL HEAD BOLT M10 X 30mm LONG, THREADS UPTO HEAD, WITH SUITABLE NUTS & WASHERS (REFER NOTE-3)	H.D.G.I.	4 SETS
3	ISA 50 (50x50x6)	M.S. PAINTED	AS REQUIRED
		(REFER NOTE-3 & 4)	

STEEL BEAM

VIEW X-X

STEEL COLUMN

VIEW Y-Y

DRAWING NOT TO SCALE

NOTES

- 1) ALL DIMENSION ARE IN 'mm' UNLESS OTHERWISE STATED.
- 2) STEEL SECTIONS SHALL BE PREFABRICATED & PAINTED BEFORE INSTALLATION.
- 3) THESE DETAILS SHALL BE VERIFIED WITH ORDERED EQUIPMENT DRAWING.
- 4) SUPPLY & INSTALLATION OF STEEL IS NOT PART OF THIS INSTALLATION ARRANGEMENT. SAME IS COVERED ELSEWHERE.

Code		Contract No.		Document ID				Part		Rev.	
00	01.08.2017	KRP	MLD	01.08.2017	RPM	01.08.2017	RPM	PIN-LEP-ELT-4003		00	
Rev.	Date	Name		Date	Name	Date	Name	Description		Acc. Code	Status
Drawn/Prepared				Checked		Approved					

BAR-Code

Store Location: Server/Share

Store Location: Folder


Store Name
LESS1

Pro. Unit: TON Group: Type of Document: Sheet: 1 / 1

Con. Unit: Scale: Order No.: **thyssenkrupp**

Date	Name	Description
Drawn	01.08.2017 KRP	INSTALLATION STANDARDS – LIGHTING EXIT SIGN ON STEEL BEAM/COLUMN (LESS1)
Prepared	01.08.2017 MLD	
Checked	01.08.2017 RPM	
Approved	01.08.2017 RPM	


A	1		2		3		4	
			50 mm					
	ITEM	DESCRIPTION	MATERIAL	QTY.	SUPPLY BY	INSTALLATION BY		
	1	DECORATIVE TYPE EXIT SIGN FIXTURE	—	1 NO.	CLIENT	ELECTRICAL CONTRACTOR		
2	ACCESSORIES REQUIRED TO FIX EXIT SIGN FIXTURE AS PER MOUNTING TYPE INDICATED IN DRAWING (ACCESSORIES SUCH AS SELF THREADED SCREWS, NUT, BOLTS, WASHERS, GI CHAIN LINKS ETC. OF SUITABLE SIZE) (REFER NOTE-2)		—	AS REQUIRED	ELECTRICAL CONTRACTOR	ELECTRICAL CONTRACTOR		

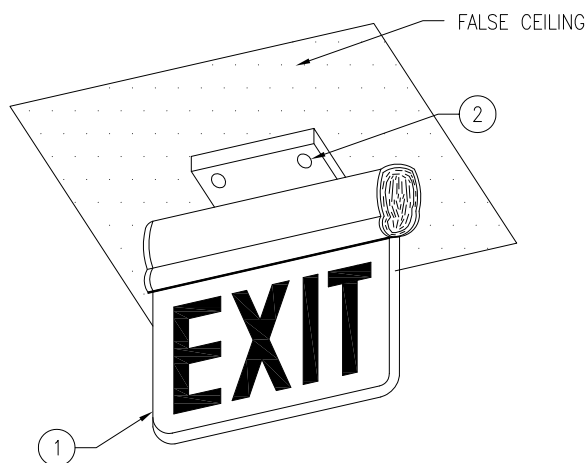

DRAWING NOT TO SCALE


NOTES

- 1) ALL DIMENSION ARE IN 'mm' UNLESS OTHERWISE STATED.
- 2) THESE DETAILS SHALL BE VERIFIED WITH ORDERED EQUIPMENT.

Code				Contract No.				Document ID				PIN-LEP-ELT-4003				Part		Rev.													
00		01.08.2017		KRP		MLD		01.08.2017		RPM		01.08.2017		RPM		ISSUED AS STANDARD						Cat. Code		Acc. Code		Status					
Rev.		Date		Name				Date		Name				Date		Name				Description				Acc. Code							
				Drawn/Prepared						Checked						Approved															
BAR-Code																Store Location: Server/Share															
																Store Location: Folder															
																Store Name LESZ1															
				Pro. Unit				TON				Group		Type of Document				Sheet 1 / 1													
				Con. Unit				Scale NTS				Order No.				 thyssenkrupp															
		Date		Name												Description															
Drawn		01.08.2017		KRP												INSTALLATION STANDARDS – LIGHTING															
Prepared		01.08.2017		MLD												DECORATIVE TYPE EXIT SIGN AT															
Checked		01.08.2017		RPM												FALSE CEILING/RECESS MOUNTED															
Approved		01.08.2017		RPM												(LESZ1)															

ISO A4

1		2		3		4	
ITEM	DESCRIPTION			MATERIAL	QTY.	SUPPLY BY	INSTALLATION BY
1	DECORATIVE TYPE EXIT SIGN FIXTURE			—	1 NO.	CLIENT	ELECTRICAL CONTRACTOR
2	ACCESSORIES REQUIRED TO FIX EXIT SIGN FIXTURE AS PER MOUNTING TYPE INDICATED IN DRAWING (ACCESSORIES SUCH AS SELF THREADED SCREWS, NUT, BOLTS, WASHERS ETC. OF SUITABLE SIZE) (REFER NOTE-2)			—	AS REQUIRED	ELECTRICAL CONTRACTOR	ELECTRICAL CONTRACTOR

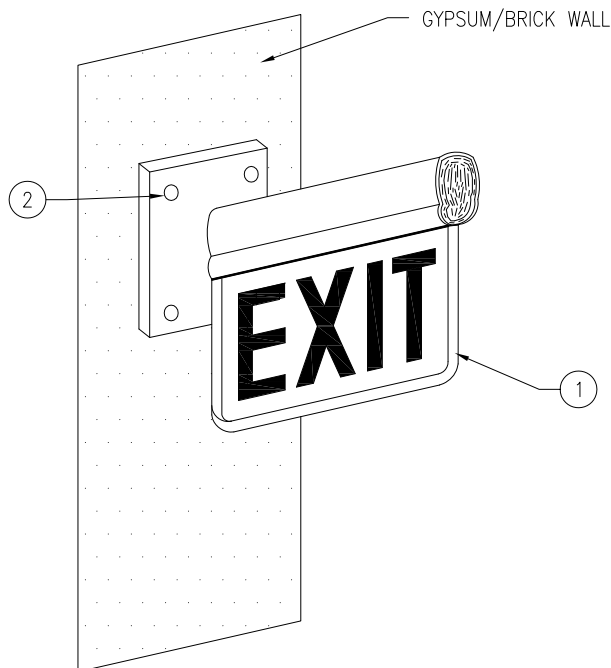

DRAWING NOT TO SCALE

NOTES

- 1) ALL DIMENSION ARE IN 'mm' UNLESS OTHERWISE STATED.
- 2) THESE DETAILS SHALL BE VERIFIED WITH ORDERED EQUIPMENT.


Code	Contract No.	Document ID	Part	Rev.
00	01.08.2017 KRP	MLD	01.08.2017 RPM	01.08.2017 RPM
ISSUED AS STANDARD				
Cat. Code	Acc. Code	Status		

Rev.	Date	Name	Date	Name	Date	Name	Description	Acc. Code			
Drawn/Prepared	Checked	Approved									
BAR-Code											
Store Location: Server/Share											
Store Location: Folder											
Store Name											
LESZ2											
Pro. Unit	TON	Group	Type of Document	Sheet							
1	/	1									
Con. Unit	Scale	Order No.									
NTS											


Date	Name	Description
Drawn	01.08.2017 KRP	INSTALLATION STANDARDS – LIGHTING
Prepared	01.08.2017 MLD	DECORATIVE TYPE EXIT SIGN
Checked	01.08.2017 RPM	ON GYPSUM/BRICK WALL
Approved	01.08.2017 RPM	(LESZ2)

ISO A4


1		2		3		4	
ITEM	DESCRIPTION			MATERIAL	QTY.	SUPPLY BY	INSTALLATION BY
1	FLOOD LIGHT FIXTURE			-	1 NO.	CLIENT	ELECTRICAL CONTRACTOR
2	150 x 150 X 10mm THK PLATE			M.S. PAINTED	1 NO.	REFER NOTE-4	
3	ISMC 75			M.S. PAINTED	AS REQUIRED	REFER NOTE-3 & 4	
4	M8 x 60mm LONG ANCHOR FASTENER, WITH SUITABLE NUT & WASHERS			GALVANISED STEEL/SS	4 SETS	ELECTRICAL CONTRACTOR	ELECTRICAL CONTRACTOR
5	HEXAGONAL HEAD BOLT M12 X 30mm LONG, THREADS UPTO HEAD, WITH NUTS & WASHERS SUITABLE FOR CONNECTIONS SHOWN IN THIS DRAWING			H.D.G.I.	1 SET	ELECTRICAL CONTRACTOR	ELECTRICAL CONTRACTOR
6	HEXAGONAL HEAD BOLT M10 X 30mm LONG, THREADS UPTO HEAD, WITH NUTS & WASHERS SUITABLE FOR ORDERED LIGHTING FIXTURE (REFER NOTE-3)			H.D.G.I.	2 SETS	ELECTRICAL CONTRACTOR	ELECTRICAL CONTRACTOR

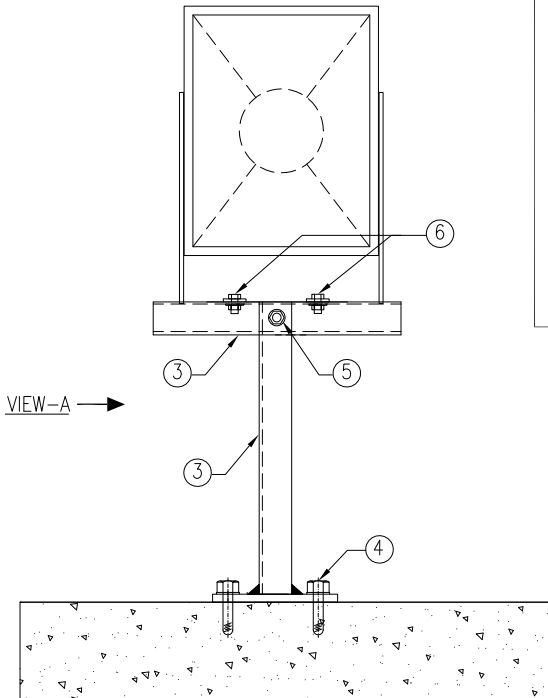

FRONT VIEW

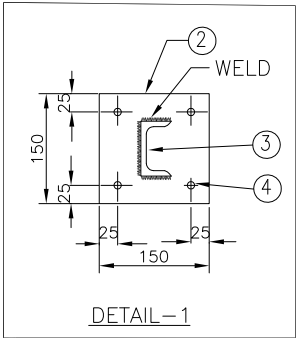

DETAIL-1

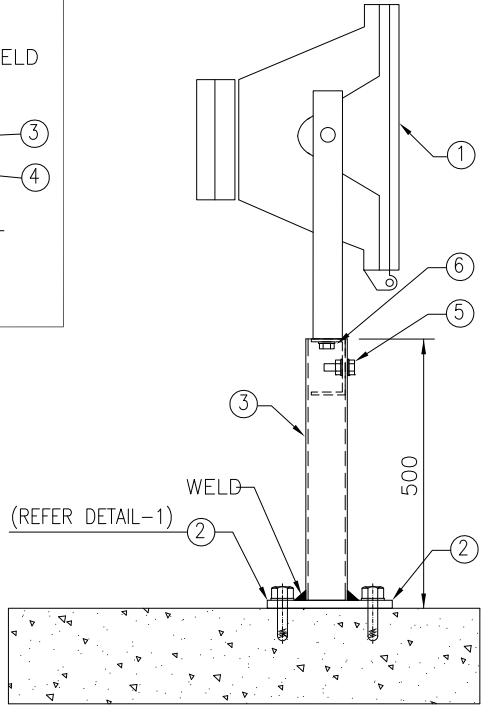

VIEW-A


DRAWING NOT TO SCALE

NOTES:-

- ALL DIMENSION ARE IN 'mm' UNLESS OTHERWISE SPECIFIED.
- THE SUPPORT SHALL BE PREFABRICATED AND PAINTED BEFORE INSTALLATION. AREA AFFECTED DUE TO SITE WELDING SHALL BE CLEANED AND PAINTED.
- THE DETAILS (SIZE AND DIMENSIONS) SHALL BE VERIFIED WITH ORDERED LIGHTING FIXTURE.
- SUPPLY & INSTALLATION OF STEEL IS NOT PART OF THIS INSTALLATION ARRANGEMENT. SAME IS COVERED ELSEWHERE.

Code		Contract No.		Document ID		Part		Rev.	
00	01/08/16	RDK	ANK	01/08/16	RPM	01/08/16	RPM	PIN-LEP-ELT-4003	
Rev.	Date	Name	Date	Name	Date	Name	Description	Acc. Code	Status
		Drawn/Prepared		Checked		Approved			

BAR-Code

Store Location	Store Name	Pro. Unit	Group	Type of Document	Sheet
Server/Share	LFDC1	TON			1 / 1
Folder					
Scale	Order No.				
NTS					

Date	Name	Description
01/08/16	RDK	INSTALLATION STANDARDS - LIGHTING FLOOD LIGHT FIXTURE ON BRACKET, ON CONCRETE FLOOR/BEAM. (LFDC1)
01/08/16	ANK	
01/08/16	RPM	
01/08/16	RPM	

1		2		3		4	
ITEM	DESCRIPTION			MATERIAL	QTY.	SUPPLY BY	INSTALLATION BY
1	FLOOD LIGHT FIXTURE			—	1 NO.	CLIENT	ELECTRICAL CONTRACTOR
2	150 x 150 X 10mm THK PLATE			M.S. PAINTED	1 NO.	REFER NOTE-4	
3	ISMC 75			M.S. PAINTED	AS REQUIRED	REFER NOTE-3 & 4	
4	M8 x 60mm LONG ANCHOR FASTENER, WITH SUITABLE NUT & WASHERS			GALVANISED STEEL/SS	4 SETS	ELECTRICAL CONTRACTOR	ELECTRICAL CONTRACTOR
5	HEXAGONAL HEAD BOLT M12 X 30mm LONG, THREADS UPTO HEAD, WITH NUTS & WASHERS SUITABLE FOR CONNECTIONS SHOWN IN THIS DRAWING			H.D.G.I.	1 SET	ELECTRICAL CONTRACTOR	ELECTRICAL CONTRACTOR
6	HEXAGONAL HEAD BOLT M10 X 30mm LONG, THREADS UPTO HEAD, WITH NUTS & WASHERS SUITABLE FOR ORDERED LIGHTING FIXTURE (REFER NOTE-3)			H.D.G.I.	2 SETS	ELECTRICAL CONTRACTOR	ELECTRICAL CONTRACTOR

SECTION A-A

DETAIL-1


NOTES:-

- 1) ALL DIMENSION ARE IN 'mm' UNLESS OTHERWISE SPECIFIED.
- 2) THE SUPPORT SHALL BE PREFABRICATED AND PAINTED BEFORE INSTALLATION. AREA AFFECTED DUE TO SITE WELDING SHALL BE CLEANED AND PAINTED.
- 3) THE DETAILS (SIZE AND DIMENSIONS) SHALL BE VERIFIED WITH ORDERED LIGHTING FIXTURE.
- 4) SUPPLY & INSTALLATION OF STEEL IS NOT PART OF THIS INSTALLATION ARRANGEMENT. SAME IS COVERED ELSEWHERE.

Code		Contract No.		Document ID		Part		Rev.	
00	01/08/16	RDK	ANK	01/08/16	RPM	01/08/16	RPM	PIN-LEP-ELT-4003	00
Rev.	Date	Name		Date	Name	Date	Name	Description	Acc. Code
		Drawn/Prepared			Checked		Approved		
BAR-Code								Store Location: Server/Share	
								Store Location: Folder	
								Store Name LFDC2	
Pro. Unit		TON		Group		Type of Document		Sheet 1 / 1	
Con. Unit		Scale		Order No.				NTS	
								thyssenkrupp	
								Description	
								INSTALLATION STANDARDS - LIGHTING FLOOD LIGHT FIXTURE ON BRACKET, ON CONCRETE WALL/COLUMN (LFDC2)	

	Date	Name
Drawn	01/08/16	RDK
Prepared	01/08/16	ANK
Checked	01/08/16	RPM
Approved	01/08/16	RPM


ITEM	DESCRIPTION	MATERIAL	QTY.	SUPPLY BY	INSTALLATION BY
1	FLOOD LIGHT LUMINAIRE	—	1 NO.	CLIENT	ELECTRICAL CONTRACTOR
2	PRE-FABRICATED NB100 PIPE (MEDIUM CLASS)	H.D.G.I.	5 METERS	ELECTRICAL CONTRACTOR	ELECTRICAL CONTRACTOR
3	ISM 75	M.S. PAINTED	AS REQUIRED	REFER NOTE 3 & 4	
4	HEXAGONAL HEAD BOLT M10 X 30mm LONG, THREADS UPTO HEAD, WITH NUTS & WASHERS SUITABLE FOR CONNECTIONS SHOWN IN THIS DRAWING (REFER NOTE-3)	H.D.G.I.	2 SETS	ELECTRICAL CONTRACTOR	CONTRACTOR
5	U BOLT M10 SIZE THREADED AT THE END SUITABLE FOR NB100 PIPE DIA. WITH NUT & WASHERS.	H.D.G.I.	1 SET	ELECTRICAL CONTRACTOR	ELECTRICAL CONTRACTOR
6	25mm ϕ 750mm LONG EARTHING ROD	H.D.G.I.	1 NO.	ELECTRICAL CONTRACTOR	ELECTRICAL CONTRACTOR
7	50mm ϕ PIPE SLEEVE 1800 LONG (INCLUSIVE OF EDGE PROTECTION FOR CABLES)	H.D.G.I.	2 NOS.	ELECTRICAL CONTRACTOR	ELECTRICAL CONTRACTOR
8	EARTHING CONDUCTOR WITH LUG AND FIXING HARDWARE. SIZE OF EARTHING CONDUCTOR & MATERIAL SHALL BE AS PER THE 'EARTHING SCHEDULE' FOR THE PROJECT.	—	AS REQUIRED	ELECTRICAL CONTRACTOR	ELECTRICAL CONTRACTOR
9	200 x 200 x 10mm THK. PLATE	M.S. PAINTED	1 NO.	REFER NOTE 4	
10	CONCRETE MATERIAL AS INDICATED FOR BASE & SQUARE SHAPE FOUNDATION, BITUMEN & MISCELLANEOUS MATERIAL AS REQUIRED	—	1 LOT	ELECTRICAL CONTRACTOR	ELECTRICAL CONTRACTOR
11	EDGE PROTECTION FOR CABLE	RUBBER	1 NO.	ELECTRICAL CONTRACTOR	ELECTRICAL CONTRACTOR

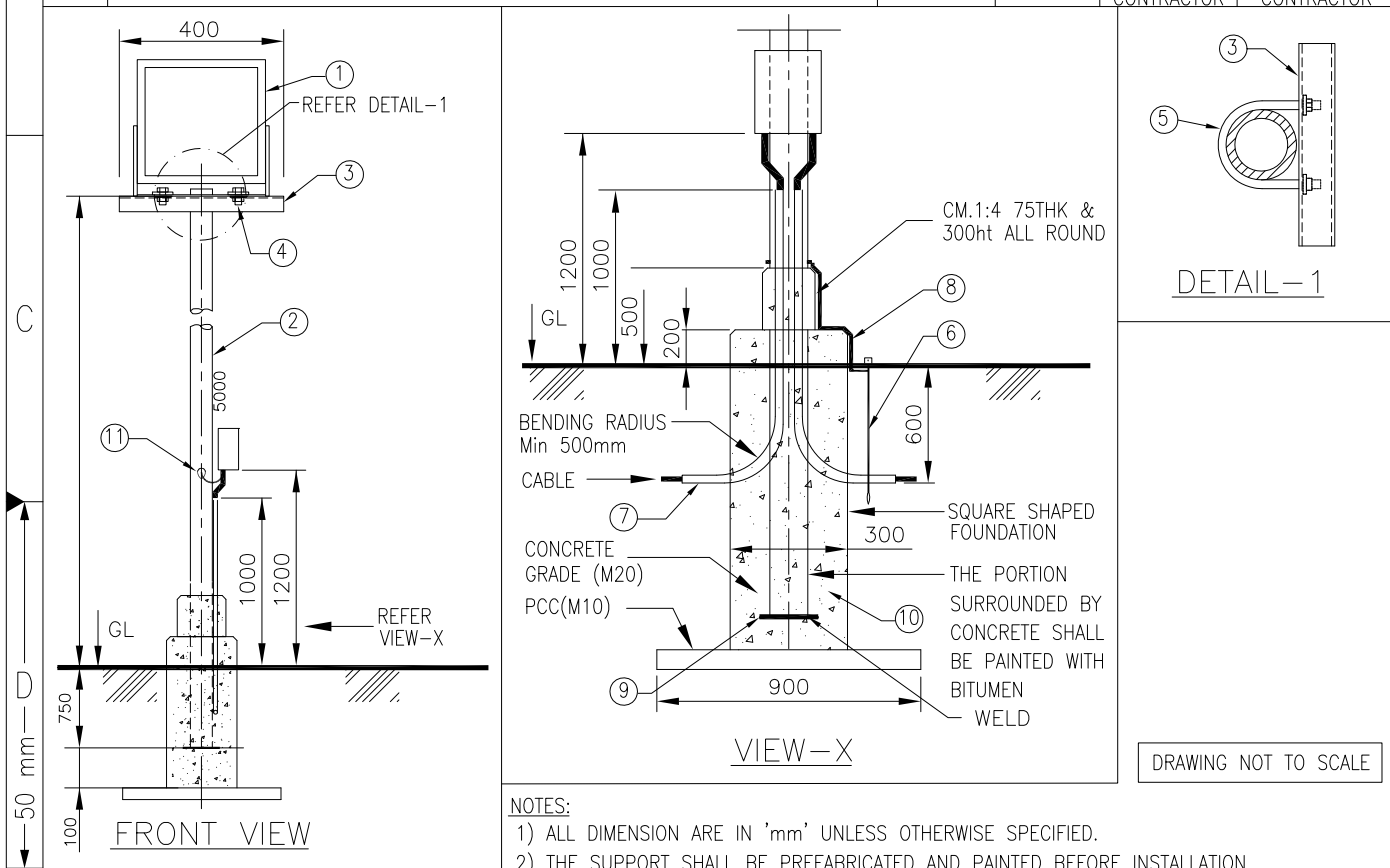


E	Code		Contract No.		Document ID		PIN-LEP-ELT-4003		Part	Rev.				
	00	01/08/16	RDK	ANK	01/08/16	RPM	01/08/16	RPM	ISSUED AS STANDARD	00				
	Rev.	Date	Name	Date	Name	Date	Name	Description	Acc. Code	Status				
	Drawn/Prepared		Checked		Approved									
F	BAR-Code						Store Location: Server/Share							
							Store Location: Folder							
							Store Name LFDP1							
	Pro. Unit	TON		Group	Type of Document		Sheet 1 / 1							
ISO A4	Con. Unit	Scale		Order No.		NTS								
							thysenkruupp							
	Date	Name		Description										
	Drawn	01/08/16 RDK		INSTALLATION STANDARDS – LIGHTING FLOOD LIGHT FIXTURE ON POLE AT GROUND LEVEL (LFDP1)										
	Prepared	01/08/16 ANK												
	Checked	01/08/16 RPM												
	Approved	01/08/16 RPM												

ITEM	DESCRIPTION	MATERIAL	QTY.	SUPPLY BY	INSTALLATION BY
1	FLOOD LIGHT FIXTURE	-	1 NO.	CLIENT	ELECTRICAL CONTRACTOR
2	PREFABRICATED NB 50 (MEDIUM CLASS) PIPE (REFER NOTE-5)	M.S. PAINTED	1.8 MTRS.	ELECTRICAL CONTRACTOR	ELECTRICAL CONTRACTOR
3	ISMC 75	H.D.G.I.	AS REQUIRED	REFER NOTE-3 & 4	
4	HEXAGONAL HEAD BOLT M10 X 30mm LONG, THREADS UPTO HEAD, WITH NUTS & WASHERS SUITABLE FOR ORDERED LIGHTING FIXTURE (REFER NOTE-3)	H.D.G.I.	2 SETS	ELECTRICAL CONTRACTOR	ELECTRICAL CONTRACTOR
5	U BOLT M10 SIZE THREADED AT THE END SUITABLE FOR FOR NB 50 PIPE WITH NUT & WASHERS.	H.D.G.I.	5 SETS	ELECTRICAL CONTRACTOR	ELECTRICAL CONTRACTOR


DRAWING NOT TO SCALE

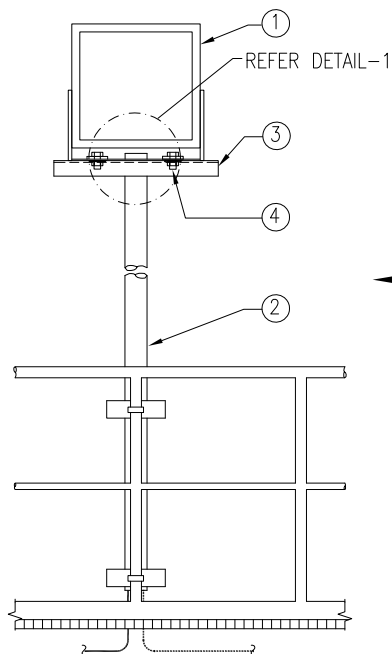


FRONT VIEW

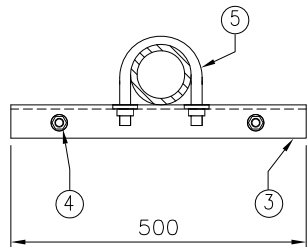

DETAIL-1

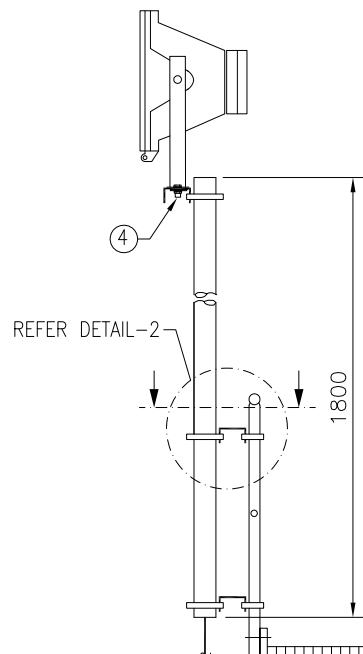

VIEW-A

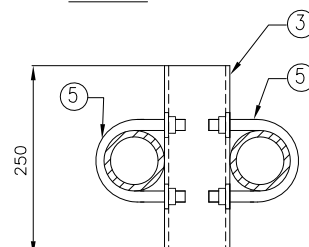

DETAIL-2

NOTES:-

- 1) ALL DIMENSION ARE IN 'mm' UNLESS OTHERWISE SPECIFIED.
- 2) THE SUPPORT SHALL BE PREFABRICATED AND PAINTED BEFORE INSTALLATION.
- 3) THE DETAILS (SIZE AND DIMENSIONS) SHALL BE VERIFIED WITH ORDERED LIGHTING FIXTURE.
- 4) SUPPLY & INSTALLATION OF STEEL IS NOT PART OF THIS INSTALLATION ARRANGEMENT. SAME IS COVERED ELSEWHERE.
- 5) THE DETAILS (SIZE AND DIMENSIONS) SHALL BE VERIFIED WITH NB 50 PIPE & HANDRAILING.

Code			Contract No.			Document ID				Part		Rev.		
						PIN-LEP-ELT-4003						00		
00	01/08/16	RDK	ANK	01/08/16	RPM	01/08/16	RPM	ISSUED AS STANDARD				Cat. Code	Acc. Code	Status
Rev.	Date	Name		Date	Name		Date	Name		Description	Acc. Code			
	Drawn/Prepared			Checked			Approved							

BAR-Code

Store Location: Server/Share

Store Location: Folder

Store Name LFDR1

Pro. Unit TON

Group

Type of Document

Sheet 1 / 1

Con. Unit

Scale

Order No.



thyssenkrupp

Description

INSTALLATION STANDARDS - LIGHTING
FLOOD LIGHT FIXTURE ON POLE,
ON STRUCTURAL STEEL RAILING
(LFDR1)

	Date	Name
Drawn	01/08/16	RDK
Prepared	01/08/16	ANK
Checked	01/08/16	RPM
Approved	01/08/16	RPM

ISO A4

1	2	3	4
ITEM	DESCRIPTION	MATERIAL	QTY.
1	FLOOD LIGHT FIXTURE	—	1 NO.
2	ISMC 75	M.S. PAINTED	AS REQUIRED
3	HEXAGONAL HEAD BOLT M12 X 30mm LONG, THREADS UPTO HEAD, WITH NUTS & WASHERS SUITABLE FOR CONNECTIONS SHOWN IN THIS DRAWING	H.D.G.I.	1 SET
4	HEXAGONAL HEAD BOLT M12 X 30mm LONG, THREADS UPTO HEAD, WITH NUTS & WASHERS SUITABLE FOR ORDERED LIGHTING FIXTURE (REFER NOTE-3)	H.D.G.I.	2 SETS

500 (MAX)

SECTION A-A

DRAWING NOT TO SCALE

NOTES:-

- 1) ALL DIMENSION ARE IN 'mm' UNLESS OTHERWISE SPECIFIED.
- 2) THE SUPPORT SHALL BE PREFABRICATED AND PAINTED BEFORE INSTALLATION.
- 3) THE DETAILS (SIZE AND DIMENSIONS) SHALL BE VERIFIED WITH ORDERED LIGHTING FIXTURE.
- 4) SUPPLY & INSTALLATION OF STEEL IS NOT PART OF THIS INSTALLATION ARRANGEMENT. SAME IS COVERED ELSEWHERE.

Code	Contract No.	Document ID	Part	Rev.
00	01/08/16 RDK ANK	01/08/16 RPM	PIN-LEP-ELT-4003	00
Rev.	Date	Name	Description	Status
00	01/08/16	RDK	ISSUED AS STANDARD	00
Rev.	Date	Name	Description	Status
00	01/08/16	RDK	ISSUED AS STANDARD	00

Store Location: Server/Share	Cat. Code
Store Location: Folder	Acc. Code
Store Name LFDS1	Status
Pro. Unit TON	Group
Type of Document	Sheet 1 / 1
Con. Unit NTS	Order No.

Drawn	01/08/16	RDK	Description INSTALLATION STANDARDS – LIGHTING FLOOD LIGHT FIXTURE ON BRACKET, ON STRUCTURAL STEEL COLUMN (LFDS1)
Prepared	01/08/16	ANK	
Checked	01/08/16	RPM	
Approved	01/08/16	RPM	

ITEM	DESCRIPTION	MATERIAL	QTY.	SUPPLY BY	INSTALLATION BY
1	FLOOD LIGHT FIXTURE	—	1 NO.	CLIENT	ELECTRICAL CONTRACTOR
2	ISMC 75	M.S. PAINTED	AS REQUIRED	REFER NOTE-3 & 4	
3	HEXAGONAL HEAD BOLT M12 X 30mm LONG, THREADS UPTO HEAD, WITH NUTS & WASHERS SUITABLE FOR CONNECTIONS SHOWN IN THIS DRAWING	H.D.G.I.	1 SET	ELECTRICAL CONTRACTOR	ELECTRICAL CONTRACTOR
4	HEXAGONAL HEAD BOLT M10 X 30mm LONG, THREADS UPTO HEAD, WITH NUTS & WASHERS SUITABLE FOR ORDERED LIGHTING FIXTURE (REFER NOTE-3)	H.D.G.I.	2 SETS	ELECTRICAL CONTRACTOR	ELECTRICAL CONTRACTOR

VIEW-A

FRONT VIEW

DRAWING NOT TO SCALE

NOTES:-


- 1) ALL DIMENSION ARE IN 'mm' UNLESS OTHERWISE SPECIFIED.
- 2) THE SUPPORT SHALL BE PREFABRICATED AND PAINTED BEFORE INSTALLATION.
- 3) THE DETAILS (SIZE AND DIMENSIONS) SHALL BE VERIFIED WITH ORDERED LIGHTING FIXTURE.
- 4) SUPPLY & INSTALLATION OF STEEL IS NOT PART OF THIS INSTALLATION ARRANGEMENT. SAME IS COVERED ELSEWHERE.

Code		Contract No.		Document ID		Part		Rev.	
00	01/08/16	RDK	ANK	01/08/16	RPM	PIN-LEP-ELT-4003		00	
Rev.	Date	Name	Date	Name	Date	Name	Description	Acc. Code	Status
		Drawn/Prepared		Checked		Approved			

Store Location: Server/Share	
Store Location: Folder	
Store Name LFDS2	
Pro. Unit	TON
Group	Type of Document
Sheet	1 / 1
Con. Unit	Scale
Order No.	

Date	Name	Description
Drawn	01/08/16 RDK	INSTALLATION STANDARDS – LIGHTING FLOOD LIGHT FIXTURE ON BRACKET, ON STRUCTURAL STEEL BEAM (LFDS2)
Prepared	01/08/16 ANK	
Checked	01/08/16 RPM	
Approved	01/08/16 RPM	

ITEM	DESCRIPTION	MATERIAL	QTY.	SUPPLY BY	INSTALLATION BY
1	FLUORESCENT / LED LIGHTING FIXTURE	-	1 NO.	CLIENT	ELECTRICAL CONTRACTOR
2	ISMC 75	M.S. PAINTED	AS REQUIRED	REFER NOTE-3 & 4	
3	HEXAGONAL HEAD BOLT M10 X 30mm LONG, THREADS UPTO HEAD, WITH NUTS & WASHERS SUITABLE FOR CONNECTIONS SHOWN IN THIS DRAWING (REFER NOTE-3)	H.D.G.I.	2 SETS	ELECTRICAL CONTRACTOR	ELECTRICAL CONTRACTOR
4	M8 x 60mm LONG ANCHOR FASTENER, WITH SUITABLE NUT & WASHERS	GALVANISED STEEL/SS	2 SETS	ELECTRICAL CONTRACTOR	ELECTRICAL CONTRACTOR

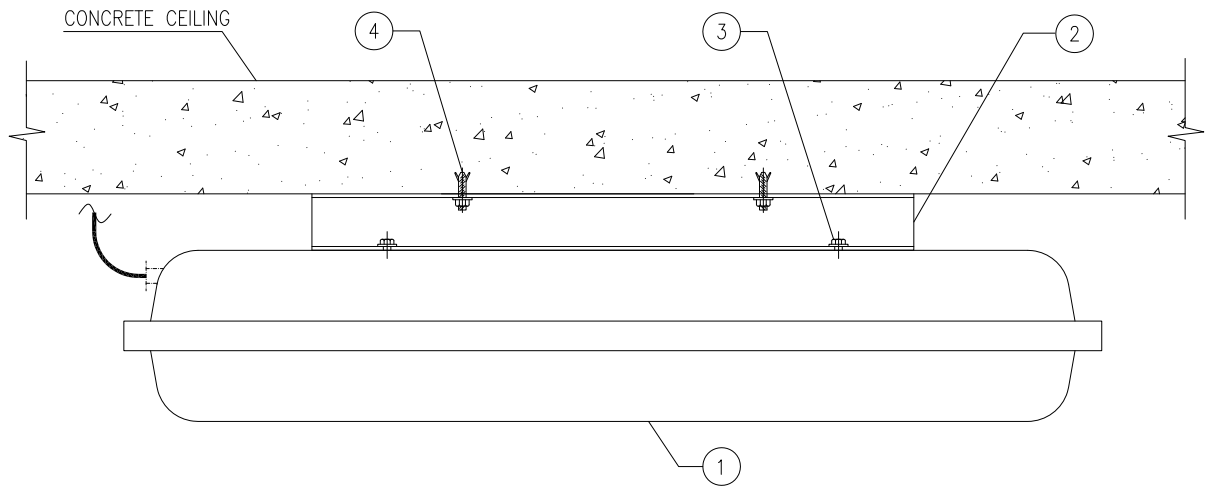

DRAWING NOT TO SCALE

NOTES:-

- 1) ALL DIMENSION ARE IN 'mm' UNLESS OTHERWISE SPECIFIED.
- 2) THE SUPPORT SHALL BE PREFABRICATED AND PAINTED BEFORE INSTALLATION.
- 3) THE DETAILS (SIZE AND DIMENSIONS) SHALL BE VERIFIED WITH ORDERED LIGHTING FIXTURE.
- 4) SUPPLY & INSTALLATION OF STEEL IS NOT PART OF THIS INSTALLATION ARRANGEMENT. SAME IS COVERED ELSEWHERE.

Code		Contract No.		Document ID				Part		Rev.											
				PIN-LEP-ELT-4003						00											
00	01/08/16	RDK	ANK	01/08/16	RPM	01/08/16	RPM	ISSUED AS STANDARD	Cat. Code	Acc. Code	Status										
Rev.	Date	Name		Date	Name	Date	Name	Description	Acc. Code												
		Drawn/Prepared			Checked		Approved														
BAR-Code								Store Location: Server/Share													
								Store Location: Folder													
								Store Name LFLC1													
Pro. Unit				TON		Group		Type of Document		Sheet 1 / 1											
Con. Unit				Scale		Order No.		thyssenkrupp													
								NTS													
<table border="1"> <tr> <td>Date</td> <td>Name</td> </tr> <tr> <td>01/08/16</td> <td>RDK</td> </tr> <tr> <td>01/08/16</td> <td>ANK</td> </tr> <tr> <td>01/08/16</td> <td>RPM</td> </tr> <tr> <td>01/08/16</td> <td>RPM</td> </tr> </table>								Date	Name	01/08/16	RDK	01/08/16	ANK	01/08/16	RPM	01/08/16	RPM	Description INSTALLATION STANDARDS - LIGHTING FLUORESCENT/LED LIGHTING FIXTURE MOUNTED ON CONCRETE CEILING (LFLC1)			
Date	Name																				
01/08/16	RDK																				
01/08/16	ANK																				
01/08/16	RPM																				
01/08/16	RPM																				

1		2		3		4	
ITEM	DESCRIPTION			MATERIAL	QTY.	SUPPLY BY	INSTALLATION BY
1	FLUORESCENT / LED LIGHTING FIXTURE			-	1 NO.	CLIENT	ELECTRICAL CONTRACTOR
2	ISMC 75			M.S. PAINTED	AS REQUIRED	REFER NOTE-3 & 4	
3	HEXAGONAL HEAD BOLT M10 X 30mm LONG, THREADS UPTO HEAD, WITH NUTS & WASHERS SUITABLE FOR CONNECTIONS SHOWN IN THIS DRAWING			H.D.G.I.	2 SETS	ELECTRICAL CONTRACTOR	ELECTRICAL CONTRACTOR
4	HEXAGONAL HEAD BOLT M10 X 30mm LONG, THREADS UPTO HEAD, WITH NUTS & WASHERS SUITABLE FOR ORDERED LIGHTING FIXTURE (REFER NOTE-3)			H.D.G.I.	2 SETS	ELECTRICAL CONTRACTOR	ELECTRICAL CONTRACTOR
5	M8 x 60mm LONG ANCHOR FASTENER, WITH SUITABLE NUT & WASHERS			GALVANISED STEEL/SS	2 SETS	ELECTRICAL CONTRACTOR	ELECTRICAL CONTRACTOR
6	ISMC 75			M.S. PAINTED	AS REQUIRED	REFER NOTE-4 & 5	

DRAWING NOT TO SCALE

NOTES:-

- ALL DIMENSION ARE IN 'mm' UNLESS OTHERWISE SPECIFIED.
- THE SUPPORT SHALL BE PREFABRICATED AND PAINTED BEFORE INSTALLATION.
- THE DETAILS (SIZE AND DIMENSIONS) SHALL BE VERIFIED WITH ORDERED LIGHTING FIXTURE.
- SUPPLY & INSTALLATION OF STEEL IS NOT PART OF THIS INSTALLATION ARRANGEMENT. SAME IS COVERED ELSEWHERE.
- LENGTH OF ITEM 6 SHALL BE DECIDED WITH RESPECT TO LAYOUT DRAWING OR WITH CONSULTATION OF SITE ENGINEER. LENGTH SHALL BE RESTRICTED TO MAXIMUM 3 METERS.

Code		Contract No.		Document ID		Part		Rev.	
00	01/08/16	RDK	ANK	01/08/16	RPM	01/08/16	RPM	PIN-LEP-ELT-4003	
Rev.	Date	Name	Date	Name	Date	Name	Description	Acc. Code	Status
		Drawn/Prepared		Checked		Approved			

Store Location: Server/Share		Store Location: Folder		Store Name		Pro. Unit		Group		Type of Document		Sheet	
				LFLC2		TON						1 / 1	
Con. Unit		Scale		Order No.									
NTS													

Date	Name	Description
01/08/16	RDK	INSTALLED STANDARDS - LIGHTING
01/08/16	ANK	FLUORESCENT/LED LIGHTING FIXTURE
01/08/16	RPM	SUSPENDED FROM CONCRETE CEILING
01/08/16	RPM	(LFLC2)

1		2		3		4	
ITEM	DESCRIPTION			MATERIAL	QTY.	SUPPLY BY	INSTALLATION BY
1	FLUORESCENT/LED LIGHT FIXTURE			-	1 NO.	CLIENT	ELECTRICAL CONTRACTOR
2	PREFABRICATED NB 50 (MEDIUM CLASS) PIPE (REFER NOTE-5)			H.D.G.I.	2 METERS	ELECTRICAL CONTRACTOR	ELECTRICAL CONTRACTOR
3	PIPE CLAMP FOR NB 50 PIPE WITH M6x20 HEXAGONAL BOLT, NUTS & WASHERS			H.D.G.I.	2 SETS	ELECTRICAL CONTRACTOR	ELECTRICAL CONTRACTOR
4	ISMC 75			M.S. PAINTED	AS REQUIRED	REFER NOTE-3 & 4	
5	M8 x 60mm LONG ANCHOR FASTENER, WITH SUITABLE NUT & WASHERS			GALVANISED STEEL/SS	4 SETS	ELECTRICAL CONTRACTOR	ELECTRICAL CONTRACTOR
6	U BOLT M10 SIZE THREADED AT THE END SUITABLE FOR NB 50 PIPE WITH NUT AND WASHERS			H.D.G.I.	2 SETS	ELECTRICAL CONTRACTOR	ELECTRICAL CONTRACTOR
7	HEXAGONAL HEAD BOLT M10 X 30mm LONG, THREADS UPTO HEAD, WITH NUTS & WASHERS SUITABLE FOR ORDERED LIGHTING FIXTURE (REFER NOTE-3)			H.D.G.I.	2 SETS	ELECTRICAL CONTRACTOR	ELECTRICAL CONTRACTOR
8	EDGE PROTECTION FOR CABLE			RUBBER	1 NO.	ELECTRICAL CONTRACTOR	ELECTRICAL CONTRACTOR

B

C

DETAIL - 1

DETAIL - 2

DRAWING NOT TO SCALE

NOTES:-

- 1) ALL DIMENSION ARE IN 'mm' UNLESS OTHERWISE SPECIFIED.
- 2) THE SUPPORT SHALL BE PREFABRICATED AND PAINTED BEFORE INSTALLATION.
- 3) THE DETAILS (SIZE AND DIMENSIONS) SHALL BE VERIFIED WITH ORDERED LIGHTING FIXTURE.
- 4) SUPPLY & INSTALLATION OF STEEL IS NOT PART OF THIS INSTALLATION ARRANGEMENT. SAME IS COVERED ELSEWHERE.
- 5) THE DETAILS (SIZE AND DIMENSIONS) SHALL BE VERIFIED WITH NB 50 & NB 80 PIPE.

Code		Contract No.		Document ID		Part		Rev.	
				PIN-LEP-ELT-4003				00	
00	01/08/16	RDK	ANK	01/08/16	RPM	01/08/16	RPM	ISSUED AS STANDARD	
Rev.	Date	Name		Date	Name	Date	Name	Description	Acc. Code
		Drawn/Prepared			Checked		Approved		

BAR-Code

Store Location: Server/Share

Store Location: Folder

Store Name LFLC3

Pro. Unit	TON	Group	Type of Document	Sheet
Con. Unit	Scale	Order No.	1 / 1	

NTS

thyszenkrupp

Date	Name	Description
Drawn	01/08/16 RDK	INSTALLATION STANDARDS - LIGHTING FLUORESCENT/LED LIGHTING FIXTURE ON POLE, BRACKET ON WALL/COLUMN (LFLC3)
Prepared	01/08/16 ANK	
Checked	01/08/16 RPM	
Approved	01/08/16 RPM	

1	2	3	4
ITEM	DESCRIPTION	MATERIAL	QTY.
1	FLUORESCENT/LED LIGHTING FIXTURE	—	1 NO.
2	ISMC 75	M.S. PAINTED	AS REQUIRED
3	HEXAGONAL HEAD BOLT M10 X 30mm LONG, THREADS UPTO HEAD, WITH NUTS & WASHERS SUITABLE FOR CONNECTIONS SHOWN IN THIS DRAWING	H.D.G.I.	4 SETS
4	M8 x 60mm LONG ANCHOR FASTENER, WITH SUITABLE NUT & WASHERS	GALVANISED STEEL/SS	2 SETS
5	ISA 65	M.S. PAINTED	AS REQUIRED
6	HEXAGONAL HEAD BOLT M10 X 30mm LONG, THREADS UPTO HEAD, WITH NUTS & WASHERS SUITABLE FOR ORDERED LIGHTING FIXTURE (REFER NOTE-3)	H.D.G.I.	2 SETS

VIEW-A

VIEW-B

DRAWING NOT TO SCALE

NOTES:-


- 1) ALL DIMENSION ARE IN 'mm' UNLESS OTHERWISE SPECIFIED.
- 2) THE SUPPORT SHALL BE PREFABRICATED AND PAINTED BEFORE INSTALLATION.
- 3) THE DETAILS (SIZE AND DIMENSIONS) SHALL BE VERIFIED WITH ORDERED LIGHTING FIXTURE.
- 4) SUPPLY & INSTALLATION OF STEEL IS NOT PART OF THIS INSTALLATION ARRANGEMENT. SAME IS COVERED ELSEWHERE.

Code		Contract No.		Document ID		Part		Rev.	
00	01/08/16	RDK	ANK	01/08/16	RPM	01/08/16	RPM	PIN-LEP-ELT-4003	00
Rev.	Date	Name	Date	Name	Date	Name	Description	Acc. Code	Status
		Drawn/Prepared		Checked		Approved			

Store Location: Server/Share	
Store Location: Folder	
Store Name LFLC4	
Pro. Unit TON	Group
Type of Document	Sheet 1 / 1
Con. Unit	Order No.
NTS	


Date	Name	Description
Drawn 01/08/16	RDK	INSTALLATION STANDARDS – LIGHTING FLUORESCENT/LED LIGHTING FIXTURE MOUNTED ON CONCRETE WALL/COLUMN (LFLC4)
Prepared 01/08/16	ANK	
Checked 01/08/16	RPM	
Approved 01/08/16	RPM	

1		2		3		4	
ITEM	DESCRIPTION	MATERIAL	QTY.	SUPPLY BY	INSTALLATION BY		
1	FLUORESCENT/LED LIGHTING FIXTURE	—	1 NO.	CLIENT	ELECTRICAL CONTRACTOR		
2	CHAIN LINK WITH FAIL SAFE LOCKING ARRANGEMENT AT ENDS	H.D.G.I.	6 METERS	ELECTRICAL CONTRACTOR	ELECTRICAL CONTRACTOR		
3	ISA 65 (65X65X6mm)	M.S. PAINTED	AS REQUIRED	REFER NOTE-3 & 4			
4	M8 x 60mm LONG ANCHOR FASTENER, WITH SUITABLE NUT & WASHERS	GALVANISED STEEL/SS	2 SETS	ELECTRICAL CONTRACTOR	ELECTRICAL CONTRACTOR		
5	HEXAGONAL HEAD BOLT M10 X 30mm LONG, THREADS UPTO HEAD, WITH NUTS & WASHERS SUITABLE FOR ORDERED LIGHTING FIXTURE (REFER NOTE-3)	H.D.G.I.	2 SETS	ELECTRICAL CONTRACTOR	ELECTRICAL CONTRACTOR		

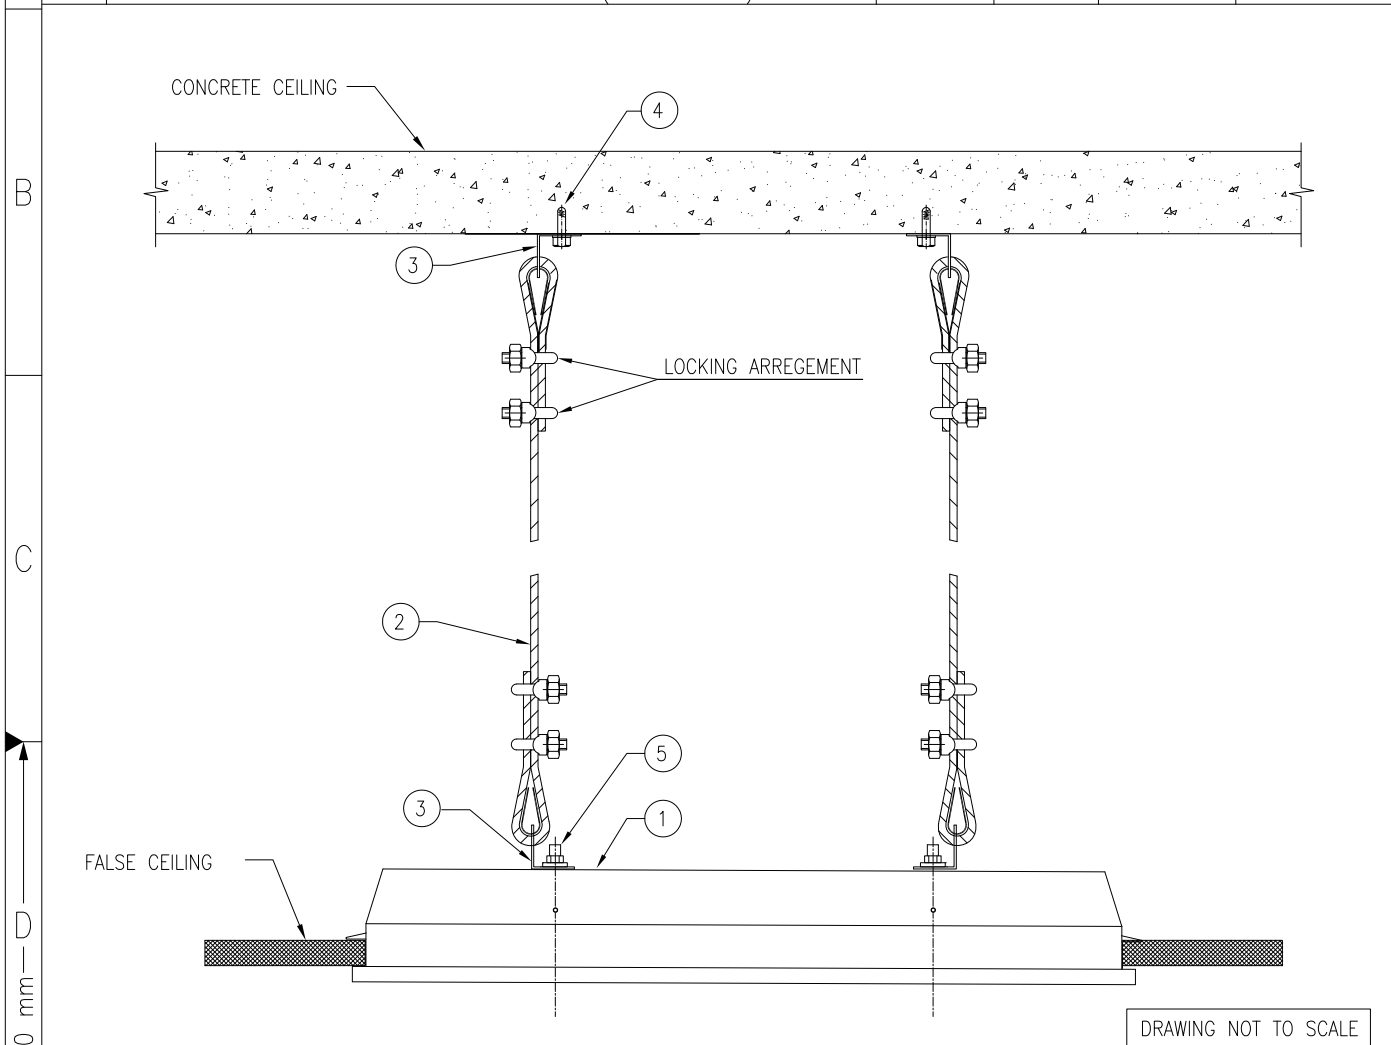

NOTES:-

- 1) ALL DIMENSION ARE IN 'mm' UNLESS OTHERWISE SPECIFIED.
- 2) THE SUPPORT SHALL BE PREFABRICATED AND PAINTED BEFORE INSTALLATION.
- 3) THE DETAILS (SIZE AND DIMENSIONS) SHALL BE VERIFIED WITH ORDERED LIGHTING FIXTURE.
- 4) SUPPLY & INSTALLATION OF STEEL IS NOT PART OF THIS INSTALLATION ARRANGEMENT. SAME IS COVERED ELSEWHERE.

E	Code			Contract No.				Document ID				PIN-LEP-ELT-4003				Part		Rev. 00	
	00	01/08/16	RDK	ANK	01/08/16	RPM		01/08/16	RPM		ISSUED AS STANDARD				Cat. Code	Acc. Code	Status		
	Rev.	Date	Name		Date	Name		Date	Name		Description			Acc. Code					
F	BAR-Code										Store Location: Server/Share								
											Store Location: Folder								
											Store Name LFLF1								
	Pro. Unit		TON			Group		Type of Document			Sheet 1 / 1								
	Con. Unit		Scale		Order No.			 thyssenkrupp											
			NTS																
			Date		Name		Description INSTALLATION STANDARDS – LIGHTING FLUORESCENT/LED LIGHTING FIXTURE RECESSED IN FALSE CEILING (LFLF1)												
Drawn		01/08/16		RDK															
Prepared		01/08/16		ANK															
Checked		01/08/16		RPM															
ISO A4	Approved		01/08/16		RPM														

1		2		3		4	
ITEM	DESCRIPTION			MATERIAL	QTY.	SUPPLY BY	INSTALLATION BY
1	FLUORESCENT/LED LIGHTING FIXTURE (SQUARE TILE)			-	1 NO.	CLIENT	ELECTRICAL CONTRACTOR
2	CHAIN LINK WITH FAIL SAFE LOCKING ARRANGEMENT AT ENDS (REFER NOTE-5)			H.D.G.I.	6 METERS	ELECTRICAL CONTRACTOR	ELECTRICAL CONTRACTOR
3	ISA 65 (65X65X6mm)			M.S. PAINTED	AS REQUIRED	REFER NOTE-3 & 4	
4	M8 x 60mm LONG ANCHOR FASTENER, WITH SUITABLE NUT & WASHERS			GALVANISED STEEL/SS	2 SETS	ELECTRICAL CONTRACTOR	ELECTRICAL CONTRACTOR
5	HEXAGONAL HEAD BOLT M10 X 30mm LONG, THREADS UPTO HEAD, WITH NUTS & WASHERS SUITABLE FOR ORDERED LIGHTING FIXTURE (REFER NOTE-3)			H.D.G.I.	2 SETS	ELECTRICAL CONTRACTOR	ELECTRICAL CONTRACTOR

CONCRETE CEILING

FALSE CEILING

LOCKING ARREGEMENT

DRAWING NOT TO SCALE

NOTES:-

- 1) ALL DIMENSION ARE IN 'mm' UNLESS OTHERWISE SPECIFIED.
- 2) THE SUPPORT SHALL BE PREFABRICATED AND PAINTED BEFORE INSTALLATION.
- 3) THE DETAILS (SIZE AND DIMENSIONS) SHALL BE VERIFIED WITH ORDERED LIGHTING FIXTURE.
- 4) SUPPLY & INSTALLATION OF STEEL IS NOT PART OF THIS INSTALLATION ARRANGEMENT. SAME IS COVERED ELSEWHERE.
- 5) CHAIN LINKS SHALL BE INSTALLED ON DIAGONAL OPPOSITE ENDS.

Code		Contract No.		Document ID		Part		Rev.	
00	01/08/16	RDK	ANK	01/08/16	RPM	01/08/16	RPM	PIN-LEP-ELT-4003	00
Rev.	Date	Name	Date	Name	Date	Name	Description	Acc. Code	Status
		Drawn/Prepared		Checked		Approved			

Store Location: Server/Share		Store Location: Folder		Store Name		Pro. Unit		Group		Type of Document		Sheet	
				LFLF2		TON						1 / 1	
Con. Unit		Scale		Order No.									
NTS													

Date		Name		Description	
Drawn	01/08/16	RDK		INSTALLATION STANDARDS - LIGHTING	
Prepared	01/08/16	ANK		FLUORESCENT/LED (SQUARE TILE) LIGHTING	
Checked	01/08/16	RPM		FIXTURE RECESSED IN FALSE CEILING	
Approved	01/08/16	RPM		(LFLF2)	

1	2	3	4
ITEM	DESCRIPTION	MATERIAL	QTY.
1	FLUORESCENT/LED LIGHTING FIXTURE	—	1 NO.
2	ISMC 75	M.S. PAINTED	AS REQUIRED
3	HEXAGONAL HEAD BOLT M10 X 30mm LONG, THREADS UPTO HEAD, WITH NUTS & WASHERS SUITABLE FOR ORDERED LIGHTING FIXTURE (REFER NOTE-3)	H.D.G.I.	2 SETS
4	1.1 KV INSULATOR, MINIMUM HEIGHT 50 mm WITH 2 SETS OF BOLTS TO SUIT INSULATOR	EPOXY	2 SETS

A

B

C

D

E

SUSPENSION OF FLUORESCENT LUMINAIRE

NOTE : INSULATORS SHALL HAVE ARRANGEMENT FOR BOLTING AT TOP & BOTTOM

DRAWING NOT TO SCALE

F

NOTES:-

- ALL DIMENSION ARE IN 'mm' UNLESS OTHERWISE SPECIFIED.
- THE SUPPORT SHALL BE PREFABRICATED AND PAINTED BEFORE INSTALLATION.
- THE DETAILS (SIZE AND DIMENSIONS) SHALL BE VERIFIED WITH ORDERED LIGHTING FIXTURE.
- SUPPLY & INSTALLATION OF STEEL IS NOT PART OF THIS INSTALLATION ARRANGEMENT. SAME IS COVERED ELSEWHERE.

ISO A4

Code	Contract No.	Document ID	Part	Rev.
00	01/08/16 RDK	ANK	01/08/16 RPM	01/08/16 RPM
Rev.	Date	Name	Date	Name
Drawn/Prepared	Checked	Approved	Description	Acc. Code
BAR-Code			Store Location: Server/Share	
			Store Location: Folder	
			Store Name LFLK1	
Pro. Unit	TON	Group	Type of Document	Sheet 1 / 1
Con. Unit	Scale	Order No.		
NTS				
Drawn	01/08/16	RDK	Description INSTALLATION STANDARDS – LIGHTING FLUORESCENT/LED LIGHTING FIXTURE FOR CELL RACK ILLUMINATION (LFLK1)	
Prepared	01/08/16	ANK		
Checked	01/08/16	RPM		
Approved	01/08/16	RPM		

1		2		3		4	
ITEM	DESCRIPTION			MATERIAL	QTY.	SUPPLY BY	INSTALLATION BY
1	FLUORESCENT/LED LIGHT LUMINAIRE			-	1 NO.	CLIENT	ELECTRICAL CONTRACTOR
2	PREFABRICATED NB 80 (MEDIUM CLASS) PIPE (REFER NOTE-5)			H.D.G.I.	2.5 MTRS	ELECTRICAL CONTRACTOR	ELECTRICAL CONTRACTOR
3	PIPE CLAMP FOR NB 50 PIPE WITH M6x20 HEXAGONAL BOLT, NUTS & WASHERS			H.D.G.I.	2 SETS	ELECTRICAL CONTRACTOR	ELECTRICAL CONTRACTOR
4	ISM 75			M.S. PAINTED	AS REQUIRED	REFER NOTE-4	
5	HEXAGONAL HEAD BOLT M10 X 30mm LONG, THREADS UPTO HEAD, WITH NUTS & WASHERS SUITABLE FOR ORDERED LIGHTING FIXTURE (REFER NOTE-3)			H.D.G.I.	2 SETS	ELECTRICAL CONTRACTOR	ELECTRICAL CONTRACTOR
6	U BOLT M10 SIZE THREADED AT THE END SUITABLE FOR NB 80 PIPE WITH NUT AND WASHERS			H.D.G.I.	4 SETS	ELECTRICAL CONTRACTOR	ELECTRICAL CONTRACTOR
7	80 NB x 50 NB REDUCER			H.D.G.I.	4 SETS	ELECTRICAL CONTRACTOR	ELECTRICAL CONTRACTOR
8	PREFABRICATED NB 50 (MEDIUM CLASS) PIPE (REFER NOTE-5)			H.D.G.I.	1.5 MTRS	ELECTRICAL CONTRACTOR	ELECTRICAL CONTRACTOR
9	EDGE PROTECTION FOR CABLE			RUBBER	1 NO.	ELECTRICAL CONTRACTOR	ELECTRICAL CONTRACTOR

DETAIL-1

DETAIL-2

DRAWING NOT TO SCALE

NOTES:-

- 1) ALL DIMENSION ARE IN 'mm' UNLESS OTHERWISE SPECIFIED.
- 2) THE SUPPORT SHALL BE PREFABRICATED AND PAINTED BEFORE INSTALLATION.
- 3) THE DETAILS (SIZE AND DIMENSIONS) SHALL BE VERIFIED WITH ORDERED LIGHTING FIXTURE.
- 4) SUPPLY & INSTALLATION OF STEEL IS NOT PART OF THIS INSTALLATION ARRANGEMENT. SAME IS COVERED ELSEWHERE.
- 5) THE DETAILS (SIZE AND DIMENSIONS) SHALL BE VERIFIED WITH NB 50 & NB 80 PIPE.

Code		Contract No.		Document ID		Part		Rev.	
				PIN-LEP-ELT-4003				00	
00	01/08/16	RDK	ANK	01/08/16	RPM	01/08/16	RPM	ISSUED AS STANDARD	
Rev.	Date	Name		Date	Name	Date	Name	Description	Acc. Code
		Drawn/Prepared			Checked		Approved		

BAR-Code

Store Location: Server/Share

Store Location: Folder

Store Name LFLR1

Pro. Unit TON Group Type of Document Sheet 1 / 1

Con. Unit Scale Order No. thyssenkrupp

NTS

	Date	Name	Description INSTALLATION STANDARDS – LIGHTING FLUORESCENT/LED LIGHTING FIXTURE ON POLE, ON STRUCTURAL STEEL RAILING (LFLR1)
Drawn	01/08/16	RDK	
Prepared	01/08/16	ANK	
Checked	01/08/16	RPM	
Approved	01/08/16	RPM	

ITEM	DESCRIPTION	MATERIAL	QTY.	SUPPLY BY	INSTALLATION BY
1	FLUORESCENT / LED LIGHTING FIXTURE	-	1 NO.	CLIENT	ELECTRICAL CONTRACTOR
2	ISMC 75	M.S. PAINTED	AS REQUIRED	REFER NOTE-3 & 4	
3	HEXAGONAL HEAD BOLT M10 X 30mm LONG, THREADS UPTO HEAD, WITH NUTS & WASHERS SUITABLE FOR CONNECTIONS SHOWN IN THIS DRAWING (REFER NOTE-3)	H.D.G.I.	2 SETS	ELECTRICAL CONTRACTOR	ELECTRICAL CONTRACTOR

DRAWING NOT TO SCALE

NOTES:-

- 1) ALL DIMENSION ARE IN 'mm' UNLESS OTHERWISE SPECIFIED.
- 2) THE SUPPORT SHALL BE PREFABRICATED AND PAINTED BEFORE INSTALLATION. AREA AFFECTED DUE TO SITE WELDING SHALL BE CLEANED & PAINTED
- 3) THE DETAILS (SIZE AND DIMENSIONS) SHALL BE VERIFIED WITH ORDERED LIGHTING FIXTURE.
- 4) SUPPLY & INSTALLATION OF STEEL IS NOT PART OF THIS INSTALLATION ARRANGEMENT. SAME IS COVERED ELSEWHERE.

Code		Contract No.		Document ID		Part		Rev.	
00	01/08/16	RDK	ANK	01/08/16	RPM	01/08/16	RPM	PIN-LEP-ELT-4003	
Rev.	Date	Name		Date	Name	Date	Name	Cat. Code	Acc. Code
		Drawn/Prepared			Checked		Approved		
Description							Acc. Code		Status
BAR-Code							Store Location: Server/Share		
							Store Location: Folder		
							Store Name LFLS1		
Pro. Unit		TON		Group		Type of Document		Sheet 1 / 1	
Con. Unit		Scale		Order No.					
		NTS							

	Date	Name
Drawn	01/08/16	RDK
Prepared	01/08/16	ANK
Checked	01/08/16	RPM
Approved	01/08/16	RPM

Description
 INSTALLATION STANDARDS – LIGHTING
 FLUORESCENT/LED LIGHTING FIXTURE
 MOUNTED UNDER STEEL CEILING
 (LFLS1)

1	2	3	4
ITEM	DESCRIPTION	MATERIAL	QTY.
1	FLUORESCENT / LED LIGHTING FIXTURE	—	1 NO.
2	ISMC 75	M.S. PAINTED	AS REQUIRED
3	HEXAGONAL HEAD BOLT M10 X 30mm LONG, THREADS UPTO HEAD, WITH NUTS & WASHERS SUITABLE FOR CONNECTIONS SHOWN IN THIS DRAWING	H.D.G.I.	2 SETS
4	HEXAGONAL HEAD BOLT M10 X 30mm LONG, THREADS UPTO HEAD, WITH NUTS & WASHERS SUITABLE FOR ORDERED LIGHTING FIXTURE (REFER NOTE-3)	H.D.G.I.	2 SETS
5	ISMC 75	M.S. PAINTED	AS REQUIRED

A

B

C

STEEL CEILING

WELD (TYP)

L
(REFER NOTE 4 & 5)

1

D

DRAWING NOT TO SCALE

NOTES:-

- ALL DIMENSION ARE IN 'mm' UNLESS OTHERWISE SPECIFIED.
- THE SUPPORT SHALL BE PREFABRICATED AND PAINTED BEFORE INSTALLATION. AREA AFFECTED DUE TO SITE WELDING SHALL BE CLEANED & PAINTED
- THE DETAILS (SIZE AND DIMENSIONS) SHALL BE VERIFIED WITH ORDERED LIGHTING FIXTURE.
- SUPPLY & INSTALLATION OF STEEL IS NOT PART OF THIS INSTALLATION ARRANGEMENT. SAME IS COVERED ELSEWHERE.
- LENGTH OF ITEM 5 SHALL BE DECIDED WITH RESPECT TO LAYOUT DRAWING OR WITH CONSULTATION OF SITE ENGINEER. LENGTH SHALL BE RESTRICTED TO MAXIMUM 3 METERS.

Code		Contract No.		Document ID		Part		Rev.	
00	01/08/16	RDK	ANK	01/08/16	RPM	01/08/16	RPM	PIN-LEP-ELT-4003	00
Rev.	Date	Name		Date	Name	Date	Name	ISSUED AS STANDARD	
		Drawn/Prepared			Checked		Approved	Description	Acc. Code
BAR-Code								Store Location: Server/Share	
								Store Location: Folder	
								Store Name LFLS2	
Pro. Unit		TON		Group		Type of Document		Sheet 1 / 1	
Con. Unit		Scale		Order No.				NTS	

	Date	Name
Drawn	01/08/16	RDK
Prepared	01/08/16	ANK
Checked	01/08/16	RPM
Approved	01/08/16	RPM

E

DESCRIPTION

INSTALLATION STANDARDS – LIGHTING FLUORESCENT/LED LIGHTING FIXTURE SUSPENDED FROM STEEL CEILING (LFLS2)

F

ISO A4

DESCRIPTION

INSTALLATION STANDARDS – LIGHTING FLUORESCENT/LED LIGHTING FIXTURE SUSPENDED FROM STEEL CEILING (LFLS2)

G

1	2	3	4
ITEM	DESCRIPTION	MATERIAL	QTY.
1	FLUORESCENT/LED LIGHT LUMINAIRE	—	1 NO.
2	PREFABRICATED NB 50 (MEDIUM CLASS) PIPE (REFER NOTE-5)	H.D.G.I.	2 METERS
3	PIPE CLAMP FOR NB 50 PIPE WITH M6x20 HEXAGONAL BOLT, NUTS & WASHERS	H.D.G.I.	2 SETS
4	ISMC 75	M.S. PAINTED	AS REQUIRED
5	U BOLT M10 SIZE THREADED AT THE END SUITABLE FOR NB 50 PIPE WITH NUT AND WASHERS	H.D.G.I.	2 SETS
6	HEXAGONAL HEAD BOLT M10 X 30mm LONG, THREADS UPTO HEAD, WITH NUTS & WASHERS SUITABLE FOR ORDERED LIGHTING FIXTURE (REFER NOTE-3)	H.D.G.I.	2 SETS
7	EDGE PROTECTION FOR CABLE	RUBBER	1 NO.

DETAIL-1

DETAIL-2

DRAWING NOT TO SCALE

NOTES:-

- 1) ALL DIMENSION ARE IN 'mm' UNLESS OTHERWISE SPECIFIED.
- 2) THE SUPPORT SHALL BE PREFABRICATED AND PAINTED BEFORE INSTALLATION. AREA AFFECTED DUE TO SITE WELDING SHALL BE CLEANED AND PAINTED.
- 3) THE DETAILS (SIZE AND DIMENSIONS) SHALL BE VERIFIED WITH ORDERED LIGHTING FIXTURE.
- 4) SUPPLY & INSTALLATION OF STEEL IS NOT PART OF THIS INSTALLATION ARRANGEMENT. SAME IS COVERED ELSEWHERE.
- 5) THE DETAILS (SIZE AND DIMENSIONS) SHALL BE VERIFIED WITH NB 50 & NB 80 PIPE.

Code		Contract No.		Document ID		Part		Rev.	
00	01/08/16	RDK	ANK	01/08/16	RPM	01/08/16	RPM	PIN-LEP-ELT-4003	
Rev.	Date	Name	Date	Name	Date	Name	ISSUED AS STANDARD		
Rev.	Date	Name	Date	Name	Date	Name	Cat. Code	Acc. Code	Status

BAR-Code

Store Location: Server/Share

Store Location: Folder

Store Name LFLS3

Pro. Unit TON Group Type of Document Sheet 1 / 1

Con. Unit Scale Order No.

NTS

thysenkrupp

	Date	Name
Drawn	01/08/16	RDK
Prepared	01/08/16	ANK
Checked	01/08/16	RPM
Approved	01/08/16	RPM

DESCRIPTION

INSTALLATION STANDARDS – LIGHTING FLUORESCENT/LED LIGHTING FIXTURE ON POLE, BRACKET ON STEEL COLUMN (LFLS3)

1		2		3		4		
ITEM	DESCRIPTION				MATERIAL	QTY.	SUPPLY BY	INSTALLATION BY
1	FLUORESCENT / LED LIGHTING FIXTURE				-	1 NO.	CLIENT	ELECTRICAL CONTRACTOR
2	MUSHROOM HEAD BOLT M10 X 30mm LONG, THREADS UPTO HEAD, WITH NUTS & WASHERS SUITABLE FOR CONNECTIONS SHOWN IN THIS DRAWING (REFER NOTE-2)				H.D.G.I.	2 SETS	ELECTRICAL CONTRACTOR	ELECTRICAL CONTRACTOR

PERFORATED CABLE TRAY
(NOT PART OF THIS
INSTALLATION ARRANGEMENT)

VIEW-A

VIEW-A

DRAWING NOT TO SCALE

NOTES:-

- 1) ALL DIMENSION ARE IN 'mm' UNLESS OTHERWISE SPECIFIED.
- 2) THE DETAILS (SIZE AND DIMENSIONS) SHALL BE VERIFIED WITH ORDERED LIGHTING FIXTURE.

Code		Contract No.		Document ID		Part		Rev.	
00	01/08/16	RDK	ANK	01/08/16	RPM	01/08/16	RPM	PIN-LEP-ELT-4003	
Rev.	Date	Name	Date	Name	Date	Name	Description	Acc. Code	Status
		Drawn/Prepared		Checked		Approved			

Store Location: Server/Share		Store Location: Folder		Store Name		Pro. Unit		Group		Type of Document		Sheet	
				LFLT1		TON						1 / 1	
Con. Unit		Scale		Order No.									
		NTS											

	Date	Name	Description
Drawn	01/08/16	RDK	INSTALLATION STANDARDS - LIGHTING LED/FLUORESCENT LIGHTING FIXTURE SUPPORTED FROM CABLE TRAY (LFLT1)
Prepared	01/08/16	ANK	
Checked	01/08/16	RPM	
Approved	01/08/16	RPM	

ITEM	DESCRIPTION	MATERIAL	QTY.	SUPPLY BY	INSTALLATION BY
1	HIGH/MEDIUM/LOW BAY LIGHTING FIXTURE	—	1 NO.	CLIENT	ELECTRICAL CONTRACTOR
2	ISMC 75	M.S. PAINTED	AS REQUIRED	REFER NOTE-3 & 4	
3	BRACKET AS INDICATED IN DETAIL-2 MADE OF 40 x 6mm FLAT STRIP (REFER NOTE-6)	H.D.G.I.	1 NO.	ELECTRICAL CONTRACTOR	ELECTRICAL CONTRACTOR
4	HEXAGONAL HEAD BOLT M10 X 30mm LONG, THREADS UPTO HEAD, WITH NUTS & WASHERS SUITABLE FOR CONNECTIONS SHOWN IN THIS DRAWING	H.D.G.I.	2 SETS	ELECTRICAL CONTRACTOR	ELECTRICAL CONTRACTOR
5	HEXAGONAL HEAD BOLT M12 X 30mm LONG, THREADS UPTO HEAD, WITH NUTS & WASHERS SUITABLE FOR CONNECTIONS SHOWN IN THIS DRAWING	H.D.G.I.	2 SETS	ELECTRICAL CONTRACTOR	ELECTRICAL CONTRACTOR
6	M8 x 60mm LONG ANCHOR FASTENER, WITH SUITABLE NUT & WASHERS	GALVANISED STEEL/SS	2 SETS	ELECTRICAL CONTRACTOR	ELECTRICAL CONTRACTOR
7	HEXAGONAL HEAD BOLT M12 X 30mm LONG, THREADS UPTO HEAD, WITH NUTS & WASHERS SUITABLE FOR ORDERED LIGHTING FIXTURE (REFER NOTE-7)	H.D.G.I.	1 SET	ELECTRICAL CONTRACTOR	ELECTRICAL CONTRACTOR
8	ISMC 75	M.S. PAINTED	AS REQUIRED	REFER NOTE-4 & 5	

FRONT VIEW

DETAIL-1
(PLAN VIEW)

DETAIL-2

DRAWING NOT TO SCALE

NOTES:-

- 1) ALL DIMENSION ARE IN 'mm' UNLESS OTHERWISE SPECIFIED.
- 2) THE SUPPORT SHALL BE PREFABRICATED AND PAINTED BEFORE INSTALLATION.
- 3) THE DETAILS (SIZE AND DIMENSIONS) SHALL BE VERIFIED WITH ORDERED LIGHTING FIXTURE.
- 4) SUPPLY & INSTALLATION OF STEEL IS NOT PART OF THIS INSTALLATION ARRANGEMENT. SAME IS COVERED ELSEWHERE.
- 5) LENGTH OF ITEM 8 SHALL BE DECIDED WITH RESPECT TO LAYOUT DRAWING OR WITH CONSULTATION OF SITE ENGINEER. LENGTH SHALL BE RESTRICTED TO MAXIMUM 3 METERS.
- 6) THE DIMENSIONS FOR ITEM-3 AND DETAILS OF HOLES (LOCATION & DIA) SHALL BE VERIFIED WITH THE ORDERED LIGHTING FIXTURE.
- 7) THE QUANTITY & SIZE OF THE HEXAGONAL HEAD BOLT (ITEM-7) REQUIRED FOR CONNECTION OF ITEM-3 TO THE LIGHTING FIXTURE SHALL BE VERIFIED WITH THE ORDERED LIGHTING FIXTURE.

Code		Contract No.		Document ID		Part		Rev.	
00	01/08/16	RDK	ANK	01/08/16	RPM	01/08/16	RPM	PIN-LEP-ELT-4003	
Rev.	Date	Name	Date	Name	Date	Name	Description	Acc. Code	Status
		Drawn/Prepared		Checked		Approved			

Store Location: Server/Share		Store Location: Folder		Store Name		Pro. Unit		Group		Type of Document		Sheet	
				LHBC1		TON						1 / 1	
Con. Unit		Scale		Order No.									
		NTS											

Date	Name	Description
01/08/16	RDK	INSTALLED STANDARDS - LIGHTING
01/08/16	ANK	HIGH/MEDIUM/LOW BAY FIXTURE ON
01/08/16	RPM	BRACKET, ON CONCRETE CEILING
01/08/16	RPM	(LHBC1)

1	2	3	4	5	6
ITEM	DESCRIPTION	MATERIAL	QTY.	SUPPLY BY	INSTALLATION BY
1	HIGH/MEDIUM/LOW BAY LIGHTING FIXTURE	—	1 NO.	CLIENT	ELECTRICAL CONTRACTOR
2	ISMC 75	M.S. PAINTED	AS REQUIRED	REFER NOTE-3 & 4	
3	BRACKET AS INDICATED IN DETAIL-2 MADE OF 40 x 6mm FLAT STRIP (REFER NOTE-6)	H.D.G.I.	1 NO.	ELECTRICAL CONTRACTOR	ELECTRICAL CONTRACTOR
4	HEXAGONAL HEAD BOLT M10 X 30mm LONG, THREADS UPTO HEAD, WITH NUTS & WASHERS SUITABLE FOR CONNECTIONS SHOWN IN THIS DRAWING	H.D.G.I.	2 SETS	ELECTRICAL CONTRACTOR	ELECTRICAL CONTRACTOR
5	HEXAGONAL HEAD BOLT M12 X 30mm LONG, THREADS UPTO HEAD, WITH NUTS & WASHERS SUITABLE FOR CONNECTIONS SHOWN IN THIS DRAWING	H.D.G.I.	2 SETS	ELECTRICAL CONTRACTOR	ELECTRICAL CONTRACTOR
6	HEXAGONAL HEAD BOLT M12 X 30mm LONG, THREADS UPTO HEAD, WITH NUTS & WASHERS SUITABLE FOR ORDERED LIGHTING FIXTURE (REFER NOTE-7)	H.D.G.I.	1 SET	ELECTRICAL CONTRACTOR	ELECTRICAL CONTRACTOR
7	ISMC 75	M.S. PAINTED	AS REQUIRED	REFER NOTE-4 & 5	

FRONT VIEW

DETAIL-1
(PLAN VIEW)

PLAN : DETAIL-2

DETAIL-2

DRAWING NOT TO SCALE

NOTES:-

- 1) ALL DIMENSION ARE IN 'mm' UNLESS OTHERWISE SPECIFIED.
- 2) THE SUPPORT SHALL BE PREFABRICATED AND PAINTED BEFORE INSTALLATION. AREA AFFECTED DUE TO SITE WELDING SHALL BE CLEANED & PAINTED
- 3) THE DETAILS (SIZE AND DIMENSIONS) SHALL BE VERIFIED WITH ORDERED LIGHTING FIXTURE.
- 4) SUPPLY & INSTALLATION OF STEEL IS NOT PART OF THIS INSTALLATION ARRANGEMENT. SAME IS COVERED ELSEWHERE.
- 5) LENGTH OF ITEM 7 SHALL BE DECIDED WITH RESPECT TO LAYOUT DRAWING OR WITH CONSULTATION OF SITE ENGINEER. LENGTH SHALL BE RESTRICTED TO MAXIMUM 3 METERS.
- 6) THE DIMENSIONS FOR ITEM-3 AND DETAILS OF HOLES (LOCATION & DIA) SHALL BE VERIFIED WITH THE ORDERED LIGHTING FIXTURE.
- 7) THE QUANTITY & SIZE OF THE HEXAGONAL HEAD BOLT (ITEM-6) REQUIRED FOR CONNECTION OF ITEM-3 TO THE LIGHTING FIXTURE SHALL BE VERIFIED WITH THE ORDERED LIGHTING FIXTURE.

Code		Contract No.		Document ID		Part		Rev.																
				PIN-LEP-ELT-4003				00																
00	01/08/16	RDK	ANK	01/08/16	RPM	01/08/16	RPM	ISSUED AS STANDARD																
Rev.	Date	Name		Date	Name	Date	Name	Description	Acc. Code															
		Drawn/Prepared			Checked		Approved																	
BAR-Code								Store Location: Server/Share																
								Store Location: Folder																
								Store Name LHBS1																
Pro. Unit		TON		Group		Type of Document		Sheet 1 / 1																
Con. Unit		Scale		Order No.																				
		NTS																						
<table border="1" style="width: 100%; border-collapse: collapse;"> <thead> <tr> <th></th> <th>Date</th> <th>Name</th> </tr> </thead> <tbody> <tr> <td>Drawn</td> <td>01/08/16</td> <td>RDK</td> </tr> <tr> <td>Prepared</td> <td>01/08/16</td> <td>ANK</td> </tr> <tr> <td>Checked</td> <td>01/08/16</td> <td>RPM</td> </tr> <tr> <td>Approved</td> <td>01/08/16</td> <td>RPM</td> </tr> </tbody> </table>									Date	Name	Drawn	01/08/16	RDK	Prepared	01/08/16	ANK	Checked	01/08/16	RPM	Approved	01/08/16	RPM	Description INSTALLATION STANDARDS – LIGHTING HIGH/MEDIUM/LOW BAY FIXTURE ON BRACKET, ON STRUCTURAL STEEL BEAM (LHBS1)	
	Date	Name																						
Drawn	01/08/16	RDK																						
Prepared	01/08/16	ANK																						
Checked	01/08/16	RPM																						
Approved	01/08/16	RPM																						

1	2	3	4	5	6
ITEM	DESCRIPTION	MATERIAL	QTY.	SUPPLY BY	INSTALLATION BY
1	STREET LIGHTING FIXTURE	—	1 NO.	CLIENT	ELECTRICAL CONTRACTOR
4	ISMC 75	M.S. PAINTED	AS REQUIRED	REFER NOTE-3 & 4	
3	U BOLT M10 SIZE THREADED AT THE END SUITABLE FOR PIPE OF STREET LIGHTING FIXTURE (REFER NOTE-5)	H.D.G.I.	2 SETS	ELECTRICAL CONTRACTOR	ELECTRICAL CONTRACTOR
4	ADAPTER OR REDUCER TO SUIT LIGHTING FIXTURE	H.D.G.I.	1 NO.	ELECTRICAL CONTRACTOR	ELECTRICAL CONTRACTOR
5	M8 x 60mm LONG ANCHOR FASTENER, WITH SUITABLE NUT & WASHERS	GALVANISED STEEL/SS	4 SETS	ELECTRICAL CONTRACTOR	ELECTRICAL CONTRACTOR

1000

20°

800 RADIUS

REFER DETAIL-1

500

250

DETAIL-1

DRAWING NOT TO SCALE

NOTES:-

- 1) ALL DIMENSION ARE IN 'mm' UNLESS OTHERWISE SPECIFIED.
- 2) THE SUPPORT SHALL BE PREFABRICATED AND PAINTED BEFORE INSTALLATION.
- 3) THE DETAILS (SIZE AND DIMENSIONS) SHALL BE VERIFIED WITH ORDERED LIGHTING FIXTURE.
- 4) SUPPLY & INSTALLATION OF STEEL IS NOT PART OF THIS INSTALLATION ARRANGEMENT. SAME IS COVERED ELSEWHERE.
- 5) THE DETAILS (SIZE AND DIMENSIONS) SHALL BE VERIFIED PIPE OF STREET LIGHTING FIXTURE.

Code		Contract No.		Document ID		Part		Rev.	
				PIN-LEP-ELT-4003				00	
00	01/08/16	RDk	ANK	01/08/16	RPM	01/08/16	RPM	ISSUED AS STANDARD	
Rev.	Date	Name		Date	Name	Date	Name	Description	Acc. Code
		Drawn/Prepared			Checked		Approved		

BAR-Code		Store Location: Server/Share	
		Store Location: Folder	
		Store Name LSTC1	
Pro. Unit	TON	Group	Type of Document
Con. Unit	Scale	Order No.	
		NTS	

Date	Name	Description
Drawn	01/08/16 RDk	INSTALLATION STANDARDS – LIGHTING STREET LIGHTING FIXTURE ON WALL/COLUMN (LSTC1)
Prepared	01/08/16 ANK	
Checked	01/08/16 RPM	
Approved	01/08/16 RPM	

1		2		3		4	
ITEM	DESCRIPTION			MATERIAL	QTY.	SUPPLY BY	INSTALLATION BY
1	STREET LIGHTING FIXTURE			-	1 NO.	CLIENT	ELECTRICAL CONTRACTOR
2	STREET LIGHTING POLE			STEEL OF MIN TENSILE STRENGTH 410MPa	1 NO.	ELECTRICAL CONTRACTOR	ELECTRICAL CONTRACTOR
3	JUNCTION BOX			H.D.G.I.	1 NO.	ELECTRICAL CONTRACTOR	ELECTRICAL CONTRACTOR
4	ISA 50 (50X50X6mm)			MS PAINTED	AS REQUIRED	REFER NOTE-4	
5	25 x 3mm FLAT STEEL STRIP BENT AS INDICATED IN DETAIL-A WITH 2 NOS.			MS PAINTED	AS REQUIRED	REFER NOTE-4	
6	25mm ϕ 750mm LONG EARTH ROD (FOR EARTHING)			H.D.G.I.	1 NO.	ELECTRICAL CONTRACTOR	ELECTRICAL CONTRACTOR
7	75mm ϕ PIPE SLEEVE WITH R=800 (L=AS REQD.)			H.D.G.I.	2 NOS.	ELECTRICAL CONTRACTOR	ELECTRICAL CONTRACTOR
8	EARTHING CONDR. WITH LUG AND FIXING HARDWARE. SIZE, OF EARTHING CONDR. & MATERIAL SHALL BE AS PER THE 'EARTHING SCHEDULE' FOR THE PROJECT.			-	AS REQUIRED	ELECTRICAL CONTRACTOR	ELECTRICAL CONTRACTOR
9	CONCRETE MATERIAL AS INDICATED FOR BASE & SQUARE SHAPE FOUNDATION, BITUMEN & MISCELLANEOUS MATERIAL AS REQUIRED			-	1 LOT	ELECTRICAL CONTRACTOR	ELECTRICAL CONTRACTOR

STEEL TUBULAR POLE
410 SP-8
AS PER IS:2713

800 RADIUS

20°

1000

1500

AS REQD.

88.9 x 3.25 THICK

114.3 x 3.65 THICK

139.7 x 4.85 THICK

REFER DETAIL-A

GL

1200

150

REF VIEW-X

DRAWING NOT TO SCALE

NIPPLE ARRANGEMENT FOR CABLE ENTRY

PLAN : DETAIL-A

VIEW-X

NOTES:-

- 1) ALL DIMENSION ARE IN 'mm' UNLESS OTHERWISE SPECIFIED.
- 2) THE SUPPORT SHALL BE PREFABRICATED AND PAINTED BEFORE INSTALLATION.
- 3) REQUIRED CIVIL WORK AS SHOWN IN DRAWING SHALL BE IN ELECTRICAL CONTRACTORS SCOPE
- 4) SUPPLY & INSTALLATION OF STEEL IS NOT PART OF THIS INSTALLATION ARRANGEMENT. SAME IS COVERED ELSEWHERE.

Code		Contract No.		Document ID		Part		Rev.	
00	12/02/16	RDK	ANK	12/02/16	RPM	12/02/16	RPM	ISSUED AS STANDARD	00
Rev.	Date	Name	Date	Name	Date	Name	Description	Acc. Code	Status
BAR-Code							Store Location: Server/Share		
							Store Location: Folder		
							Store Name		
							LSTP1		
Pro. Unit		TON		Group		Type of Document		Sheet	
								1 / 1	
Con. Unit		Scale		Order No.					
		NTS							

Date	Name	Description
12/02/16	RDK	INSTALLATION STANDARDS - LIGHTING
12/02/16	ANK	STREET LIGHTING FIXTURE
12/02/16	RPM	ON STREET LIGHT POLE
12/02/16	RPM	(LSTP1)

ITEM	DESCRIPTION	MATERIAL	QTY.	SUPPLY BY	INSTALLATION BY
1	STREET LIGHTING FIXTURE	—	1 NO.	CLIENT	ELECTRICAL CONTRACTOR
4	ISMC 75	M.S. PAINTED	AS REQUIRED	REFER NOTE-3 & 4	
3	U BOLT M10 SIZE THREADED AT THE END SUITABLE FOR PIPE OF STREET LIGHTING FIXTURE (REFER NOTE-5)	H.D.G.I.	2 SETS	ELECTRICAL CONTRACTOR	ELECTRICAL CONTRACTOR
4	ADAPTER OR REDUCER TO SUIT LIGHTING FIXTURE	H.D.G.I.	1 NO.	ELECTRICAL CONTRACTOR	ELECTRICAL CONTRACTOR

DETAIL-1

DRAWING NOT TO SCALE

NOTES:-

- 1) ALL DIMENSION ARE IN 'mm' UNLESS OTHERWISE SPECIFIED.
- 2) THE SUPPORT SHALL BE PREFABRICATED AND PAINTED BEFORE INSTALLATION. AREA AFFECTED DUE TO SITE WELDING SHALL BE CLEANED AND PAINTED.
- 3) THE DETAILS (SIZE AND DIMENSIONS) SHALL BE VERIFIED WITH ORDERED LIGHTING FIXTURE.
- 4) SUPPLY & INSTALLATION OF STEEL IS NOT PART OF THIS INSTALLATION ARRANGEMENT. SAME IS COVERED ELSEWHERE.
- 5) THE DETAILS (SIZE AND DIMENSIONS) SHALL BE VERIFIED PIPE OF STREET LIGHTING FIXTURE.

Code		Contract No.		Document ID		Part		Rev.	
				PIN-LEP-ELT-4003				00	
00	01/08/16	RDK	ANK	01/08/16	RPM	01/08/16	RPM	ISSUED AS STANDARD	
Rev.	Date	Name		Date	Name	Date	Name	Description	Acc. Code
		Drawn/Prepared			Checked		Approved		

BAR-Code		Store Location: Server/Share	
		Store Location: Folder	
		Store Name LSTS1	
Pro. Unit	TON	Group	Type of Document
Con. Unit	Scale	Order No.	Sheet 1 / 1
NTS			

	Date	Name	Description
Drawn	01/08/16	RDK	INSTALLATION STANDARDS – LIGHTING STREET LIGHTING FIXTURE ON STRUCTURAL STEEL COLUMN (LSTS1)
Prepared	01/08/16	ANK	
Checked	01/08/16	RPM	
Approved	01/08/16	RPM	

1		2		3		4	
ITEM	DESCRIPTION			MATERIAL	QTY.	SUPPLY BY	INSTALLATION BY
1	WELL GLASS LIGHTING FIXTURE			-	1 NO.	CLIENT	ELECTRICAL CONTRACTOR
2	ISMC 75			M.S. PAINTED	AS REQUIRED	REFER NOTE-3 & 4	
3	BRACKET AS INDICATED IN DETAIL-1 MADE OF 40 x 6mm FLAT STRIP (REFER NOTE-5)			H.D.G.I.	1 NO.	ELECTRICAL CONTRACTOR	ELECTRICAL CONTRACTOR
4	HEXAGONAL HEAD BOLT M10 X 30mm LONG, THREADS UPTO HEAD, WITH NUTS & WASHERS SUITABLE FOR CONNECTIONS SHOWN IN THIS DRAWING			H.D.G.I.	2 SETS	ELECTRICAL CONTRACTOR	ELECTRICAL CONTRACTOR
5	HEXAGONAL HEAD BOLT M12 X 30mm LONG, THREADS UPTO HEAD, WITH NUTS & WASHERS SUITABLE FOR ORDERED LIGHTING FIXTURE (REFER NOTE-6)			H.D.G.I.	1 SET	ELECTRICAL CONTRACTOR	ELECTRICAL CONTRACTOR
6	150 x 150 X 10mm THK PLATE			M.S. PAINTED	1 NO.	REFER NOTE-4	
7	M8 x 60mm LONG ANCHOR FASTENER, WITH SUITABLE NUT & WASHERS			GALVANISED STEEL/SS	2 SETS	ELECTRICAL CONTRACTOR	ELECTRICAL CONTRACTOR

SIDE VIEW

PLAN : DETAIL-1

VIEW-A

DRAWING NOT TO SCALE


NOTES:-

- 1) ALL DIMENSION ARE IN 'mm' UNLESS OTHERWISE SPECIFIED.
- 2) THE SUPPORT SHALL BE PREFABRICATED AND PAINTED BEFORE INSTALLATION. AREA AFFECTED DUE TO SITE WELDING SHALL BE CLEANED & PAINTED
- 3) THE DETAILS (SIZE AND DIMENSIONS) SHALL BE VERIFIED WITH ORDERED LIGHTING FIXTURE.
- 4) SUPPLY & INSTALLATION OF STEEL IS NOT PART OF THIS INSTALLATION ARRANGEMENT. SAME IS COVERED ELSEWHERE.
- 5) THE DIMENSIONS FOR ITEM-3 AND DETAILS OF HOLES (LOCATION & DIA) SHALL BE VERIFIED WITH THE ORDERED LIGHTING FIXTURE.
- 6) THE QUANTITY & SIZE OF THE HEXAGONAL HEAD BOLT (ITEM-5) REQUIRED FOR CONNECTION OF ITEM-3 TO THE LIGHTING FIXTURE SHALL BE VERIFIED WITH THE ORDERED LIGHTING FIXTURE.

Code		Contract No.		Document ID		Part		Rev.	
00	12/02/16	RDK	ANK	12/02/16	RPM	12/02/16	RPM	ISSUED AS STANDARD	00
Rev.	Date	Name	Date	Name	Date	Name	Description	Acc. Code	Status
BAR-Code							Store Location: Server/Share		
							Store Location: Folder		
							Store Name LWGC1		
Pro. Unit		TON		Group		Type of Document		Sheet 1 / 1	
Con. Unit		Scale		Order No.					
							NTS		
							Description INSTALLATION STANDARDS - LIGHTING WELL GLASS FIXTURE ON BRACKET, ON CONCRETE WALL/COLUMN (LWGC1)		

	Date	Name
Drawn	12/02/16	RDK
Prepared	12/02/16	ANK
Checked	12/02/16	RPM
Approved	12/02/16	RPM

ITEM	DESCRIPTION	MATERIAL	QTY.	SUPPLY BY	INSTALLATION BY
1	WELL GLASS LIGHTING FIXTURE	—	1 NO.	CLIENT	ELECTRICAL CONTRACTOR
2	BRACKET AS INDICATED IN DETAIL-1 MADE OF 40 x 6mm FLAT STRIP (REFER NOTE-4)	H.D.G.I.	1 NO.	ELECTRICAL CONTRACTOR	ELECTRICAL CONTRACTOR
3	M8 x 60mm LONG ANCHOR FASTENER, WITH SUITABLE NUT & WASHERS	GALVANISED STEEL/SS	2 SETS	ELECTRICAL CONTRACTOR	ELECTRICAL CONTRACTOR
4	HEXAGONAL HEAD BOLT M12 X 30mm LONG, THREADS UPTO HEAD, WITH NUTS & WASHERS SUITABLE FOR ORDERED LIGHTING FIXTURE (REFER NOTE-5)	H.D.G.I.	1 SET	ELECTRICAL CONTRACTOR	ELECTRICAL CONTRACTOR

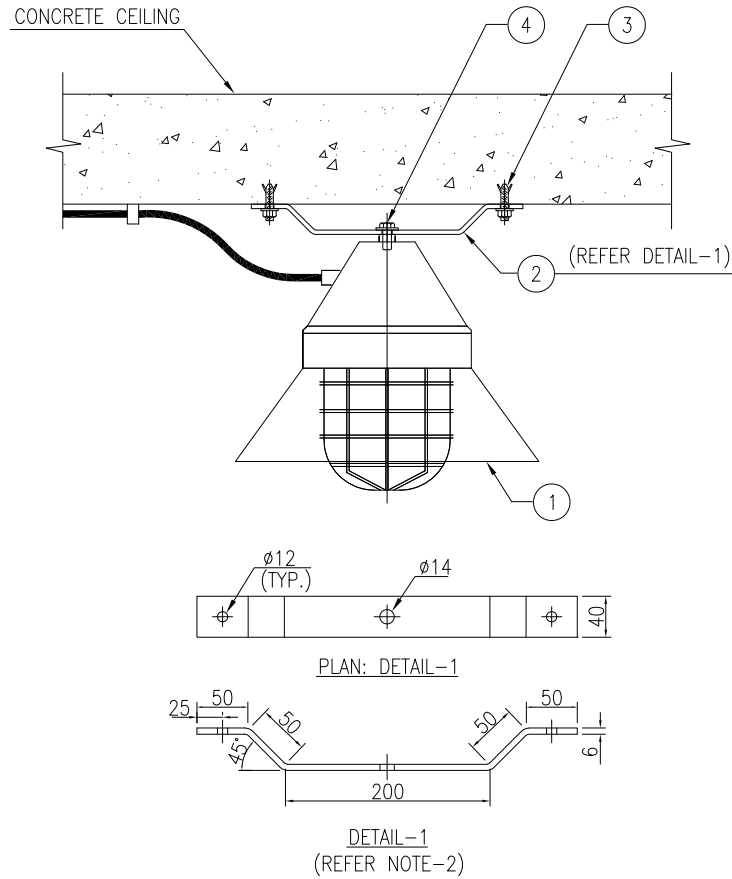

DRAWING NOT TO SCALE

NOTES:-

- 1) ALL DIMENSION ARE IN 'mm' UNLESS OTHERWISE SPECIFIED.
- 2) THE SUPPORT SHALL BE PREFABRICATED AND PAINTED BEFORE INSTALLATION.
- 3) THE DETAILS (SIZE AND DIMENSIONS) SHALL BE VERIFIED WITH ORDERED LIGHTING FIXTURE.
- 4) THE DIMENSIONS FOR ITEM-2 AND DETAILS OF HOLES (LOCATION & DIA) SHALL BE VERIFIED WITH THE ORDERED LIGHTING FIXTURE.
- 5) THE QUANTITY & SIZE OF THE HEXAGONAL HEAD BOLT (ITEM-4) REQUIRED FOR CONNECTION OF ITEM-2 TO THE LIGHTING FIXTURE SHALL BE VERIFIED WITH THE ORDERED LIGHTING FIXTURE.

Code		Contract No.		Document ID		Part		Rev.	
00		12/02/16 RDK ANK		12/02/16 RPM		PIN-LEP-ELT-4003		00	
Rev.	Date	Name	Date	Name	Date	Name	ISSUED AS STANDARD	Cat. Code	Acc. Code
00	12/02/16	RDK	12/02/16	RPM	12/02/16	RPM	ISSUED AS STANDARD		
BAR-Code							Store Location: Server/Share		
							Store Location: Folder		
							Store Name		
							LWGC2		
Pro. Unit		TON		Group		Type of Document		Sheet	
								1 / 1	
Con. Unit		Scale		Order No.					
		NTS							
Date		Name		Description					
12/02/16		RDK		INSTALLATION STANDARDS - LIGHTING					
12/02/16		ANK		WELL GLASS FIXTURE ON BRACKET,					
12/02/16		RPM		ON CONCRETE CEILING					
12/02/16		RPM		(LWGC2)					

1		2		3		4	
ITEM	DESCRIPTION			MATERIAL	QTY.	SUPPLY BY	INSTALLATION BY
1	WELL GLASS LIGHTING FIXTURE			-	1 NO.	CLIENT	ELECTRICAL CONTRACTOR
2	ISMC 75			M.S. PAINTED	AS REQUIRED	REFER NOTE-3 & 4	
3	BRACKET AS INDICATED IN DETAIL-2 MADE OF 40 x 6mm FLAT STRIP (REFER NOTE-6)			H.D.G.I.	1 NO.	ELECTRICAL CONTRACTOR	ELECTRICAL CONTRACTOR
4	HEXAGONAL HEAD BOLT M10 X 30mm LONG, THREADS UPTO HEAD, WITH NUTS & WASHERS SUITABLE FOR CONNECTIONS SHOWN IN THIS DRAWING			H.D.G.I.	2 SETS	ELECTRICAL CONTRACTOR	ELECTRICAL CONTRACTOR
5	HEXAGONAL HEAD BOLT M12 X 30mm LONG, THREADS UPTO HEAD, WITH NUTS & WASHERS SUITABLE FOR CONNECTIONS SHOWN IN THIS DRAWING			H.D.G.I.	2 SETS	ELECTRICAL CONTRACTOR	ELECTRICAL CONTRACTOR
6	M8 x 60mm LONG ANCHOR FASTENER, WITH SUITABLE NUT & WASHERS			GALVANISED STEEL/SS	2 SETS	ELECTRICAL CONTRACTOR	ELECTRICAL CONTRACTOR
7	HEXAGONAL HEAD BOLT M12 X 30mm LONG, THREADS UPTO HEAD, WITH NUTS & WASHERS SUITABLE FOR ORDERED LIGHTING FIXTURE (REFER NOTE-7)			H.D.G.I.	1 SET	ELECTRICAL CONTRACTOR	ELECTRICAL CONTRACTOR
8	ISMC 75			M.S. PAINTED	AS REQUIRED	REFER NOTE-4 & 5	

NOTES:-

- 1) ALL DIMENSION ARE IN 'mm' UNLESS OTHERWISE SPECIFIED.
- 2) THE SUPPORT SHALL BE PREFABRICATED AND PAINTED BEFORE INSTALLATION.
- 3) THE DETAILS (SIZE AND DIMENSIONS) SHALL BE VERIFIED WITH ORDERED LIGHTING FIXTURE.
- 4) SUPPLY & INSTALLATION OF STEEL IS NOT PART OF THIS INSTALLATION ARRANGEMENT. SAME IS COVERED ELSEWHERE.
- 5) LENGTH OF ITEM 8 SHALL BE DECIDED WITH RESPECT TO LAYOUT DRAWING OR WITH CONSULTATION OF SITE ENGINEER. LENGTH SHALL BE RESTRICTED TO MAXIMUM 3 METERS.
- 6) THE DIMENSIONS FOR ITEM-3 AND DETAILS OF HOLES (LOCATION & DIA) SHALL BE VERIFIED WITH THE ORDERED LIGHTING FIXTURE.
- 7) THE QUANTITY & SIZE OF THE HEXAGONAL HEAD BOLT (ITEM-7) REQUIRED FOR CONNECTION OF ITEM-3 TO THE LIGHTING FIXTURE SHALL BE VERIFIED WITH THE ORDERED LIGHTING FIXTURE.

DRAWING NOT TO SCALE

Code		Contract No.		Document ID		Part		Rev.																
00	12/02/16	RDK	ANK	12/02/16	RPM	12/02/16	RPM	ISSUED AS STANDARD	00															
Rev.	Date	Name	Date	Name	Date	Name	Description	Acc. Code	Status															
BAR-Code							Store Location: Server/Share																	
							Store Location: Folder																	
							Store Name LWGC3																	
Pro. Unit		TON		Group		Type of Document		Sheet 1 / 1																
Con. Unit		Scale		Order No.		NTS		thyssenkrupp																
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	Date	Name																						
Drawn	12/02/16	RDK																						
Prepared	12/02/16	ANK																						
Checked	12/02/16	RPM																						
Approved	12/02/16	RPM																						

1		2		3		4	
ITEM	DESCRIPTION			MATERIAL	QTY.	SUPPLY BY	INSTALLATION BY
1	WELL GLASS LIGHTING FIXTURE			—	1 NO.	CLIENT	ELECTRICAL CONTRACTOR
2	PREFABRICATED NB 80 (MEDIUM CLASS) PIPE (REFER NOTE-5)			H.D.G.I.	2.5 MTRS	ELECTRICAL CONTRACTOR	ELECTRICAL CONTRACTOR
3	80 NB x 50 NB REDUCER			H.D.G.I.	1 NO.	ELECTRICAL CONTRACTOR	ELECTRICAL CONTRACTOR
4	PREFABRICATED NB 50 (MEDIUM CLASS) PIPE (REFER NOTE-5)			H.D.G.I.	1.5 MTRS	ELECTRICAL CONTRACTOR	ELECTRICAL CONTRACTOR
5	U BOLT M10 SIZE THREADED AT THE END SUITABLE FOR NB 80 PIPE WITH NUT AND WASHERS			H.D.G.I.	4 SETS	ELECTRICAL CONTRACTOR	ELECTRICAL CONTRACTOR
6	ISMC 75			M.S. PAINTED	AS REQUIRED	REFER NOTE-4	
7	ADAPTOR OR REDUCER OR OTHER ACCESSORIES TO SUIT THE LIGHTING FIXTURE (REFER NOTE-3)			H.D.G.I.	1 NO.	ELECTRICAL CONTRACTOR	ELECTRICAL CONTRACTOR
8	EDGE PROTECTION FOR CABLE			RUBBER	1 NO.	ELECTRICAL CONTRACTOR	ELECTRICAL CONTRACTOR

VIEW-A

FRONT VIEW

DETAIL-1

DRAWING NOT TO SCALE

NOTES:-

- ALL DIMENSION ARE IN 'mm' UNLESS OTHERWISE SPECIFIED.
- THE SUPPORT SHALL BE PREFABRICATED AND PAINTED BEFORE INSTALLATION.
- THE DETAILS (SIZE AND DIMENSIONS) SHALL BE VERIFIED WITH ORDERED LIGHTING FIXTURE.
- SUPPLY & INSTALLATION OF STEEL IS NOT PART OF THIS INSTALLATION ARRANGEMENT. SAME IS COVERED ELSEWHERE.
- THE DETAILS (SIZE AND DIMENSIONS) SHALL BE VERIFIED WITH NB 50 & NB 80 PIPE.

Code		Contract No.		Document ID		Part		Rev.	
00	12/02/16	RDK	ANK	12/02/16	RPM	PIN-LEP-ELT-4003			00
Rev.	Date	Name	Date	Name	Date	Name	Description	Acc. Code	Status
		Drawn/Prepared		Checked		Approved			

BAR-Code

Store Location: Server/Share	
Store Location: Folder	
Store Name LWGR1	
Pro. Unit TON	Group Type of Document Sheet 1 / 1
Con. Unit Scale	Order No.

Date	Name	Description
Drawn 12/02/16	RDK	INSTALLATION STANDARDS – LIGHTING WELL GLASS FIXTURE ON POLE, ON STRUCTURAL STEEL RAILING (LWGR1)
Prepared 12/02/16	ANK	
Checked 12/02/16	RPM	
Approved 12/02/16	RPM	

1	2	3	4
ITEM	DESCRIPTION	MATERIAL	QTY.
1	WELL GLASS LIGHTING FIXTURE	—	1 NO.
2	ISMC 75	M.S. PAINTED	AS REQUIRED
3	BRACKET AS INDICATED IN DETAIL-1 MADE OF 40 x 6mm FLAT STRIP (REFER NOTE-5)	H.D.G.I.	1 NO.
4	HEXAGONAL HEAD BOLT M10 X 30mm LONG, THREADS UPTO HEAD, WITH NUTS & WASHERS SUITABLE FOR CONNECTIONS SHOWN IN THIS DRAWING	H.D.G.I.	2 SETS
5	HEXAGONAL HEAD BOLT M12 X 30mm LONG, THREADS UPTO HEAD, WITH NUTS & WASHERS SUITABLE FOR ORDERED LIGHTING FIXTURE (REFER NOTE-6)	H.D.G.I.	1 SET

SIDE VIEW

PLAN : DETAIL-1

DETAIL-1

DRAWING NOT TO SCALE

NOTES:-

- 1) ALL DIMENSION ARE IN 'mm' UNLESS OTHERWISE SPECIFIED.
- 2) THE SUPPORT SHALL BE PREFABRICATED AND PAINTED BEFORE INSTALLATION. AREA AFFECTED DUE TO SITE WELDING SHALL BE CLEANED & PAINTED
- 3) THE DETAILS (SIZE AND DIMENSIONS) SHALL BE VERIFIED WITH ORDERED LIGHTING FIXTURE.
- 4) SUPPLY & INSTALLATION OF STEEL IS NOT PART OF THIS INSTALLATION ARRANGEMENT. SAME IS COVERED ELSEWHERE.
- 5) THE DIMENSIONS FOR ITEM-3 AND DETAILS OF HOLES (LOCATION & DIA) SHALL BE VERIFIED WITH THE ORDERED LIGHTING FIXTURE.
- 6) THE QUANTITY & SIZE OF THE HEXAGONAL HEAD BOLT (ITEM-5) REQUIRED FOR CONNECTION OF ITEM-3 TO THE LIGHTING FIXTURE SHALL BE VERIFIED WITH THE ORDERED LIGHTING FIXTURE.

Code		Contract No.		Document ID		Part		Rev.	
00	12/02/16	RDK	ANK	12/02/16	RPM	12/02/16	RPM	ISSUED AS STANDARD	00
Rev.	Date	Name	Date	Name	Date	Name	Description	Acc. Code	Status
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Con. Unit		Scale		Order No.					
		NTS							

	Date	Name
Drawn	12/02/16	RDK
Prepared	12/02/16	ANK
Checked	12/02/16	RPM
Approved	12/02/16	RPM

Description
 INSTALLATION STANDARDS – LIGHTING
 WELL GLASS FIXTURE ON BRACKET,
 ON STRUCTURAL COLUMN
 (LWGS1)

1		2		3		4	
ITEM	DESCRIPTION			MATERIAL	QTY.	SUPPLY BY	INSTALLATION BY
1	WELL GLASS LIGHTING FIXTURE			-	1 NO.	CLIENT	ELECTRICAL CONTRACTOR
2	ISMC 75			M.S. PAINTED	AS REQUIRED	REFER NOTE-3 & 4	
3	BRACKET AS INDICATED IN DETAIL-1 MADE OF 40 x 6mm FLAT STRIP (REFER NOTE-5)			H.D.G.I.	1 NO.	ELECTRICAL CONTRACTOR	ELECTRICAL CONTRACTOR
4	HEXAGONAL HEAD BOLT M10 X 30mm LONG, THREADS UPTO HEAD, WITH NUTS & WASHERS SUITABLE FOR CONNECTIONS SHOWN IN THIS DRAWING			H.D.G.I.	2 SETS	ELECTRICAL CONTRACTOR	ELECTRICAL CONTRACTOR
5	HEXAGONAL HEAD BOLT M12 X 30mm LONG, THREADS UPTO HEAD, WITH NUTS & WASHERS SUITABLE FOR ORDERED LIGHTING FIXTURE (REFER NOTE-6)			H.D.G.I.	1 SET	ELECTRICAL CONTRACTOR	ELECTRICAL CONTRACTOR

PLAN : DETAIL-1

DETAIL-1

DRAWING NOT TO SCALE

NOTES:-

- 1) ALL DIMENSION ARE IN 'mm' UNLESS OTHERWISE SPECIFIED.
- 2) THE SUPPORT SHALL BE PREFABRICATED AND PAINTED BEFORE INSTALLATION. AREA AFFECTED DUE TO SITE WELDING SHALL BE CLEANED & PAINTED
- 3) THE DETAILS (SIZE AND DIMENSIONS) SHALL BE VERIFIED WITH ORDERED LIGHTING FIXTURE.
- 4) SUPPLY & INSTALLATION OF STEEL IS NOT PART OF THIS INSTALLATION ARRANGEMENT. SAME IS COVERED ELSEWHERE.
- 5) THE DIMENSIONS FOR ITEM-3 AND DETAILS OF HOLES (LOCATION & DIA) SHALL BE VERIFIED WITH THE ORDERED LIGHTING FIXTURE.
- 6) THE QUANTITY & SIZE OF THE HEXAGONAL HEAD BOLT (ITEM-5) REQUIRED FOR CONNECTION OF ITEM-3 TO THE LIGHTING FIXTURE SHALL BE VERIFIED WITH THE ORDERED LIGHTING FIXTURE.

Code		Contract No.		Document ID		Part		Rev.	
00	12/02/16	RDK	ANK	12/02/16	RPM	12/02/16	RPM	PIN-LEP-ELT-4003	
Rev.	Date	Name	Date	Name	Date	Name	Description	Acc. Code	Status
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							Store Name		
							LWGS2		
Pro. Unit		TON		Group		Type of Document		Sheet	
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Con. Unit		Scale		Order No.					
		NTS							
Date		Name		Description					
12/02/16		RDK		INSTALLATION STANDARDS - LIGHTING					
12/02/16		ANK		WELL GLASS FIXTURE ON SHORT BRACKET,					
12/02/16		RPM		ON STRUCTURAL STEEL BEAM					
12/02/16		RPM		(LWGS2)					

1		2		3		4	
ITEM	DESCRIPTION			MATERIAL	QTY.	SUPPLY BY	INSTALLATION BY
1	WELL GLASS LIGHTING FIXTURE			-	1 NO.	CLIENT	ELECTRICAL CONTRACTOR
2	ISMC 75			M.S. PAINTED	AS REQUIRED	REFER NOTE-3 & 4	
3	BRACKET AS INDICATED IN DETAIL-2 MADE OF 40 x 6mm FLAT STRIP (REFER NOTE-6)			H.D.G.I.	1 NO.	ELECTRICAL CONTRACTOR	ELECTRICAL CONTRACTOR
4	HEXAGONAL HEAD BOLT M10 X 30mm LONG, THREADS UPTO HEAD, WITH NUTS & WASHERS SUITABLE FOR CONNECTIONS SHOWN IN THIS DRAWING			H.D.G.I.	2 SETS	ELECTRICAL CONTRACTOR	ELECTRICAL CONTRACTOR
5	HEXAGONAL HEAD BOLT M12 X 30mm LONG, THREADS UPTO HEAD, WITH NUTS & WASHERS SUITABLE FOR CONNECTIONS SHOWN IN THIS DRAWING			H.D.G.I.	2 SETS	ELECTRICAL CONTRACTOR	ELECTRICAL CONTRACTOR
6	HEXAGONAL HEAD BOLT M12 X 30mm LONG, THREADS UPTO HEAD, WITH NUTS & WASHERS SUITABLE FOR ORDERED LIGHTING FIXTURE (REFER NOTE-7)			H.D.G.I.	1 SET	ELECTRICAL CONTRACTOR	ELECTRICAL CONTRACTOR
7	ISMC 75			M.S. PAINTED	AS REQUIRED	REFER NOTE-4 & 5	

B

C

D

DETAIL-1 (PLAN VIEW)

DETAIL-2

NOTES:-

- ALL DIMENSION ARE IN 'mm' UNLESS OTHERWISE SPECIFIED.
- THE SUPPORT SHALL BE PREFABRICATED AND PAINTED BEFORE INSTALLATION. AREA AFFECTED DUE TO SITE WELDING SHALL BE CLEANED & PAINTED
- THE DETAILS (SIZE AND DIMENSIONS) SHALL BE VERIFIED WITH ORDERED LIGHTING FIXTURE.
- SUPPLY & INSTALLATION OF STEEL IS NOT PART OF THIS INSTALLATION ARRANGEMENT. SAME IS COVERED ELSEWHERE.
- LENGTH OF ITEM 7 SHALL BE DECIDED WITH RESPECT TO LAYOUT DRAWING OR WITH CONSULTATION OF SITE ENGINEER. LENGTH SHALL BE RESTRICTED TO MAXIMUM 3 METERS.
- THE DIMENSIONS FOR ITEM-3 AND DETAILS OF HOLES (LOCATION & DIA) SHALL BE VERIFIED WITH THE ORDERED LIGHTING FIXTURE.
- THE QUANTITY & SIZE OF THE HEXAGONAL HEAD BOLT (ITEM-6) REQUIRED FOR CONNECTION OF ITEM-3 TO THE LIGHTING FIXTURE SHALL BE VERIFIED WITH THE ORDERED LIGHTING FIXTURE.

DRAWING NOT TO SCALE

Code		Contract No.		Document ID		Part		Rev.	
00	12/02/16	RDK	ANK	12/02/16	RPM	12/02/16	RPM	ISSUED AS STANDARD	00
Rev.	Date	Name	Date	Name	Date	Name	Description	Acc. Code	Status
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							Store Name		
							LWGS3		
Pro. Unit		TON		Group		Type of Document		Sheet	
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Con. Unit		Scale		Order No.					
		NTS							
Date		Name		Description					
12/02/16		RDK		INSTALLATION STANDARDS - LIGHTING					
12/02/16		ANK		WELL GLASS FIXTURE ON LONG BRACKET,					
12/02/16		RPM		ON STRUCTURAL STEEL BEAM					
12/02/16		RPM		(LWGS3)					

1	2	3	4
ITEM	DESCRIPTION	MATERIAL	QTY.
1	SWITCH SOCKET	PROJ. SPEC.	1 NO.
2	ANCHOR FASTENER M8 x 60mm LONG WITH SUITABLE NUT & WASHER	GALVANISED STEEL / SS	4 SETS
3	ISMC 75	M.S. PAINTED	AS REQUIRED
4	HEXAGONAL HEAD BOLT M10 X 30mm LONG, THREADS UPTO HEAD, WITH SUITABLE NUTS & WASHERS (REFER NOTE-3)	H.D.G.I.	4 SETS
5	SADDLE WITH BASE STRIP & ACCESSORIES (M6 SCREWS, WASHERS, PLASTIC ANCHORS ETC.)	H.D.G.I.	AS REQUIRED
6	CANOPY COVERED FROM 3 SIDES (REFER NOTE-5)	PROJ. SPEC.	1 NO.
7	HEXAGONAL HEAD BOLT M6 X 25mm LONG, THREADS UPTO HEAD, WITH SUITABLE NUTS & WASHERS (FOR CANOPY FIXING)	H.D.G.I.	4 SETS

FRONT VIEW

VIEW-A

DETAIL-1

DETAIL-2

DRAWING NOT TO SCALE

NOTES


- 1) ALL DIMENSION ARE IN 'mm' UNLESS OTHERWISE STATED.
- 2) STEEL SECTIONS SHALL BE PREFABRICATED & PAINTED BEFORE INSTALLATION.
- 3) THESE DETAILS SHALL BE VERIFIED WITH ORDERED EQUIPMENT DRAWING.
- 4) SUPPLY & INSTALLATION OF STEEL IS NOT PART OF THIS INSTALLATION ARRANGEMENT. SAME IS COVERED ELSEWHERE.
- 5) CANOPY COVERED FROM 3 SIDES SHALL BE PROVIDED FOR LOCAL CONTROL STATION INSTALLED OUTDOOR.

Code		Contract No.		Document ID		Part		Rev.	
00	01.08.2017	KRP	MLD	01.08.2017	RPM	01.08.2017	RPM	PIN-LEP-ELT-4003	00
Rev.	Date	Name		Date	Name	Date	Name	Description	Acc. Code
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Date		Name		Description	
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Prepared	01.08.2017	MLD		SWITCH SOCKET ON	
Checked	01.08.2017	RPM		CONCRETE COLUMN/BRICK WALL	
Approved	01.08.2017	RPM		(LSSC1)	

A	1	2	← 50 mm → 3	4		
	ITEM	DESCRIPTION	MATERIAL	QTY.	SUPPLY BY	INSTALLATION BY
	1	SWITCH SOCKET	PROJ. SPEC.	1 NO.	CLIENT	ELECTRICAL CONTRACTOR
	2	ISMC 100	M.S. PAINTED	AS REQUIRED	REFER NOTE-4	
	3	150 x 150 x10 THK PLATE	M.S. PAINTED	1 NO.	REFER NOTE-4	
	4	25 x 3mm THK. FLAT	M.S. PAINTED	1 METER	REFER NOTE-3 & 4	
	5	HEXAGONAL HEAD BOLT M10 X 30mm LONG, THREADS UPTO HEAD, WITH SUITABLE NUTS & WASHERS (REFER NOTE-3)	H.D.G.I.	4 SETS	ELECTRICAL CONTRACTOR	ELECTRICAL CONTRACTOR
	6	CABLE TIE	PLASTIC	AS REQUIRED	ELECTRICAL CONTRACTOR	ELECTRICAL CONTRACTOR
	7	EDGE PROTECTION FOR CABLE	RUBBER	1 NO.	ELECTRICAL CONTRACTOR	ELECTRICAL CONTRACTOR
	8	CANOPY COVERED FROM 3 SIDES (REFER NOTE-5)	PROJ. SPEC.	1 NO.	ELECTRICAL CONTRACTOR	ELECTRICAL CONTRACTOR
9	HEXAGONAL HEAD BOLT M6 X 25mm LONG, THREADS UPTO HEAD, WITH SUITABLE NUTS & WASHERS (FOR CANOPY FIXING)	H.D.G.I.	4 SETS	ELECTRICAL CONTRACTOR	ELECTRICAL CONTRACTOR	



NOTES

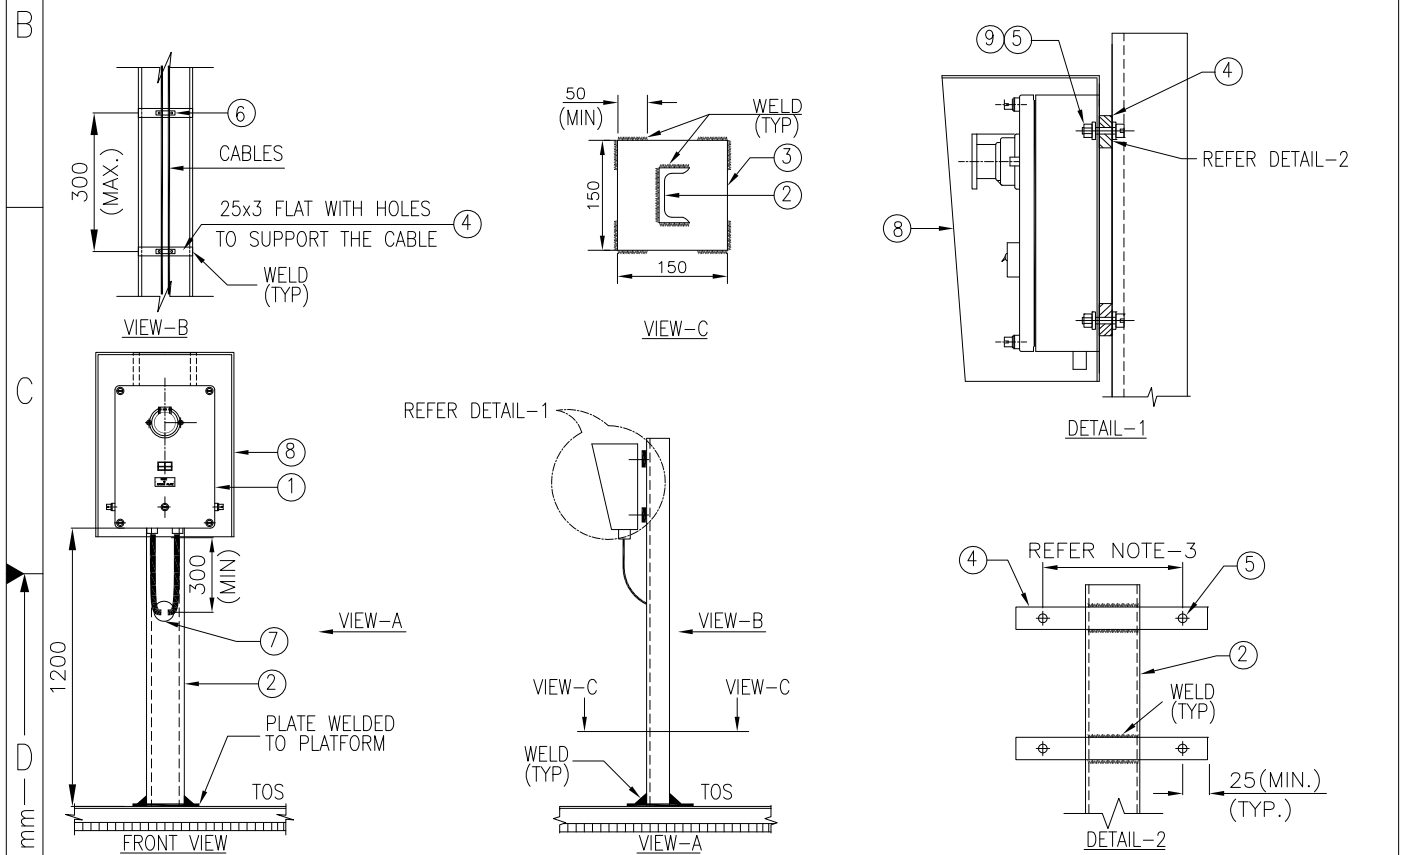
- 1) ALL DIMENSION ARE IN 'mm' UNLESS OTHERWISE STATED.
- 2) STEEL SECTIONS SHALL BE PREFABRICATED & PAINTED BEFORE INSTALLATION. AREA AFFECTED DUE TO SITE WELDING SHALL BE CLEANED AND PAINTED.
- 3) THESE DETAILS SHALL BE VERIFIED WITH ORDERED EQUIPMENT DRAWING.
- 4) SUPPLY & INSTALLATION OF STEEL IS NOT PART OF THIS INSTALLATION ARRANGEMENT. SAME IS COVERED ELSEWHERE.
- 5) CANOPY COVERED FROM 3 SIDES SHALL BE PROVIDED FOR SWITCH SOCKET INSTALLED OUTDOOR.

DRAWING NOT TO SCALE

ISO A4


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Code			Contract No.				Document ID				Part			Rev.
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		Drawn/Prepared		Checked		Approved								
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								Store Name LSSP2						
Pro. Unit		TON			Group		Type of Document			Sheet 1 / 1				
Con. Unit		Scale		Order No.			 thyssenkrupp							
		NTS												
	Date	Name						Description						
Drawn	01.08.2017	KRP						INSTALLATION STANDARDS – POWER						
Prepared	01.08.2017	MLD						SWITCH SOCKET ON						
Checked	01.08.2017	RPM						STEEL PLATFORM/GRATING						
Approved	01.08.2017	RPM						(LSSP2)						

ISO A4


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A	ITEM	DESCRIPTION	MATERIAL	QTY.	SUPPLY BY	INSTALLATION BY	
	1	SWITCH SOCKET	PROJ. SPEC.	1 NO.	CLIENT	ELECTRICAL CONTRACTOR	
	2	ISMC 75	M.S. PAINTED	AS REQUIRED	REFER NOTE-4		
	3	25 x 3mm THK. FLAT	M.S. PAINTED	1.0 METER	REFER NOTE-3 & 4		
	4	U BOLT M10 SIZE THREADED AT THE END SUITABLE FOR HANDRAIL PIPE WITH NUT & WASHERS.	H.D.G.I.	2 SETS	ELECTRICAL CONTRACTOR	ELECTRICAL CONTRACTOR	
	5	HEXAGONAL HEAD BOLT M10 X 30mm LONG, THREADS UPTO HEAD, WITH SUITABLE NUTS & WASHERS (REFER NOTE-3)	H.D.G.I.	2 SETS	ELECTRICAL CONTRACTOR	ELECTRICAL CONTRACTOR	
	6	CABLE TIE	PLASTIC	AS REQUIRED	ELECTRICAL CONTRACTOR	ELECTRICAL CONTRACTOR	
	7	EDGE PROTECTION FOR CABLE	RUBBER	1 NO.	ELECTRICAL CONTRACTOR	ELECTRICAL CONTRACTOR	
	8	CANOPY COVERED FROM 3 SIDES (REFER NOTE-5)	PROJ. SPEC.	1 NO.	ELECTRICAL CONTRACTOR	ELECTRICAL CONTRACTOR	
9	HEXAGONAL HEAD BOLT M6 X 25mm LONG, THREADS UPTO HEAD, WITH SUITABLE NUTS & WASHERS (FOR CANOPY FIXING)	H.D.G.I.	4 SETS	ELECTRICAL CONTRACTOR	ELECTRICAL CONTRACTOR		




NOTES

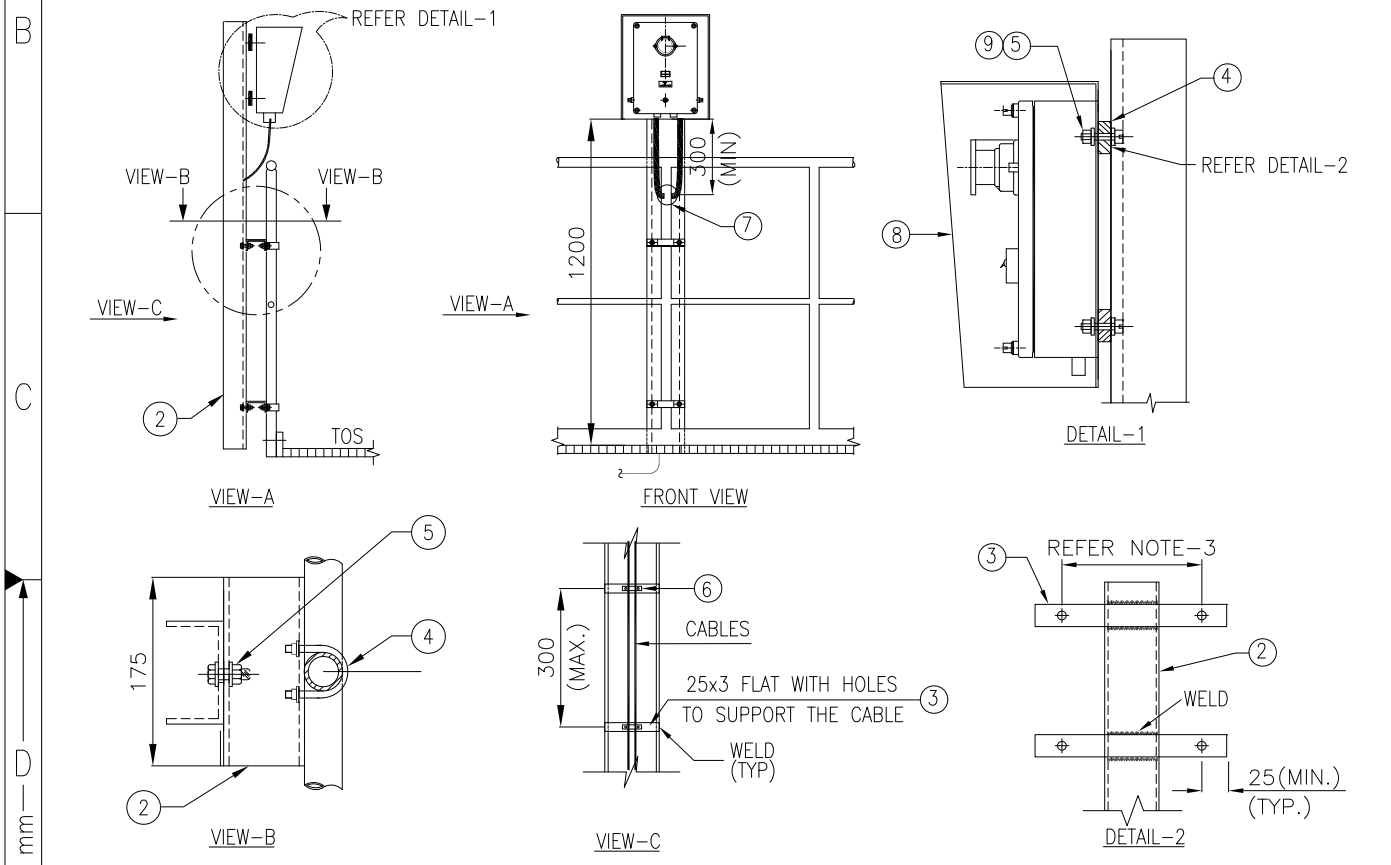- 1) ALL DIMENSION ARE IN 'mm' UNLESS OTHERWISE STATED.
- 2) STEEL SECTIONS SHALL BE PREFABRICATED & PAINTED BEFORE INSTALLATION. AREA AFFECTED DUE TO SITE WELDING SHALL BE CLEANED AND PAINTED.
- 3) THESE DETAILS SHALL BE VERIFIED WITH ORDERED EQUIPMENT DRAWING.
- 4) SUPPLY & INSTALLATION OF STEEL IS NOT PART OF THIS INSTALLATION ARRANGEMENT. SAME IS COVERED ELSEWHERE.
- 5) CANOPY COVERED FROM 3 SIDES SHALL BE PROVIDED FOR SWITCH SOCKET INSTALLED OUTDOOR.


DRAWING NOT TO SCALE

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			NTS																
ISO A4		Date	Name		Description														
	Drawn	01.08.2017	KRP		INSTALLATION STANDARDS – POWER														
	Prepared	01.08.2017	MLD		SWITCH SOCKET ON RAILING														
	Checked	01.08.2017	RPM		(LSSR1)														
	Approved	01.08.2017	RPM																

1	2	3	4
ITEM	DESCRIPTION	MATERIAL	QTY.
1	SWITCH SOCKET	PROJ. SPEC.	1 NO.
2	ISMC 75	M.S. PAINTED	AS REQUIRED
3	HEXAGONAL HEAD BOLT M10 X 30mm LONG, THREADS UPTO HEAD, WITH SUITABLE NUTS & WASHERS (REFER NOTE-3)	HDGI	4 SETS
4	CANOPY COVERED FROM 3 SIDES (REFER NOTE-5)	PROJ. SPEC.	1 NO.
5	HEXAGONAL HEAD BOLT M6 X 25mm LONG, THREADS UPTO HEAD, WITH SUITABLE NUTS & WASHERS (FOR CANOPY FIXING)	HDGI	4 SETS

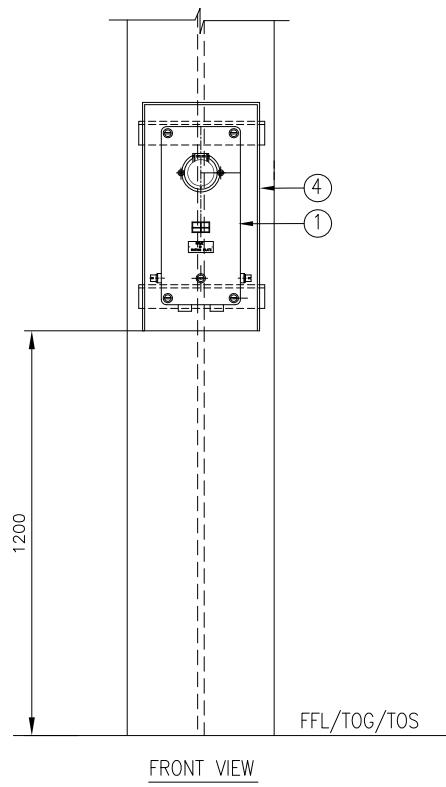

FRONT VIEW

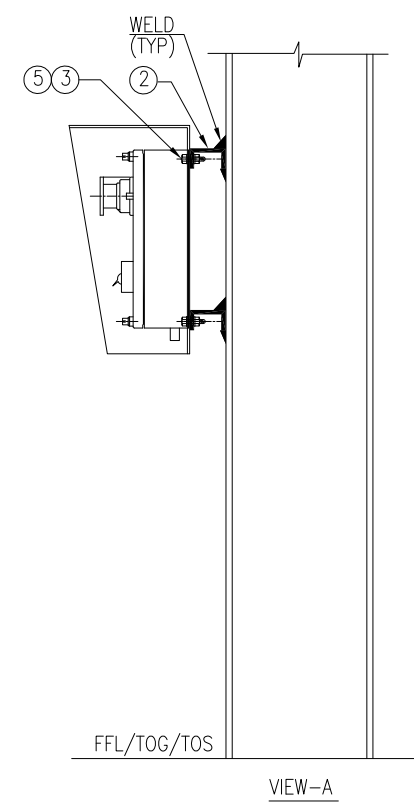


VIEW-A

DRAWING NOT TO SCALE

NOTES

- 1) ALL DIMENSION ARE IN 'mm' UNLESS OTHERWISE STATED.
- 2) STEEL SECTIONS SHALL BE PREFABRICATED & PAINTED BEFORE INSTALLATION. AREA AFFECTED DUE TO SITE WELDING SHALL BE CLEANED AND PAINTED.
- 3) THESE DETAILS SHALL BE VERIFIED WITH ORDERED EQUIPMENT DRAWING.
- 4) SUPPLY & INSTALLATION OF STEEL IS NOT PART OF THIS INSTALLATION ARRANGEMENT. SAME IS COVERED ELSEWHERE.
- 5) CANOPY COVERED FROM 3 SIDES SHALL BE PROVIDED FOR SWITCH SOCKET INSTALLED OUTDOOR.

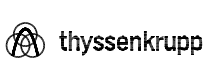Code		Contract No.		Document ID		Part		Rev.	
00	01.08.2017	KRP	MLD	01.08.2017	RPM	01.08.2017	RPM	PIN-LEP-ELT-4003	
Rev.	Date	Name		Date	Name	Date	Name	Cat. Code	Acc. Code
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							Store Name		
							LSSS1		
Pro. Unit		TON		Group		Type of Document		Sheet	
								1 / 1	
Con. Unit		Scale		Order No.					
		NTS							

ISO A4

	Date	Name
Drawn	01.08.2017	KRP
Prepared	01.08.2017	MLD
Checked	01.08.2017	RPM
Approved	01.08.2017	RPM

Description

INSTALLATION STANDARDS – LIGHTING SWITCH SOCKET ON STEEL STRUCTURE (LSSS1)

1	2	3	4	5	6
ITEM	DESCRIPTION	MATERIAL	QTY.	SUPPLY BY	INSTALLATION BY
1	JUNCTION BOX	—	1 NO.	CLIENT	ELECTRICAL CONTRACTOR
2	ACCESSORIES TO FIX JUNCTION BOX SUCH AS PLASTIC ANCHORS, M6 HDGI SCREWS ETC. (REFER NOTE-2)	—	4 SETS	ELECTRICAL CONTRACTOR	ELECTRICAL CONTRACTOR

VIEW A

FRONT VIEW

VIEW-A

JUNCTION BOX ON WALL/CONCRETE COLUMN
(VARIATION-1)

JUNCTION BOX ON CONCRETE CEILING
(VARIATION-2)

DRAWING NOT TO SCALE

NOTES

1) ALL DIMENSION ARE IN 'mm' UNLESS OTHERWISE SPECIFIED.

2) THESE DETAILS SHALL BE VERIFIED WITH ORDERED EQUIPMENT DRAWING.

Code		Contract No.		Document ID		Part		Rev.	
00	15.09.2017	KRP	MLD	15.09.2017	RPM	15.09.2017	RPM	PIN-LEP-ELT-4003	00
Rev.	Date	Name		Date	Name	Date	Name	Description	Acc. Code
		Drawn/Prepared			Checked		Approved		

Store Location: Server/Share		Store Location: Folder		Store Name		Pro. Unit		Group		Type of Document		Sheet	
				LJBC1		TON						1 / 1	
Con. Unit		Scale		Order No.									
		NTS											

	Date	Name	Description
Drawn	15.09.2017	KRP	INSTALLATION STANDARDS – LIGHTING JUNCTION BOX ON WALL/CONCRETE COLUMN : TYPE 1 (LJBC1)
Prepared	15.09.2017	MLD	
Checked	15.09.2017	RPM	
Approved	15.09.2017	RPM	

1

2

50 mm

3

4

ITEM

DESCRIPTION

MATERIAL

QTY.

SUPPLY BY

INSTALLATION BY

1

JUNCTION BOX

—

1 NO.

CLIENT

ELECTRICAL CONTRACTOR

2

HEXAGONAL HEAD BOLT M6 X 25mm LONG, THREADS UPTO HEAD, WITH SUITABLE NUTS & WASHERS (REFER NOTE-3)

H.D.G.I.

2 SETS

ELECTRICAL CONTRACTOR

ELECTRICAL CONTRACTOR

3

ISM 75

M.S. PAINTED

AS REQUIRED

(REFER NOTE-3 & 4)

4



ANCHOR FASTENER M6 x 50mm LONG WITH SUITABLE NUT & WASHER

GALVANISED STEEL / SS

1 SET

ELECTRICAL CONTRACTOR

ELECTRICAL CONTRACTOR

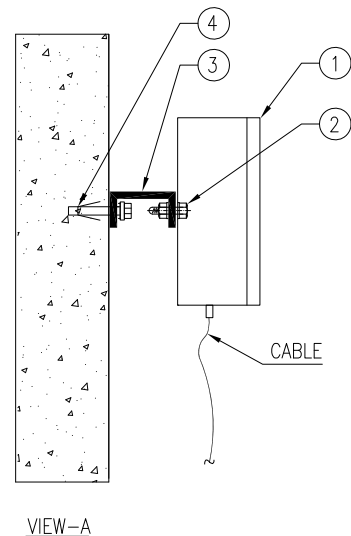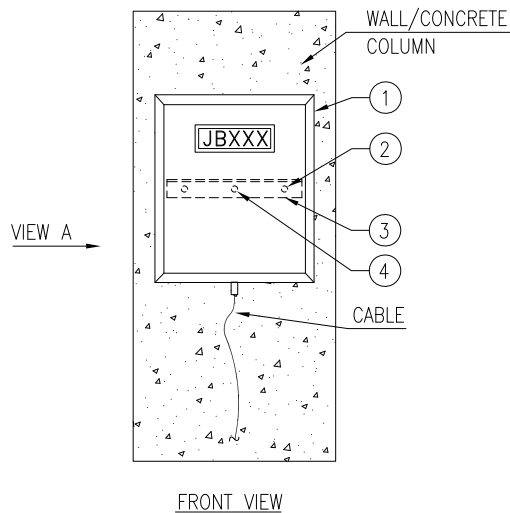

DRAWING NOT TO SCALE


NOTES

- 1) ALL DIMENSION ARE IN 'mm' UNLESS OTHERWISE STATED.
- 2) STEEL SECTIONS SHALL BE PREFABRICATED & PAINTED BEFORE INSTALLATION.
- 3) THESE DETAILS SHALL BE VERIFIED WITH ORDERED EQUIPMENT DRAWING.
- 4) SUPPLY & INSTALLATION OF STEEL IS NOT PART OF THIS INSTALLATION ARRANGEMENT. SAME IS COVERED ELSEWHERE.


ISO A4

E

F

Code		Contract No.				Document ID		PIN-LEP-ELT-4003				Part	Rev.
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Rev.	Date	Name		Date	Name		Date	Name		Description	Acc. Code		
		Drawn/Prepared				Checked				Approved			
BAR-Code										Store Location: Server/Share			
										Store Location: Folder			
										Store Name LJBC2			
Pro. Unit		TON		Group		Type of Document		Sheet		1 / 1			
Con. Unit		Scale		Order No.		 thyssenkrupp							
		NTS											
	Date	Name		Description									
Drawn	15.09.2017	KRP		INSTALLATION STANDARDS – LIGHTING									
Prepared	15.09.2017	MLD		JUNCTION BOX ON WALL/CONCRETE									
Checked	15.09.2017	RPM		COLUMN : TYPE 2									
Approved	15.09.2017	RPM		(LJBC2)									

1	2	3	4
ITEM	DESCRIPTION	MATERIAL	QTY.
1	JUNCTION BOX	PROJ. SPEC.	1 NO.
2	ISMC 75	M.S. PAINTED	AS REQUIRED
3	U BOLT M10 SIZE THREADED AT THE END SUITABLE FOR HANDRAIL PIPE WITH NUT & WASHERS.	H.D.G.I.	1 SET
			SUPPLY BY
			CLIENT
			(REFER NOTE-3 & 4)
			ELECTRICAL CONTRACTOR
			INSTALLATION BY
			ELECTRICAL CONTRACTOR

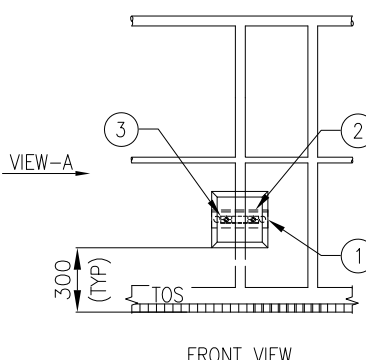


VIEW-A

300 (TYP)

TOS

FRONT VIEW

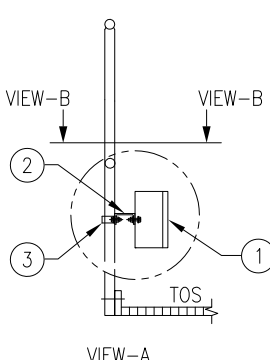


VIEW-B

VIEW-B

TOS

VIEW-A

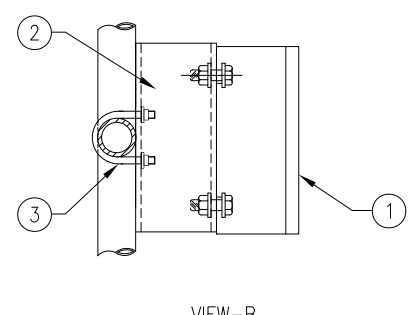

VIEW-B

DRAWING NOT TO SCALE

NOTES

1) ALL DIMENSION ARE IN 'mm' UNLESS OTHERWISE STATED.

2) STEEL SECTIONS SHALL BE PREFABRICATED & PAINTED BEFORE INSTALLATION.

3) THESE DETAILS SHALL BE VERIFIED WITH ORDERED EQUIPMENT DRAWING.

4) SUPPLY & INSTALLATION OF STEEL IS NOT PART OF THIS INSTALLATION ARRANGEMENT. SAME IS COVERED ELSEWHERE.

Code				Contract No.				Document ID				Part				Rev.	
								PIN-LEP-ELT-4003								00	
00	15.09.2017	KRP	MLD	15.09.2017	RPM	15.09.2017	RPM	ISSUED AS STANDARD						Cat. Code	Acc. Code	Status	
Rev.	Date	Name		Date	Name	Date	Name	Description				Acc. Code					
Drawn/Prepared				Checked				Approved									

BAR-Code

Store Location: Server/Share


Store Location: Folder

Store Name

LJBR1

Pro. Unit TON Group Type of Document Sheet 1 / 1

Con. Unit Scale Order No.

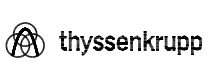

NTS

	Date	Name	Description
Drawn	15.09.2017	KRP	INSTALLATION STANDARDS - LIGHTING JUNCTION BOX ON RAILING (LJBR1)
Prepared	15.09.2017	MLD	
Checked	15.09.2017	RPM	
Approved	15.09.2017	RPM	

1	2	3	4
ITEM	DESCRIPTION	MATERIAL	QTY.
1	JUNCTION BOX	PROJ. SPEC.	1 NO.
2	ISMC 75	M.S. PAINTED	AS REQUIRED
3	HEXAGONAL HEAD BOLT M6 X 25mm LONG, THREADS UPTO HEAD, WITH SUITABLE NUTS & WASHERS (REFER NOTE-3)	H.D.G.I.	2 SETS
		SUPPLY BY	INSTALLATION BY
		CLIENT	ELECTRICAL CONTRACTOR
		(REFER NOTE-3 & 4)	
		ELECTRICAL CONTRACTOR	ELECTRICAL CONTRACTOR

VIEW-A
(DETAILED)

VARIATION 1

VARIATION 2

VARIATION 3

VARIATION 4

DRAWING NOT TO SCALE



NOTES

- 1) ALL DIMENSION ARE IN 'mm' UNLESS OTHERWISE STATED.
- 2) STEEL SECTIONS SHALL BE PREFABRICATED & PAINTED BEFORE INSTALLATION. AREA AFFECTED DUE TO SITE WELDING SHALL BE CLEANED AND PAINTED.
- 3) THESE DETAILS SHALL BE VERIFIED WITH ORDERED EQUIPMENT DRAWING.
- 4) SUPPLY & INSTALLATION OF STEEL IS NOT PART OF THIS INSTALLATION ARRANGEMENT. SAME IS COVERED ELSEWHERE.



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00	15.09.2017	KRP	MLD	15.09.2017	RPM	15.09.2017	RPM	ISSUED AS STANDARD	00
Rev.	Date	Name		Date	Name	Date	Name	Description	Acc. Code
		Drawn/Prepared			Checked		Approved		

BAR-Code		Store Location: Server/Share	
		Store Location: Folder	
		Store Name LJBS1	
Pro. Unit	TON	Group	Type of Document
Con. Unit	Scale	Order No.	Sheet 1 / 1
NTS			

ISO A4	Date	Name	Description
Drawn	15.09.2017	KRP	INSTALLATION STANDARDS - LIGHTING JUNCTION BOX ON STEEL STRUCTURE (LJBS1)
Prepared	15.09.2017	MLD	
Checked	15.09.2017	RPM	
Approved	15.09.2017	RPM	



Plant 1.0 MTPA ALUMINA REFINERY STREAM-5	Client NALCO	Contract Code NAL	Document ID 6695-ELT-G00-EC-0027	Contract No. 66-6695
	ELECTRICAL INSTALLATION PART- IV - INSTALLATION DETAIL- LIGHTNING PROTECTION			नालको  NALCO नेशनल एल्युमिनियम कम्पनी लिमिटेड National Aluminium Company Ltd.
				Rev 0 Page 1 of 3

INSTALLATION DETAIL-LIGHTNING PROTECTION

Plant 1.0 MTPA ALUMINA REFINERY STREAM-5	Client NALCO	Contract Code NAL	Document ID 6695-ELT-G00-EC-0027	Contract No. 66-6695		
 thyssenkrupp	ELECTRICAL INSTALLATION PART- IV - INSTALLATION DETAIL- LIGHTNING PROTECTION			नालको  NALCO नेशनल एल्युमिनियम कम्पनी लिमिटेड National Aluminium Company Ltd.		
				Rev	0	Page

LIST OF INSTALLATION STANDARDS

Sr. No.	Description	Typical No.	No. of Sheets	Rev
1	Lightning conductor, round. on flat surface with concrete weight	LPC1	1	0
2	Lightning conductor, round, on flat surface with adhesion	LPC2	1	0
3	Lightning conductor, round, on flat surface with conductor holder	LPC3	1	0
4	Lightning conductor, round, on flat surface with saddle/clamp	LPC4	1	0
5	Lightning conductor, round, on corrugated roof	LPC5	1	0
6	Lightning conductor, strip, on flat surface with conductor holder	LPC6	1	0
7	Lightning conductor, strip, on corrugated roof	LPC7	1	0
8	Lightning down conductor, round, on wall with saddle/clamp	LPD1	1	0
9	Lightning down conductor, round, on wall with conductor holder	LPD2	1	0
10	Lightning down conductor, strip, on wall with conductor holder	LPD3	1	0
11	Lightning down conductor on steel column with attachment clamp	LPD4	1	0
12	Test joint	LPJ1	1	0
13	Self-standing air termination rod	LPR1	1	0
14	Air termination rod with tripod arrangement	LPR2	1	0
15	Air termination rod on steel structure	LPR3	1	0
16	Air termination rod on concrete surface	LPR4	1	0
17	Air termination rod on roof truss	LPR5	1	0
18	Cross Connector/T-connector	LPT1	1	0
19	Expansion piece with connector	LPT2	1	0
20	Parallel connector	LPT3	1	0
21	Lightning conductor schedule	LSCH	1	0

Plant 1.0 MTPA ALUMINA REFINERY STREAM-5	Client NALCO	Contract Code NAL	Document ID 6695-ELT-G00-EC-0027	Contract No. 66-6695		
 thyssenkrupp	ELECTRICAL INSTALLATION PART- IV - INSTALLATION DETAIL- LIGHTNING PROTECTION			नालको  NALCO नेशनल एल्युमिनियम कम्पनी लिमिटेड National Aluminium Company Ltd.		
				Rev	0	Page

1. General:

- The documents/drawings as indicated below shall be prepared by the LSTK Contractor as a part of detail Engineering.
- These notes shall be read and construed in conjunction with Lightning Protection layout drawings and Installation Standards – Installation Standards - Lightning Protection.

2. Lightning protection:

- Earthing of buildings and structures for the purpose of lightning protection shall be designed in accordance with national regulations. An earthing system designed and installed for purposes other than lightning protection (e.g. protective earthing, but excluding instrument earthing systems) may be used to serve the lightning protection system.
- Lightning protection down conductors shall be cleated on outer side of the building wall at every 500 mm interval.
- Connection between each down conductor and earthing conductor/ lightning earth pit shall be made via test link located approximately 1000 mm above ground level.
- Lightning conductors shall not pass through GI conduits. The same shall not have sharp bends and should be as straight as possible.
- All metallic structures within a vicinity of 2000 mm in air shall be bonded to the conductors of lightning protection system.
- Separate earth pits to be considered for lightning arrestors.

1



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50 mm


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4

ITEM	DESCRIPTION	MATERIAL	QTY.	SUPPLY BY	INSTALLATION BY
1	LIGHTNING CONDUCTOR, ROUND, $\phi 8\text{mm}$ (AL) / $\phi 10\text{mm}$ (HDGI)	ALUMINIUM/ HDGI	AS REQUIRED	ELECTRICAL CONTRACTOR	ELECTRICAL CONTRACTOR
2	CONDUCTOR HOLDER FOR FLAT SURFACE FILLED WITH CONCRETE, WITH CLOSED SHAPE BASE & WITH DOUBLE CABLE CLAMP SUITABLE FOR LIGHTNING CONDUCTOR (ITEM NO. 1)	POLYETHYLENE FILLED WITH CONCRETE	AS REQUIRED	ELECTRICAL CONTRACTOR	ELECTRICAL CONTRACTOR



DETAIL-A

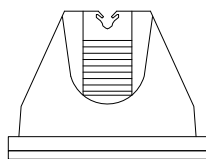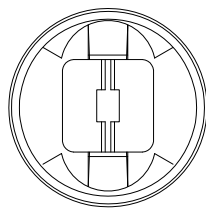

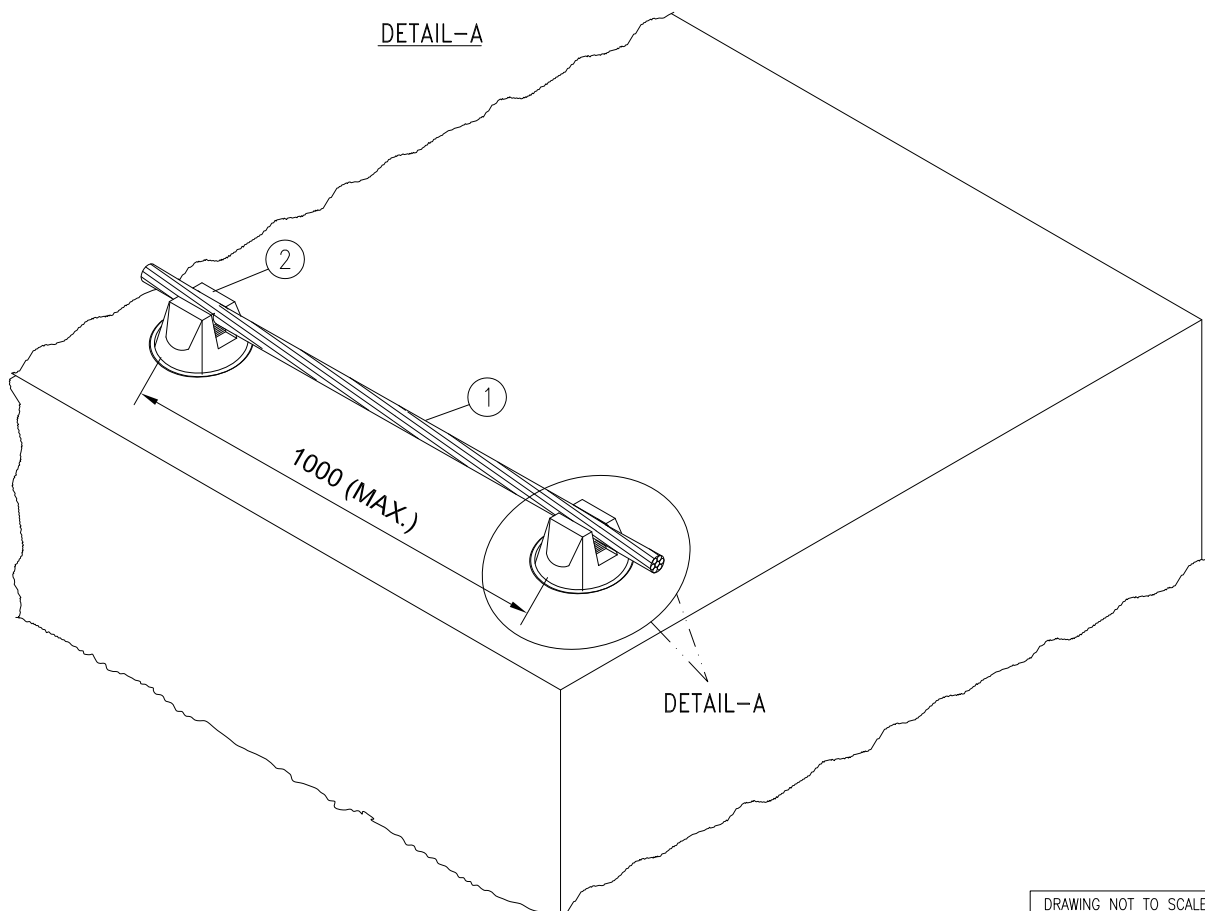DRAWING NOT TO SCALE

NOTE:

1) ALL DIMENSIONS ARE IN 'mm' UNLESS OTHERWISE SPECIFIED.

Code			Contract No.			Document ID				Part		Rev.		
						PIN-LEP-ELT-4004						00		
00	02/01/17	KRP	MLD	02/01/17	RPM	02/01/17	RPM	ISSUED AS STANDARD				Cat. Code	Acc. Code	Status
Rev.	Date	Name		Date	Name	Date	Name	Description			Acc. Code			
		Drawn/Prepared			Checked		Approved							

BAR-Code

Store Location: Server/Share

Store Location: Folder

Store Name LPC1

Pro. Unit	TON	Group	Type of Document	Sheet
				1 / 1

Con. Unit	Scale	Order No.	
	NTS		

	Date	Name
Drawn	02/01/17	KRP
Prepared	02/01/17	MLD
Checked	02/01/17	RPM
Approved	02/01/17	RPM

Description
 INSTALLATION STANDARDS –
 LIGHTNING PROTECTION
 LIGHTNING CONDUCTOR, ROUND, ON FLAT
 SURFACE WITH CONCRETE WEIGHT (LPC1)

ISO A4

1	2	3	4		
ITEM	DESCRIPTION	MATERIAL	QTY.	SUPPLY BY	INSTALLATION BY
1	LIGHTNING CONDUCTOR, ROUND, $\phi 8\text{mm}$ (AL) / $\phi 10\text{mm}$ (HDGI)	ALUMINIUM/HDGI	AS REQUIRED	ELECTRICAL CONTRACTOR	ELECTRICAL CONTRACTOR
2	CONDUCTOR HOLDER SUITABLE FOR BONDING DIRECTLY TO FLAT SURFACE & TO ACCOMMODATE ROUND CONDUCTOR UP TO $\phi 10\text{mm}$ ALONG WITH SUITABLE ACCESSORIES (NUTS, BOLTS, WASHERS ETC.) AS INDICATED	HDGI AND/OR POLYAMIDE	AS REQUIRED	ELECTRICAL CONTRACTOR	ELECTRICAL CONTRACTOR
3	ADHESIVE FOR CONDUCTOR HOLDER	—	AS REQUIRED	ELECTRICAL CONTRACTOR	ELECTRICAL CONTRACTOR

VIEW-A

1000 (MAX.)

VIEW-A

DRAWING NOT TO SCALE

NOTE:
1) ALL DIMENSIONS ARE IN 'mm' UNLESS OTHERWISE SPECIFIED.

Code		Contract No.		Document ID				Part		Rev.		
				PIN-LEP-ELT-4004						00		
00	02/01/17	KRP	MLD	02/01/17	RPM	02/01/17	RPM	ISSUED AS STANDARD		Cat. Code	Acc. Code	Status
Rev.	Date	Name		Date	Name	Date	Name	Description	Acc. Code			
			Drawn/Prepared		Checked		Approved					

BAR-Code				Store Location: Server/Share				
				Store Location: Folder				
				Store Name LPC2				
				Pro. Unit	TON	Group	Type of Document	Sheet
				Con. Unit	Scale	Order No.		
				NTS				

ISO A4		Date	Name	Description INSTALLATION STANDARDS – LIGHTNING PROTECTION LIGHTNING CONDUCTOR ON FLAT SURFACE WITH ADHESION (LPC2)
	Drawn	02/01/17	KRP	
	Prepared	02/01/17	MLD	
	Checked	02/01/17	RPM	
	Approved	02/01/17	RPM	

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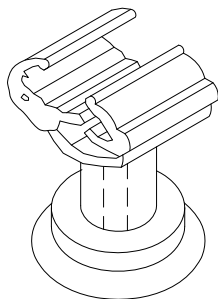
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50 mm


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4

ITEM	DESCRIPTION	MATERIAL	QTY.	SUPPLY BY	INSTALLATION BY
1	LIGHTNING CONDUCTOR, ROUND, $\phi 8\text{mm}$ (AL) / $\phi 10\text{mm}$ (HDGI)	HDGI	AS REQUIRED	ELECTRICAL CONTRACTOR	ELECTRICAL CONTRACTOR
2	CONDUCTOR HOLDER FOR ROUND CONDUCTOR UP TO $\phi 10\text{mm}$ WITH FEMALE THREAD & THROUGH HOLE FOR SCREWS	POLYAMIDE OR EQUIVALENT	AS REQUIRED	ELECTRICAL CONTRACTOR	ELECTRICAL CONTRACTOR
3	ACCESSORIES TO FIX CONDUCTOR HOLDER TO FLAT SURFACE (SCREW, PLASTIC ANCHOR ETC.)	HDGI	AS REQUIRED	ELECTRICAL CONTRACTOR	ELECTRICAL CONTRACTOR



ENLARGED VIEW OF ITEM-2

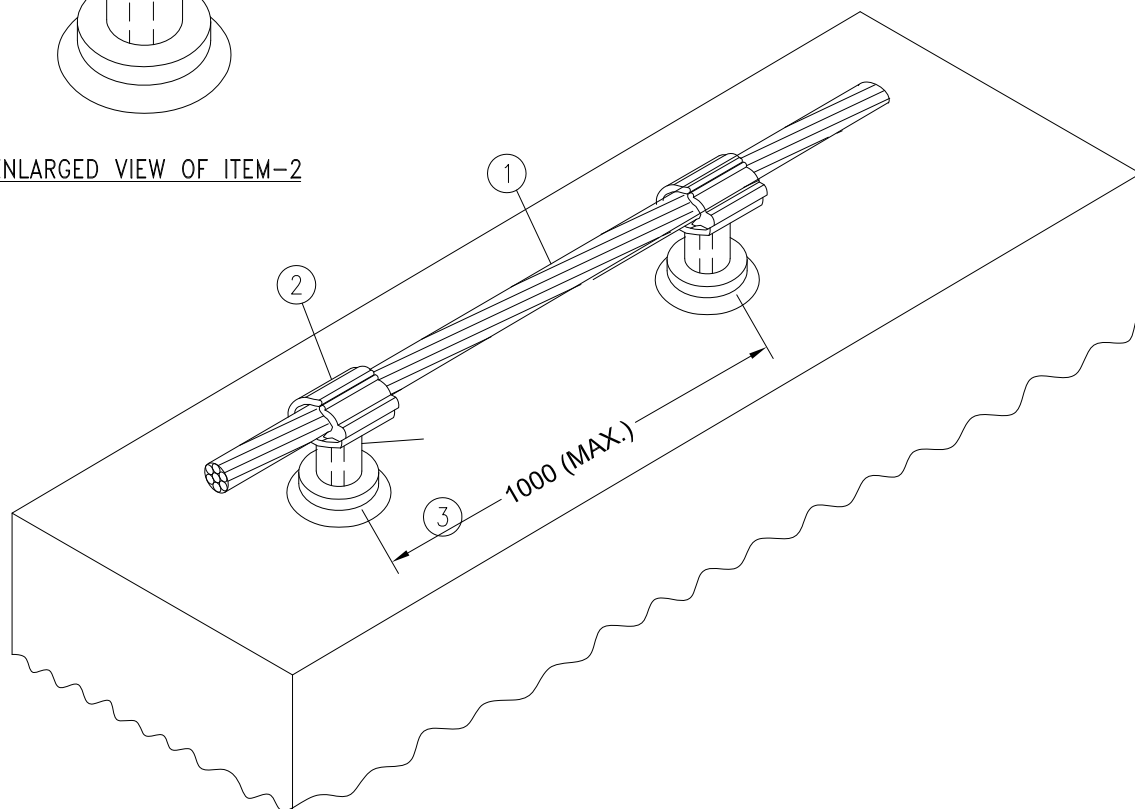

DRAWING NOT TO SCALE

NOTES:

- 1) ALL DIMENSIONS ARE IN 'mm' UNLESS OTHERWISE SPECIFIED.
- 2) DETAILS OF SCREW (M6 OR M8 ETC.) SHALL BE DECIDED AT SITE BASED ON ACTUAL REQUIREMENT OF ITEM NO. 2

Code		Contract No.		Document ID				Part		Rev.																	
				PIN-LEP-ELT-4004						00																	
00	02/01/17	KRP	MLD	02/01/17	RPM	02/01/17	RPM	ISSUED AS STANDARD		Cat. Code	Acc. Code	Status															
Rev.	Date	Name		Date	Name	Date	Name	Description	Acc. Code																		
Drawn/Prepared			Checked			Approved																					
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								Store Name LPC3																			
Pro. Unit				TON		Group		Type of Document		Sheet																	
										1 / 1																	
Con. Unit				Scale		Order No.																					
				NTS																							
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	Date	Name																									
Drawn	02/01/17	KRP																									
Prepared	02/01/17	MLD																									
Checked	02/01/17	RPM																									
Approved	02/01/17	RPM																									

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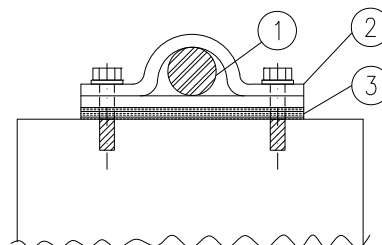
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50 mm


3

4

ITEM	DESCRIPTION	MATERIAL	QTY.	SUPPLY BY	INSTALLATION BY
1	LIGHTNING CONDUCTOR, ROUND, $\phi 8\text{mm}$ (AL) / $\phi 10\text{mm}$ (HDGI)	ALUMINIUM/ HDGI	AS REQUIRED	ELECTRICAL CONTRACTOR	ELECTRICAL CONTRACTOR
2	SADDLE WITH BASE STRIP & ACCESSORIES AS INDICATED (M6 SCREWS, WASHERS, PLASTIC ANCHORS ETC.)	HDGI	AS REQUIRED	ELECTRICAL CONTRACTOR	ELECTRICAL CONTRACTOR
3	INSULATING BASE STRIP	PVC OR EQUIVALENT	AS REQUIRED	ELECTRICAL CONTRACTOR	ELECTRICAL CONTRACTOR




VIEW-A

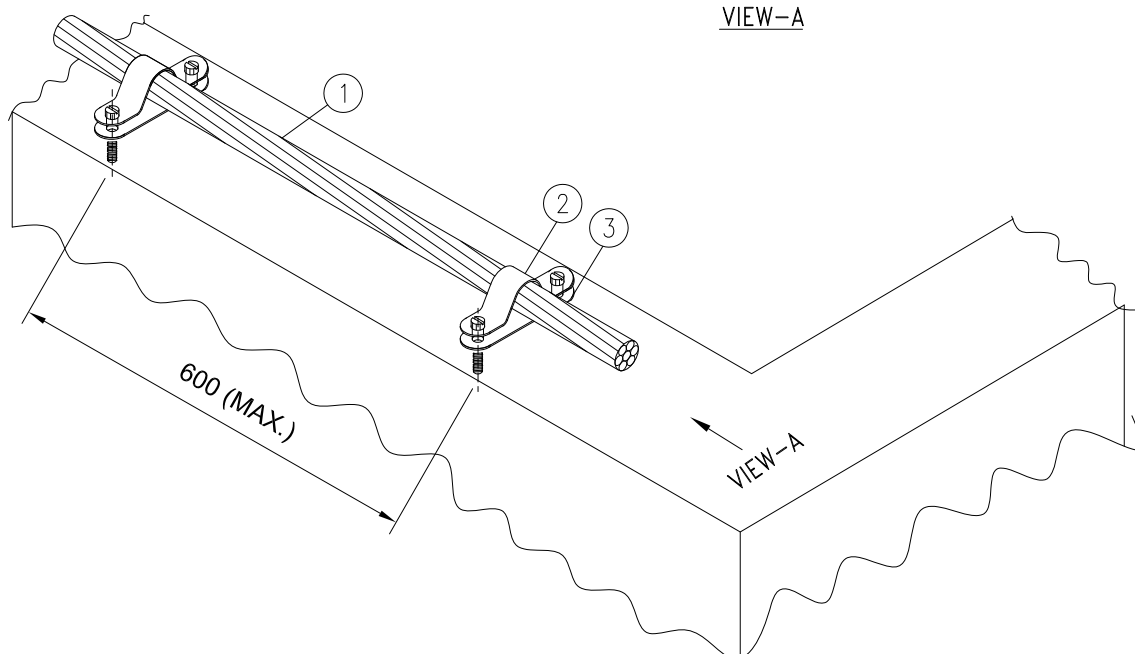

DRAWING NOT TO SCALE

NOTE:

1) ALL DIMENSIONS ARE IN 'mm' UNLESS OTHERWISE SPECIFIED.

Code			Contract No.			Document ID				Part			Rev.		
00			02/01/17 KRP			MLD			02/01/17 RPM			PIN-LEP-ELT-4004			00
00	02/01/17	KRP	MLD	02/01/17	RPM	02/01/17	RPM	ISSUED AS STANDARD				Cat. Code	Acc. Code	Status	
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BAR-Code								Store Location: Server/Share							
								Store Location: Folder							
								Store Name LPC4							
Pro. Unit		TON			Group		Type of Document			Sheet 1 / 1					
Con. Unit		Scale		Order No.		 thyssenkrupp									
		NTS													

ISO A4

	Date	Name
Drawn	02/01/17	KRP
Prepared	02/01/17	MLD
Checked	02/01/17	RPM
Approved	02/01/17	RPM

Description
 INSTALLATION STANDARDS –
 LIGHTNING PROTECTION
 LIGHTNING CONDUCTOR ON FLAT SURFACE
 WITH SADDLE/CLAMP (LPC4)

1	2	3	4	5	6
ITEM	DESCRIPTION	MATERIAL	QTY.	SUPPLY BY	INSTALLATION BY
1	LIGHTNING CONDUCTOR, ROUND, $\phi 8\text{mm}$ (AL) / $\phi 10\text{mm}$ (HDGI)	ALUMINIUM/ HDGI	AS REQUIRED	ELECTRICAL CONTRACTOR	ELECTRICAL CONTRACTOR
2	CONDUCTOR STRAP SUITABLE FOR ROUND CONDUCTOR UP TO $\phi 10\text{mm}$ (REFER NOTE-2 & 3)	HDGI	AS REQUIRED	ELECTRICAL CONTRACTOR	ELECTRICAL CONTRACTOR

VIEW-A

VIEW-A

DRAWING NOT TO SCALE

NOTES:


- 1) ALL DIMENSIONS ARE IN 'mm' UNLESS OTHERWISE SPECIFIED.
- 2) DURING ENGINEERING CIVIL SHALL BE INFORMED ABOUT THE ARRANGEMENT IN ORDER TO SELECT LONGER LENGTH OF J-BOLT.
- 3) STRAP HOLES SHALL BE SUITABLE FOR SIZE OF THE J-BOLT. DIMENSION OF J-BOLT SHALL BE VERIFIED AT SITE BEFORE INSTALLATION.

Code	Contract No.	Document ID	Part	Rev.
00	02/01/17 KRP	02/01/17 RPM	PIN-LEP-ELT-4004	00
Rev.	Date	Name	Description	Status
00	02/01/17	KRP	ISSUED AS STANDARD	00
Rev.	Date	Name	Description	Status
00	02/01/17	KRP	ISSUED AS STANDARD	00


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Pro. Unit: TON	Group: Type of Document
Con. Unit: Scale	Order No.

Date	Name	Description
Drawn	02/01/17 KRP	INSTALLATION STANDARDS – LIGHTNING PROTECTION LIGHTNING CONDUCTOR ON CORRUGATED ROOF (LPC5)
Prepared	02/01/17 MLD	
Checked	02/01/17 RPM	
Approved	02/01/17 RPM	

1	2	3	4	5	6
ITEM	DESCRIPTION	MATERIAL	QTY.	SUPPLY BY	INSTALLATION BY
1	LIGHTNING CONDUCTOR, STRIP, 25X3mm	HDGI	AS REQUIRED	ELECTRICAL CONTRACTOR	ELECTRICAL CONTRACTOR
2	CONDUCTOR HOLDER FOR STRIP CONDUCTOR UP TO 30X3.5mm WITH INSULATED BASE (PLASTIC) & THROUGH HOLE FOR SCREWS	HDGI	AS REQUIRED	ELECTRICAL CONTRACTOR	ELECTRICAL CONTRACTOR
3	ACCESSORIES TO FIX CONDUCTOR HOLDER TO FLAT SURFACE (SCREW, PLASTIC ANCHOR ETC.)	HDGI	AS REQUIRED	ELECTRICAL CONTRACTOR	ELECTRICAL CONTRACTOR

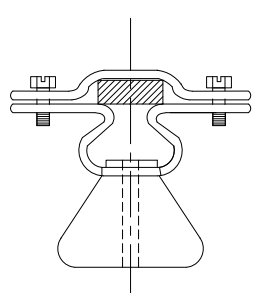

VIEW-A

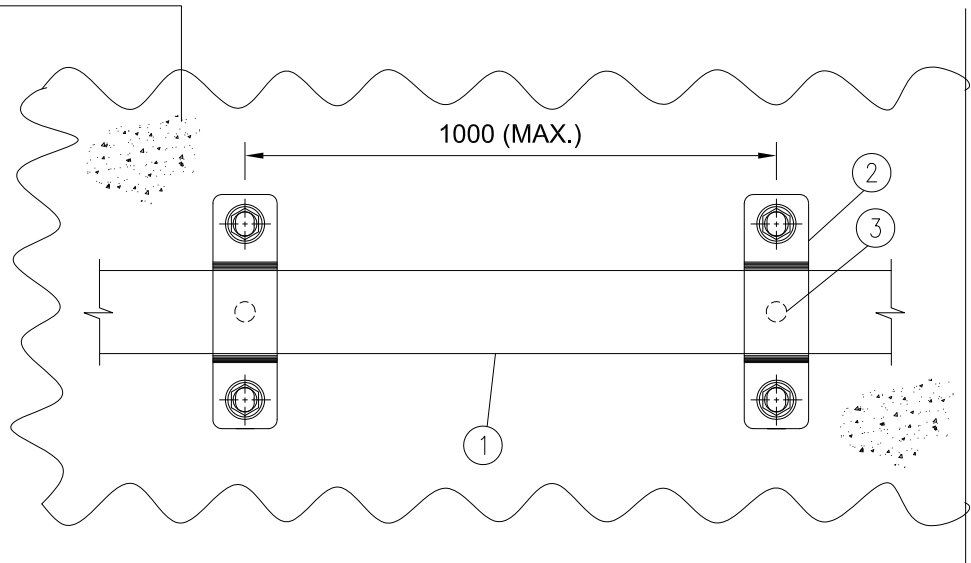

VIEW-A

DRAWING NOT TO SCALE

NOTES:

- ALL DIMENSIONS ARE IN 'mm' UNLESS OTHERWISE SPECIFIED.
- DETAILS OF SCREW (M6 OR M8 ETC.) SHALL BE DECIDED AT SITE BASED ON ACTUAL REQUIREMENT OF ITEM NO. 2

Code		Contract No.		Document ID		Part		Rev.	
00	02/01/17	KRP	MLD	02/01/17	RPM	02/01/17	RPM	PIN-LEP-ELT-4004	
Rev.	Date	Name	Date	Name	Date	Name	Description	Acc. Code	Status
		Drawn/Prepared		Checked		Approved			

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Con. Unit		Scale		Order No.									
		NTS											

Date	Name	Description
02/01/17	KRP	INSTALLED AS STANDARD
02/01/17	MLD	CONDUCTOR HOLDER FOR STRIP CONDUCTOR UP TO 30X3.5mm WITH INSULATED BASE (PLASTIC) & THROUGH HOLE FOR SCREWS
02/01/17	RPM	ACCESSORIES TO FIX CONDUCTOR HOLDER TO FLAT SURFACE (SCREW, PLASTIC ANCHOR ETC.)
02/01/17	RPM	INSTALLATION STANDARDS - LIGHTNING PROTECTION LIGHTNING CONDUCTOR, STRIP, ON FLAT SURFACE WITH CONDUCTOR HOLDER (LPC6)

1	2	3	4		
ITEM	DESCRIPTION	MATERIAL	QTY.	SUPPLY BY	INSTALLATION BY
1	LIGHTNING CONDUCTOR, STRIP, 25X3mm	HDGI	AS REQUIRED	ELECTRICAL CONTRACTOR	ELECTRICAL CONTRACTOR

VIEW-A

VIEW-A

DRAWING NOT TO SCALE


NOTES:

- 1) ALL DIMENSIONS ARE IN 'mm' UNLESS OTHERWISE SPECIFIED.
- 2) DURING ENGINEERING CIVIL SHALL BE INFORMED ABOUT THE ARRANGEMENT IN ORDER TO SELECT LONGER LENGTH OF J-BOLT.

Code		Contract No.		Document ID		Part		Rev.	
00	02/01/17	KRP	MLD	02/01/17	RPM	02/01/17	RPM	PIN-LEP-ELT-4004	
Rev.	Date	Name	Date	Name	Date	Name	Description	Acc. Code	Status
		Drawn/Prepared		Checked		Approved			

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Pro. Unit	TON	Group	Type of Document	Sheet	1 / 1
Con. Unit	Scale	Order No.			
NTS					


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02/01/17	KRP	INSTALLATION STANDARDS - LIGHTNING PROTECTION LIGHTNING CONDUCTOR, STRIP, ON CORRUGATED ROOF (LPC7)
02/01/17	MLD	
02/01/17	RPM	
02/01/17	RPM	

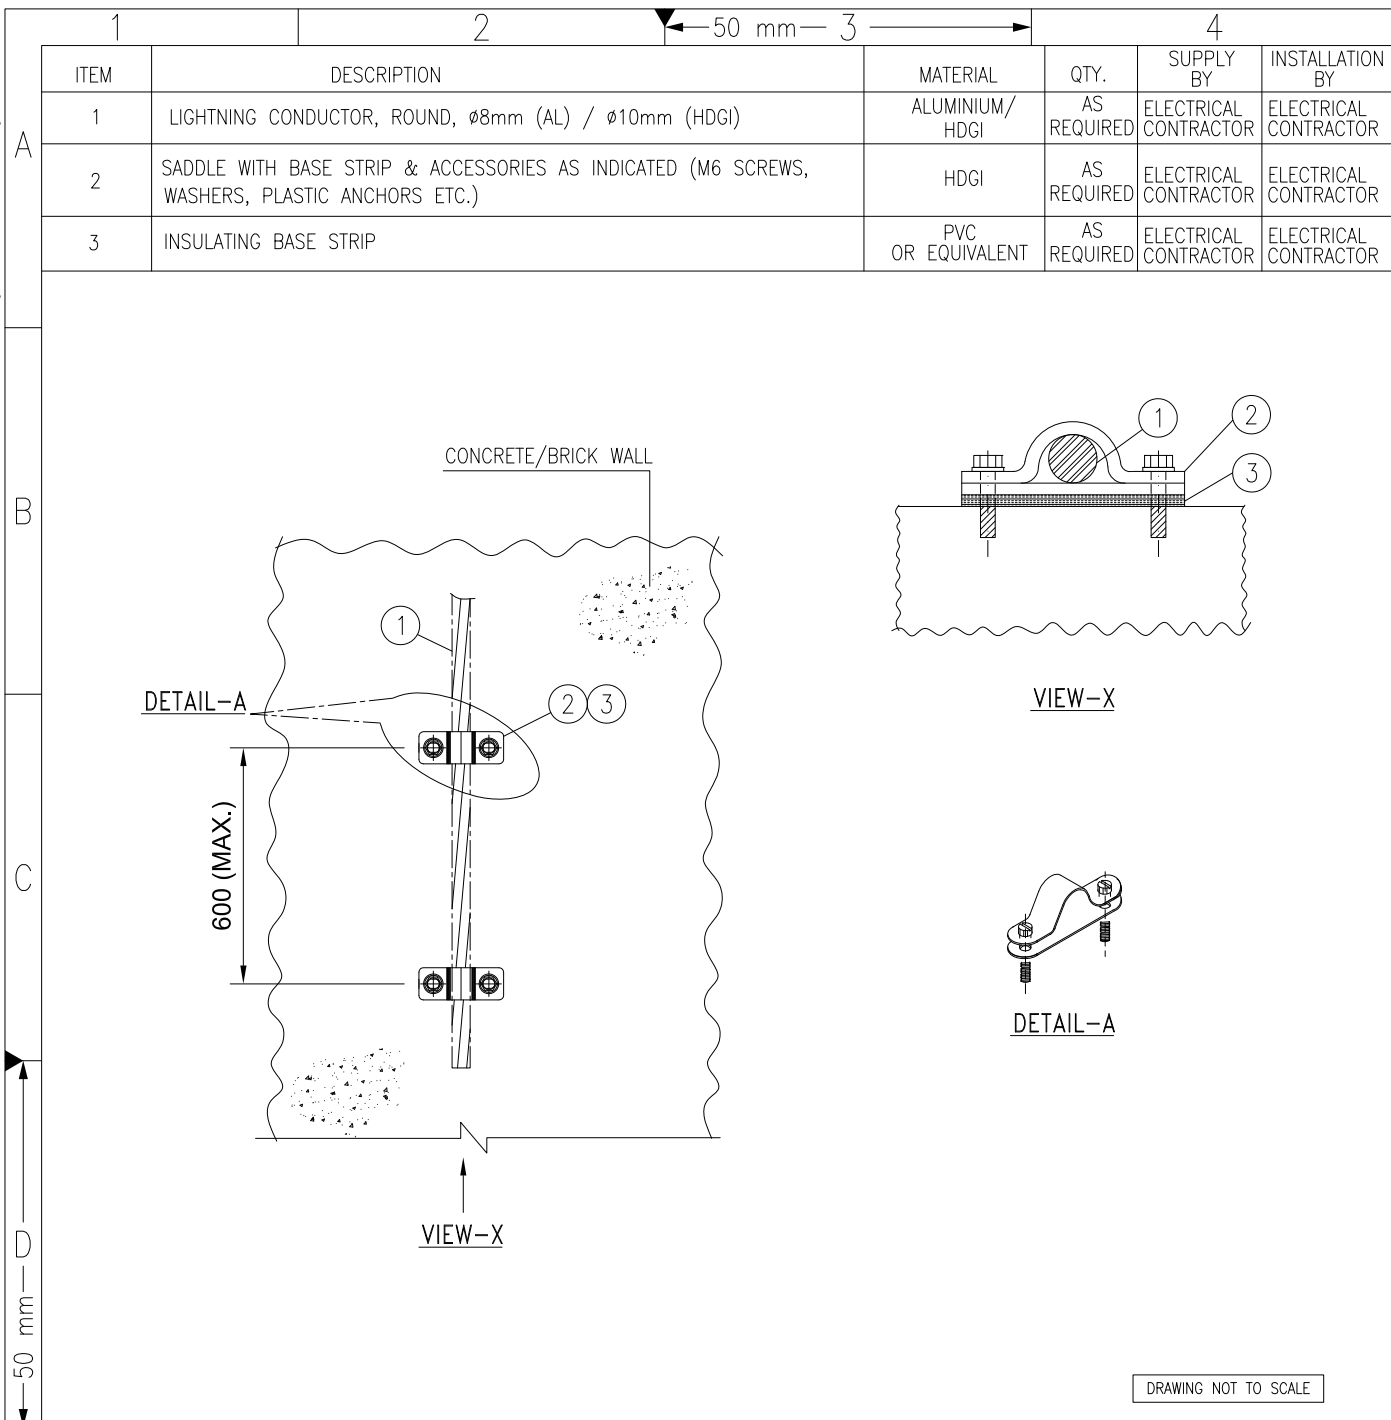


DRAWING NOT TO SCALE

NOTE:

1) ALL DIMENSIONS ARE IN 'mm' UNLESS OTHERWISE SPECIFIED.

Code			Contract No.			Document ID			PIN-LEP-ELT-4004			Part		Rev.	
00	02/01/17	KRP	MLD	02/01/17	RPM	02/01/17	RPM	ISSUED AS STANDARD				Cat. Code	Acc. Code	Status	
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BAR-Code										Store Location: Server/Share					
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										NTS					
		Date		Name						Description					
Drawn		02/01/17		KRP						INSTALLATION STANDARDS –					
Prepared		02/01/17		MLD						LIGHTNING PROTECTION					
Checked		02/01/17		RPM						LIGHTNING DOWN CONDUCTOR ON WALL					
Approved		02/01/17		RPM						WITH SADDLE/CLAMP (LPD1)					


A	1		2		50 mm		3		4	
	ITEM	DESCRIPTION				MATERIAL		QTY.	SUPPLY BY	INSTALLATION BY
	1	LIGHTNING CONDUCTOR, ROUND, $\phi 8\text{mm}$ (AL) / $\phi 10\text{mm}$ (HDGI)				ALUMINIUM/ HDGI		AS REQUIRED	ELECTRICAL CONTRACTOR	ELECTRICAL CONTRACTOR
	2	CONDUCTOR HOLDER FOR ROUND CONDUCTOR UP TO $\phi 10\text{mm}$ WITH FEMALE THREAD & THROUGH HOLE FOR SCREWS				POLYAMIDE OR EQUIVALENT		AS REQUIRED	ELECTRICAL CONTRACTOR	ELECTRICAL CONTRACTOR
	3	ACCESSORIES TO FIX CONDUCTOR HOLDER TO WALL (SCREW, PLASTIC ANCHOR ETC.)				HDGI		AS REQUIRED	ELECTRICAL CONTRACTOR	ELECTRICAL CONTRACTOR

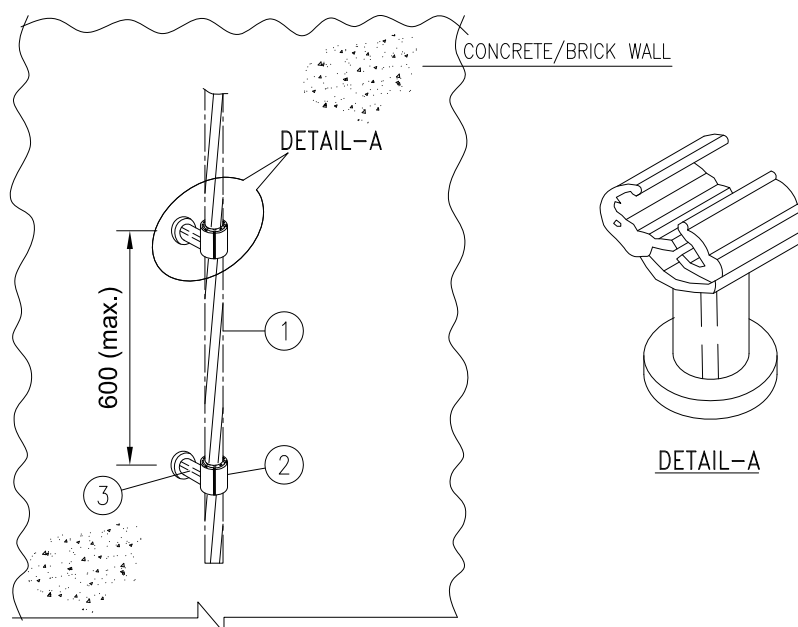

DRAWING NOT TO SCALE

NOTES:



- 1) ALL DIMENSIONS ARE IN 'mm' UNLESS OTHERWISE SPECIFIED.
- 2) DETAILS OF SCREW (M6 OR M8 ETC.) SHALL BE DECIDED AT SITE BASED ON ACTUAL REQUIREMENT OF ITEM NO. 2

Code			Contract No.				Document ID				PIN-LEP-ELT-4004			Part		Rev. 00	
00	02/01/17	KRP	MLD	02/01/17	RPM	02/01/17	RPM	ISSUED AS STANDARD				Cat. Code	Acc. Code	Status			
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				NTS													
	Date	Name								Description							
Drawn	02/01/17	KRP								INSTALLATION STANDARDS -							
Prepared	02/01/17	MLD								LIGHTNING PROTECTION							
Checked	02/01/17	RPM								LIGHTNING DOWN CONDUCTOR ON WALL							
Approved	02/01/17	RPM								WITH CONDUCTOR HOLDER (LPD2)							

ISO A4

	Date	Name
Drawn	02/01/17	KRP
Prepared	02/01/17	MLD
Checked	02/01/17	RPM
Approved	02/01/17	RPM

ITEM	DESCRIPTION	MATERIAL	QTY.	SUPPLY BY	INSTALLATION BY
1	LIGHTNING CONDUCTOR, STRIP, 25X3mm	HDGI	AS REQUIRED	ELECTRICAL CONTRACTOR	ELECTRICAL CONTRACTOR
2	CONDUCTOR HOLDER FOR STRIP CONDUCTOR UP TO 30X3.5mm WITH INSULATED BASE (PLASTIC) & THROUGH HOLE FOR SCREWS	HDGI	AS REQUIRED	ELECTRICAL CONTRACTOR	ELECTRICAL CONTRACTOR
3	ACCESSORIES TO FIX CONDUCTOR HOLDER TO FLAT SURFACE (SCREW, PLASTIC ANCHOR ETC.)	HDGI	AS REQUIRED	ELECTRICAL CONTRACTOR	ELECTRICAL CONTRACTOR

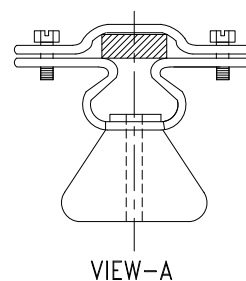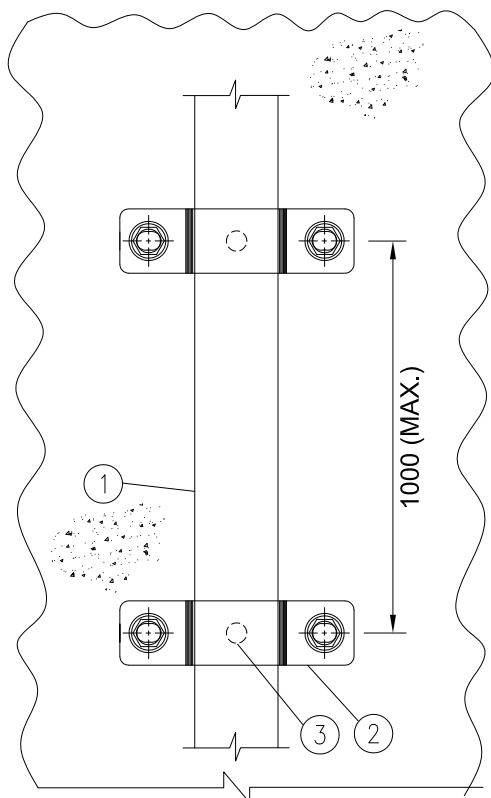

VIEW-A

DRAWING NOT TO SCALE

NOTES:

- 1) ALL DIMENSIONS ARE IN 'mm' UNLESS OTHERWISE SPECIFIED.
- 2) DETAILS OF SCREW (M6 OR M8 ETC.) SHALL BE DECIDED AT SITE BASED ON ACTUAL REQUIREMENT OF ITEM NO. 2

Code		Contract No.		Document ID				Part		Rev.																	
				PIN-LEP-ELT-4004						00																	
00	02/01/17	KRP	MLD	02/01/17	RPM	02/01/17	RPM	ISSUED AS STANDARD		Cat. Code	Acc. Code	Status															
Rev.	Date	Name		Date	Name	Date	Name	Description	Acc. Code																		
Drawn/Prepared			Checked			Approved																					
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Con. Unit				Scale		Order No.																					
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	Date	Name																									
Drawn	02/01/17	KRP																									
Prepared	02/01/17	MLD																									
Checked	02/01/17	RPM																									
Approved	02/01/17	RPM																									

ISO A4

1	2	3	4		
ITEM	DESCRIPTION	MATERIAL	QTY.	SUPPLY BY	INSTALLATION BY
1	LIGHTNING CONDUCTOR, ROUND, $\phi 8\text{mm}$ (AL) / $\phi 10\text{mm}$ (HDGI) / FLAT STRIP CONDUCTOR UP TO $30 \times 3.5\text{mm}$	ALUMINIUM / HDGI	AS REQUIRED	ELECTRICAL CONTRACTOR	ELECTRICAL CONTRACTOR
2	ATTACHMENT CLAMP FOR ROUND CONDUCTOR UP TO $\phi 10\text{mm}$ AND FOR FLANGE THICKNESS UP TO 20mm / FLAT STRIP CONDUCTOR UP TO $30 \times 3.5\text{mm}$	HDGI	AS REQUIRED	ELECTRICAL CONTRACTOR	ELECTRICAL CONTRACTOR

STEEL COLUMN

1000 (MAX.)

DETAIL-A
DETAIL-B

DETAIL-A
(WITH ROUND CONDUCTOR)

DETAIL-B
(WITH FLAT STRIP CONDUCTOR)

DRAWING NOT TO SCALE

NOTES:

1) ALL DIMENSIONS ARE IN 'mm' UNLESS OTHERWISE SPECIFIED.

2) LENGTH OF BOLT REQUIRED FOR OF FLAT STRIP CONDUCTOR SHALL BE VERIFIED AT SITE.

Code		Contract No.		Document ID				Part		Rev.		
				PIN-LEP-ELT-4004						00		
00	02/01/17	KRP	MLD	02/01/17	RPM	02/01/17	RPM	ISSUED AS STANDARD		Cat. Code	Acc. Code	Status
Rev.	Date	Name		Date	Name	Date	Name	Description	Acc. Code			
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Pro. Unit	TON	Group	Type of Document
Con. Unit	Scale	Order No.	Sheet
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ISO A4		Date	Name	Description INSTALLATION STANDARDS – LIGHTNING PROTECTION LIGHTNING DOWN CONDUCTOR ON STEEL COLUMN WITH ATTACHMENT CLAMP (LPD4)
	Drawn	02/01/17	KRP	
	Prepared	02/01/17	MLD	
	Checked	02/01/17	RPM	
	Approved	02/01/17	RPM	

A	1		2		50 mm		3		4	
	ITEM	DESCRIPTION				MATERIAL	QTY.	SUPPLY BY	INSTALLATION BY	
	1	TEST JOINT SUITABLE FOR FOLLOWING COMBINATION OF LIGHTNING CONDUCTORS ALONG WITH FIXING SCREWS A) ROUND, $\varnothing 8\text{mm}/\varnothing 10\text{mm}$ TO ROUND, $\varnothing 8\text{mm}/\varnothing 10\text{mm}$ B) ROUND, $\varnothing 8\text{mm}/\varnothing 10\text{mm}$ TO FLAT STRIP 30X3.5mm C) FLAT STRIP 30X3.5mm TO FLAT STRIP 30X3.5mm				HDGI	1 NO.	ELECTRICAL CONTRACTOR	ELECTRICAL CONTRACTOR	
	2	ANTI-CORROSIVE TAPE OVER TEST JOINT				BITUMEN CONTENT FABRIC OR EQUIVALENT	AS REQUIRED	ELECTRICAL CONTRACTOR	ELECTRICAL CONTRACTOR	

B

C

DOWN CONDUCTOR FROM ROOF TOP


(2) (1)

Detail-A

CONDUCTOR TO EARTHING GRID

1200

FFL

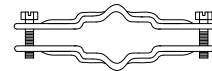

DETAIL-A

DRAWING NOT TO SCALE


NOTE:

1) ALL DIMENSIONS ARE IN 'mm' UNLESS OTHERWISE SPECIFIED.

Code		Contract No.		Document ID				Part		Rev.		
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00	02/01/17	KRP	MLD	02/01/17	RPM	02/01/17	RPM	ISSUED AS STANDARD		Cat. Code	Acc. Code	Status
Rev.	Date	Name		Date	Name	Date	Name	Description	Acc. Code			
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Con. Unit				Scale		Order No.						
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Date Drawn 02/01/17 KRP Prepared 02/01/17 MLD Checked 02/01/17 RPM Approved 02/01/17 RPM								Description INSTALLATION STANDARDS - LIGHTNING PROTECTION TEST JOINT (LPJ1)				

ISO A4

A	1		2		3		4	
			← 50 mm →					
	ITEM	DESCRIPTION			MATERIAL	QTY.	SUPPLY BY	INSTALLATION BY
	1	AIR TERMINATION ROD WITH SUITABLE THREADING FOR STAND & CONNECTING TAB FITTED WITH CONNECTOR SUITABLE FOR ROUND CONDUCTOR UP TO $\phi 10\text{mm}$ L = XXXX mm (REFER NOTE-1)			HDGI	1 NO.	ELECTRICAL CONTRACTOR	ELECTRICAL CONTRACTOR
2	STAND WITH SUITABLE FEMALE THREADS			CONCRETE	1 NO.	ELECTRICAL CONTRACTOR	ELECTRICAL CONTRACTOR	

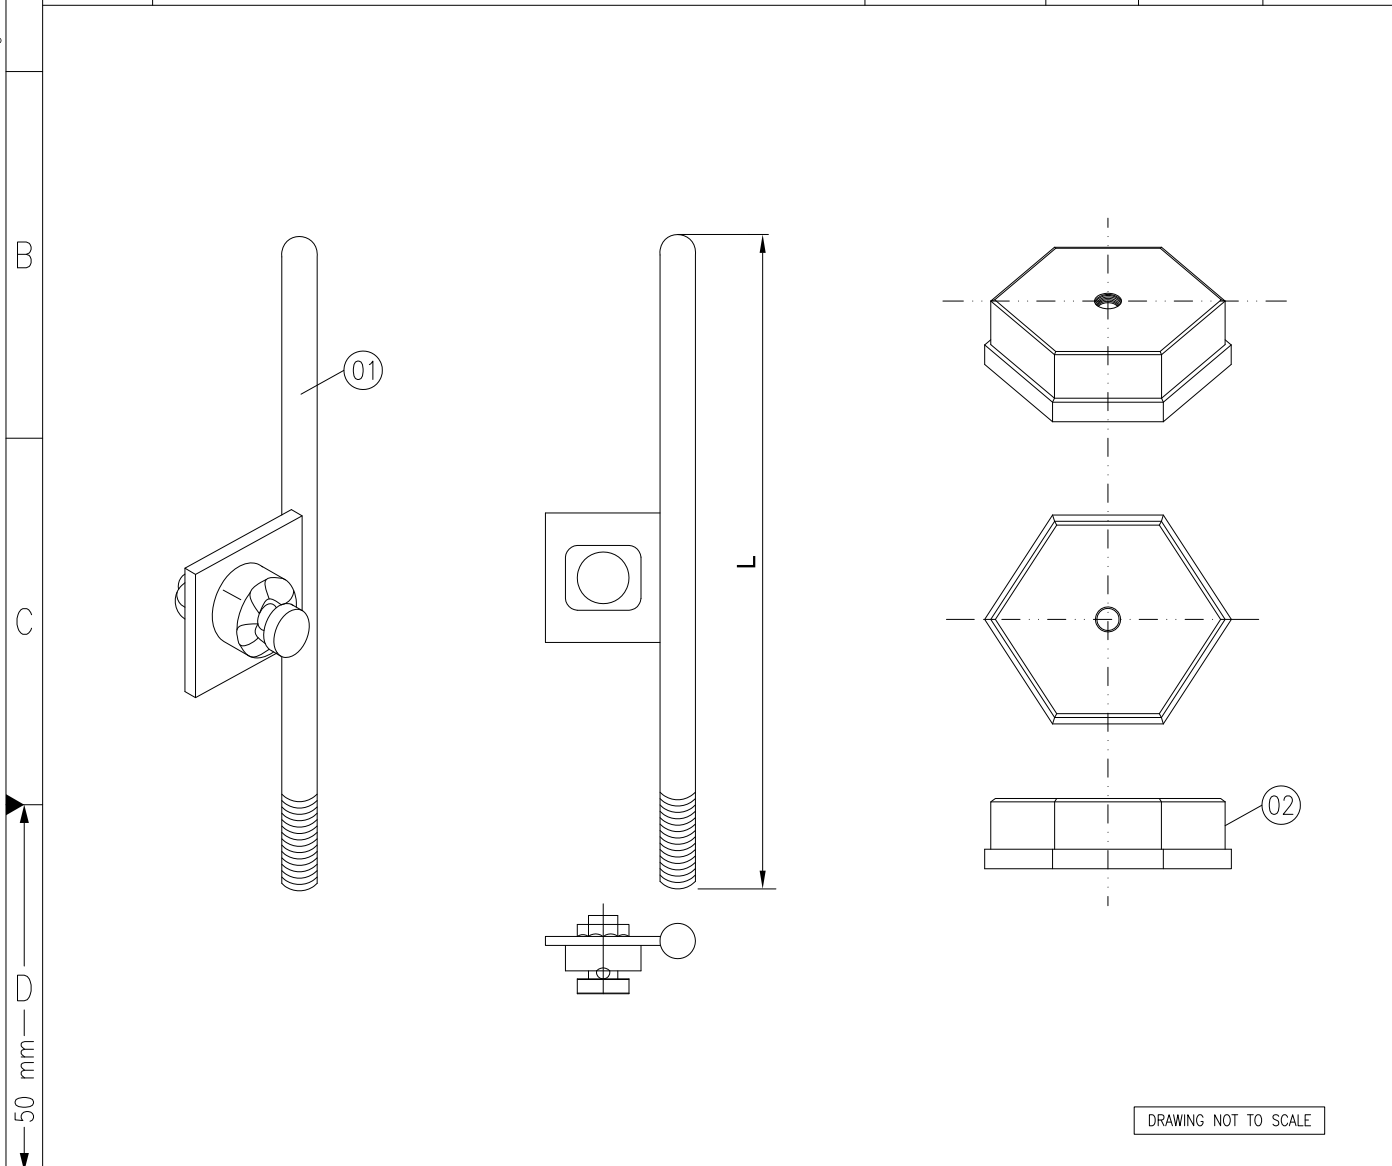


NOTES:

- 1) LENGTH OF AIR TERMINATION ROD SHALL BE MAX. 1500mm.
- 2) STAND SHALL BE SECURED PROPERLY TO BASE

Code		Contract No.		Document ID		Part		Rev.	
00		02/01/17 KRP		PIN-LEP-ELT-4004				00	
Rev.	Date	Name	Date	Name	Date	Name	Description	Acc. Code	Status
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Date		Name		Description					
02/01/17		KRP		INSTALLATION STANDARDS -					
02/01/17		MLD		LIGHTNING PROTECTION					
02/01/17		RPM		SELF STANDING AIR TERMINATION ROD					
02/01/17		RPM		(LPR1)					

A	1	2	← 50 mm → 3	4		
	ITEM	DESCRIPTION	MATERIAL	QTY.	SUPPLY BY	INSTALLATION BY
	1	AIR TERMINATION ROD WITH AIR TERMINATION TIP, L = xxxx mm WITH PROVISION TO CONNECT HORIZONTAL LIGHTNING CONDUCTOR AT THE THE BOTTOM (REFER NOTE-1)	HDGI	1 NO.	ELECTRICAL CONTRACTOR	ELECTRICAL CONTRACTOR
	2	TRIPOD STAND WITH BRACES/ STRINGS FOR AIR TERMINATION ROD	HDGI	1 NO.	ELECTRICAL CONTRACTOR	ELECTRICAL CONTRACTOR
	3	CONCRETE BASE WITH SUITABLE WEIGHT (REFER NOTE-2)	CONCRETE	3 SETS	ELECTRICAL CONTRACTOR	ELECTRICAL CONTRACTOR

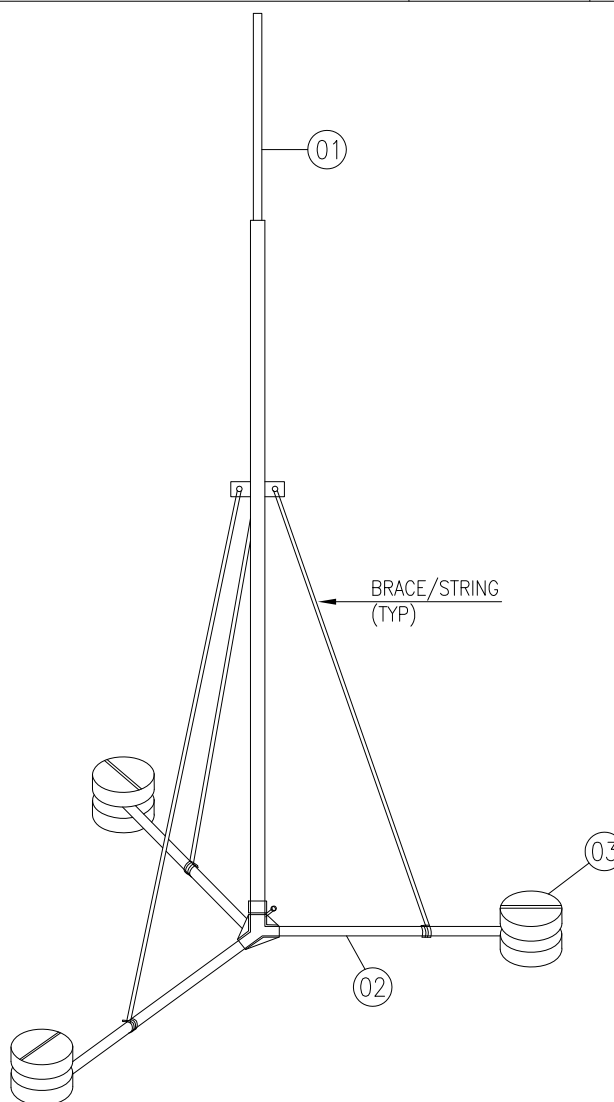

NOTES:

- 1) TRIPOD ARRANGEMENT IS APPLICABLE FOR AIR TERMINATION RODS HAVING LENGTH 4000-14000mm. LENGTH SHALL BE DECIDED AS PER PROJECT REQUIREMENT.
- 2) WEIGHT OF CONCRETE BASE VARIES ACCORDING TO LENGTH OF AIR TERMINATION ROD.
- 3) ARRANGEMENT SHALL BE SECURED PROPERLY TO BASE

Code	Contract No.	Document ID	Part	Rev.
00	02/01/17 KRP	MLD	02/01/17 RPM	02/01/17 RPM
ISSUED AS STANDARD		Cat. Code	Acc. Code	Status
Rev.	Date	Name	Date	Name
Drawn/Prepared	Checked	Approved		

BAR-Code


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Store Location: Folder

Store Name LPR2

Pro. Unit	TON	Group	Type of Document	Sheet
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Con. Unit	Scale	Order No.	
	NTS		



	Date	Name
Drawn	02/01/17	KRP
Prepared	02/01/17	MLD
Checked	02/01/17	RPM
Approved	02/01/17	RPM

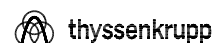Description
INSTALLATION STANDARDS –
LIGHTNING PROTECTION
AIR TERMINATION ROD WITH TRIPOD
ARRANGEMENT (LPR2)

1	2	3	4	5	6
ITEM	DESCRIPTION	MATERIAL	QTY.	SUPPLY BY	INSTALLATION BY
1	AIR TERMINATION ROD, ROUND HEADED ON TOP L = XXXX mm (REFER NOTE-3)	HDGI	1 NO.	ELECTRICAL CONTRACTOR	ELECTRICAL CONTRACTOR
2	150 x 150 x 6 THICK PLATE	MS PAINTED	1 NO.	ELECTRICAL CONTRACTOR	ELECTRICAL CONTRACTOR

VIEW-A

VIEW-A

DRAWING NOT TO SCALE

NOTES :-

- 1) ALL DIMENSIONS ARE IN mm UNLESS OTHERWISE SPECIFIED.
- 2) ALL WELDED JOINTS SHALL BE PAINTED WITH BITUMINOUS PAINT.
- 3) LENGTH OF AIR TERMINATION ROD SHALL BE MAX. 1500mm.

Code		Contract No.		Document ID		Part		Rev.	
00	02/01/17	KRP	MLD	02/01/17	RPM	02/01/17	RPM	PIN-LEP-ELT-4004	00
Rev.	Date	Name	Date	Name	Date	Name	Description	Acc. Code	Status
		Drawn/Prepared		Checked		Approved			

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		Store Name LPR3	
Pro. Unit	TON	Group	Type of Document
Con. Unit	Scale	Order No.	Sheet 1 / 1
NTS			

ISO A4	Date	Name	Description
Drawn	02/01/17	KRP	INSTALLATION STANDARDS – LIGHTNING PROTECTION AIR TERMINATION ROD ON STEEL STRUCTURE (LPR3)
Prepared	02/01/17	MLD	
Checked	02/01/17	RPM	
Approved	02/01/17	RPM	

1	2	3	4	5	6
ITEM	DESCRIPTION	MATERIAL	QTY.	SUPPLY BY	INSTALLATION BY
1	AIR TERMINATION ROD, ROUND HEADED ON TOP L = XXXX mm (REFER NOTE-3)	HDGI	1 NO.	ELECTRICAL CONTRACTOR	ELECTRICAL CONTRACTOR
2	150 x 150 x 6 THICK PLATE	MS PAINTED	1 NO.	ELECTRICAL CONTRACTOR	ELECTRICAL CONTRACTOR
3	ANCHOR FASTNER M10x50 LONG WITH SUITABLE NUT AND WASHER	HDGI	4 NOS.	ELECTRICAL CONTRACTOR	ELECTRICAL CONTRACTOR

VIEW-A

PLAN

VIEW-A

DRAWING NOT TO SCALE

NOTES :-

1) ALL DIMENSIONS ARE IN mm UNLESS OTHERWISE SPECIFIED.

2) ALL WELDED JOINTS SHALL BE PAINTED WITH BITUMINOUS PAINT.


3) LENGTH OF AIR TERMINATION ROD SHALL BE MAX. 1500mm.

Code		Contract No.		Document ID				Part		Rev.		
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00	02/01/17	KRP	MLD	02/01/17	RPM	02/01/17	RPM	ISSUED AS STANDARD		Cat. Code	Acc. Code	Status
Rev.	Date	Name		Date	Name	Date	Name	Description	Acc. Code			
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				Pro. Unit	TON	Group	Type of Document	Sheet
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				NTS				

ISO A4		Date	Name	Description INSTALLATION STANDARDS – LIGHTNING PROTECTION AIR TERMINATION ROD ON ON CONCRETE SURFACE (LPR4)
	Drawn	02/01/17	KRP	
	Prepared	02/01/17	MLD	
	Checked	02/01/17	RPM	
	Approved	02/01/17	RPM	

A	1		2		50 mm		3		4	
	ITEM	DESCRIPTION				MATERIAL		QTY.	SUPPLY BY	INSTALLATION BY
	1	AIR TERMINATION ROD, ROUND HEADED ON TOP L = XXXX mm (REFER NOTE-4)				HDGI		1 NO.	ELECTRICAL CONTRACTOR	ELECTRICAL CONTRACTOR
	2	150 x 150 x 6 THICK CHANNEL				MS PAINTED		600mm	ELECTRICAL CONTRACTOR	ELECTRICAL CONTRACTOR
	3	SADDLE/ CLAMP WITH ACCESSORIES SUCH AS NUT, BOLT & WASHERS				HDGI		2 SETS	ELECTRICAL CONTRACTOR	ELECTRICAL CONTRACTOR

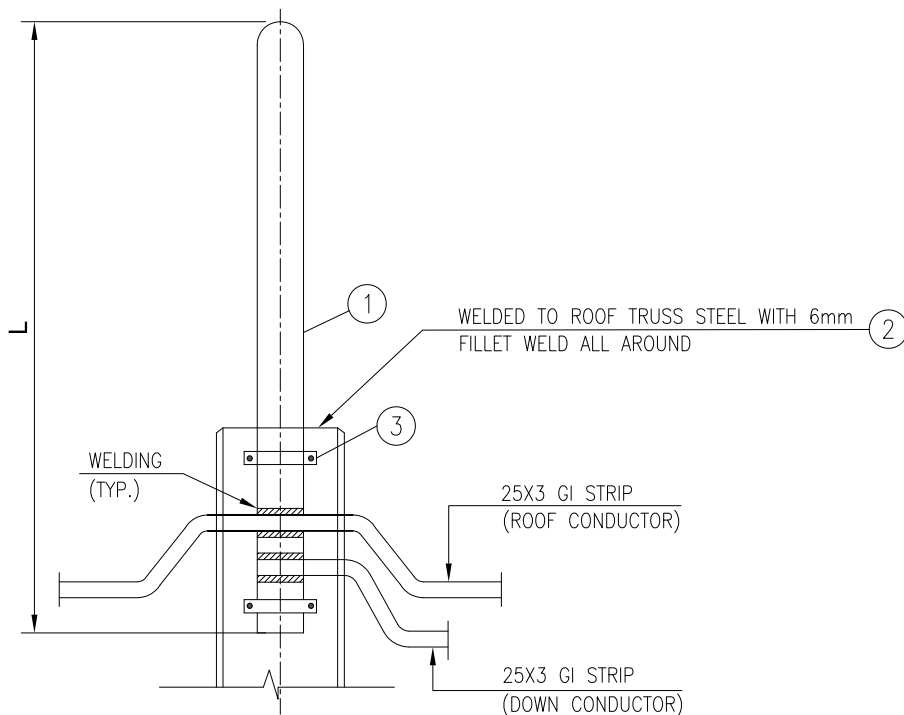





NOTES :-

- 1) ALL DIMENSIONS ARE IN mm UNLESS OTHERWISE SPECIFIED.
- 2) ALL WELDED JOINTS SHALL BE PAINTED WITH BITUMINOUS PAINT.
- 3) ROOF SHALL BE SEALED WITH WEATHER PROOF COMPOUND AFTER INSTALLATION OF AIR TERMINATION ROD.
- 4) LENGTH OF AIR TERMINATION ROD SHALL BE MAX. 1500mm.




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Rev.	Date	Name	Date	Name	Date	Name	Description	Acc. Code	Status
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							Store Location: Folder		
							Store Name LPR5		
							Pro. Unit	TON	Group
							Type of Document	Sheet	1 / 1
							Con. Unit	Scale	Order No.
							NTS		
							thyssenkrupp		
							Description		
							INSTALLATION STANDARDS -		
							LIGHTNING PROTECTION		
							AIR TERMINATION ROD		
							ON ROOF TRUSS (LPR5)		

ISO A4

	Date	Name
Drawn	02/01/17	KRP
Prepared	02/01/17	MLD
Checked	02/01/17	RPM
Approved	02/01/17	RPM

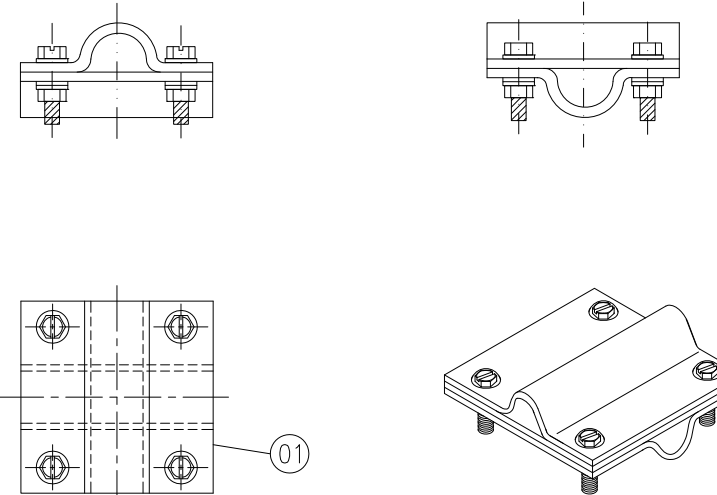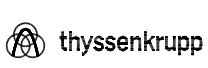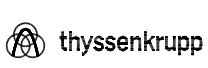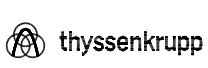1		2				3		4																																																																															
ITEM	DESCRIPTION					MATERIAL	QTY.	SUPPLY BY	INSTALLATION BY																																																																														
1	CROSS CONNECTOR TO FIT ROUND CONDUCTOR UP TO $\phi 10\text{mm}$ / FLAT STRIP UP TO $30 \times 3.5\text{mm}$ WITH 4 HEXAGON HEAD SCREWS.					HDGI	1 NO.	ELECTRICAL CONTRACTOR	ELECTRICAL CONTRACTOR																																																																														
A	<div style="display: flex; justify-content: space-around; align-items: center;">  </div>																																																																																						
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<p>NOTE:</p> <p>1) ALL DIMENSIONS ARE IN 'mm' UNLESS OTHERWISE SPECIFIED.</p>																																																																																							
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Drawn/Prepared				Checked				Approved																																																																															
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Approved	02/01/17	RPM																																																																																					

A	1		2		3		4	
	ITEM	DESCRIPTION			MATERIAL	QTY.	SUPPLY BY	INSTALLATION BY
	1	EXPANSION PIECE			HDGI	1 NO.	ELECTRICAL CONTRACTOR	ELECTRICAL CONTRACTOR
	2	PARALLEL CONNECTOR SUITABLE FOR ROUND CONDUCTOR UP TO $\phi 10\text{mm}$			HDGI	2 NOS.	ELECTRICAL CONTRACTOR	ELECTRICAL CONTRACTOR

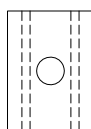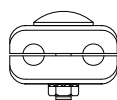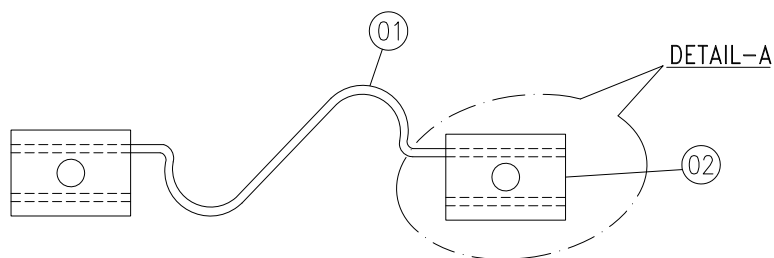


DETAIL-A

DRAWING NOT TO SCALE

NOTE:


1) ALL DIMENSIONS ARE IN 'mm' UNLESS OTHERWISE SPECIFIED.


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Rev.	Date	Name		Date	Name		Date	Name		Description		Acc. Code							
		Drawn/Prepared				Checked				Approved									
BAR-Code												Store Location: Server/Share							
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												Store Name LP12							
								Pro. Unit		TON		Group		Type of Document		Sheet 1 / 1			
								Con. Unit		Scale		Order No.		 thyssenkrupp					
										NTS									

ISO A4

	Date	Name	Description
Drawn	02/01/17	KRP	INSTALLATION STANDARDS – LIGHTNING PROTECTION CROSS CONNECTOR/ T-CONNECTOR (LPT2)
Prepared	02/01/17	MLD	
Checked	02/01/17	RPM	
Approved	02/01/17	RPM	

1	2	3	4		
ITEM	DESCRIPTION	MATERIAL	QTY.	SUPPLY BY	INSTALLATION BY
1	PARALLEL CONNECTOR SUITABLE FOR ROUND CONDUCTOR UP TO $\phi 10\text{mm}$	HDGI	1 NO.	ELECTRICAL CONTRACTOR	ELECTRICAL CONTRACTOR

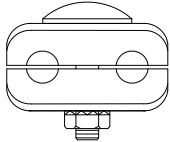

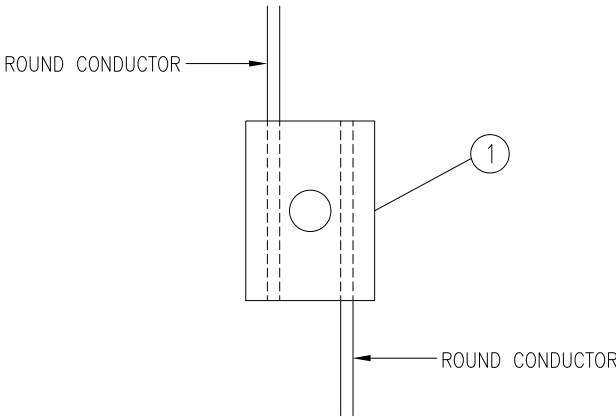

ROUND CONDUCTOR

ROUND CONDUCTOR

DRAWING NOT TO SCALE

NOTE:

1) ALL DIMENSIONS ARE IN 'mm' UNLESS OTHERWISE SPECIFIED.


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				PIN-LEP-ELT-4004						00		
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Rev.	Date	Name		Date	Name	Date	Name	Description		Acc. Code		
		Drawn/Prepared			Checked		Approved					

BAR-Code

Store Location: Server/Share

Store Location: Folder



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


Pro. Unit	TON	Group	Type of Document	Sheet	1 / 1
Con. Unit	Scale	Order No.	 thyssenkrupp		
NTS					

	Date	Name
Drawn	02/01/17	KRP
Prepared	02/01/17	MLD
Checked	02/01/17	RPM
Approved	02/01/17	RPM



Description

INSTALLATION STANDARDS –
LIGHTNING PROTECTION
PARALLEL CONNECTOR (LPT3)

 		INSTALLATION STANDARDS - LIGHTNING PROTECTION LIGHTNING PROTECTION SCHEDULE	Code		NAL	
			Contract No.		66-6695	
			Doc.		LSCH	
			Rev. No.		0	Page No. 1 of 1
	Sr. No.	Type of Conductor	Lightning Conductor Size & Type			
	1	Roof conductor (Flat surface & corrugated Sheet)	Round, Ø10mm (HDGI) / Flat (Strip), 25x3mm (HDGI)			
	2	Down Conductor	Round, Ø10mm (HDGI) / Flat (Strip), 25x3mm (HDGI)			
	3	Conductor after test joint towards earthing grid	Round, Ø10mm (HDGI) / Flat (Strip), 25x3mm (HDGI)			

Plant 1.0 MTPA ALUMINA REFINERY STREAM-5	Client NALCO	Contract Code NAL	Document ID 6695-ELT-G00-EC-0027	Contract No. 66-6695
	ELECTRICAL INSTALLATION PART- V - INSTALLATION DETAIL- COMMUNCATION AND PUBLIC ADDRESS			 नालको  NALCO नेशनल एल्युमिनियम कम्पनी लिमिटेड National Aluminium Company Ltd.
				Rev 0 Page 1 of 2


INSTALLATION DETAIL- COMMUNCATION AND PUBLIC ADDRESS

Plant 1.0 MTPA ALUMINA REFINERY STREAM-5	Client NALCO	Contract Code NAL	Document ID 6695-ELT-G00-EC-0027	Contract No. 66-6695		
 thyssenkrupp	ELECTRICAL INSTALLATION PART- V - INSTALLATION DETAIL- COMMUNCATION AND PUBLIC ADDRESS			नालको  NALCO नेशनल एल्युमिनियम कम्पनी लिमिटेड National Aluminium Company Ltd.		
				Rev	0	Page

LIST OF INSTALLATION STANDARDS

Sr. No.	Description	Typical No.	No. of Sheets	Rev
1	Flashing Beacon on wall/ concrete column	CFBC1	1	00
2	Flashing Beacon on railing	CFBR1	1	00
3	Flashing Beacon on steel structure	CFBS1	1	00
4	Horn type loudspeaker on bracket, on wall/ concrete column	CLSC1	1	00
5	Horn type loudspeaker on wall from side	CLSC2	1	00
6	Box type loudspeaker on wall/ concrete column	CLSC3	1	00
7	Loudspeaker concealed in wall/gypsum board/ on false ceiling	CLSF1	1	00
8	Horn type loudspeaker mounted on self standing Pedestal	CLSP1	1	00
9	Horn type loudspeaker on steel structure	CLSS1	1	00
10	Master Control Station on desk/ control panel frame	CMCS1	1	00
11	Telephone / Field call station on wall/ concrete column	CTFC1	1	00
12	Telephone / Field call station on wall/ concrete column with acoustic hood	CTFC2	1	00
13	Telephone/ Field call station set on railing	CTFR1	1	00
14	Telephone/ Field call station set on railing with acoustic hood	CTFR2	1	00
15	Telephone/ Field call station set on steel strcuture	CTFS1	1	00
16	Telephone/ Field call station set on steel structure with acoustic hood	CTFS2	1	00
17	Telephone set on desk/ table/ brick wall	CTFZ1	1	00

1		2		3		4	
ITEM	DESCRIPTION	MATERIAL	QTY.	SUPPLY BY	INSTALLATION BY		
1	FLASHING BEACON	—	1 NO.	CLIENT	ELECTRICAL CONTRACTOR		
2	HEXAGONAL HEAD BOLT M6 X 25mm LONG, THREADS UPTO HEAD, WITH NUTS & WASHERS (REFER NOTE-3)	H.D.G.I.	1 SET	ELECTRICAL CONTRACTOR	ELECTRICAL CONTRACTOR		
3	ISA 75 (75 x 75 x 6mm)	M.S. PAINTED	AS REQUIRED	(REFER NOTE-3 & 4)			
4	ANCHOR FASTENER M6 x 50mm LONG WITH SUITABLE NUT & WASHER	GALVANISED STEEL / SS	1 SET	ELECTRICAL CONTRACTOR	ELECTRICAL CONTRACTOR		

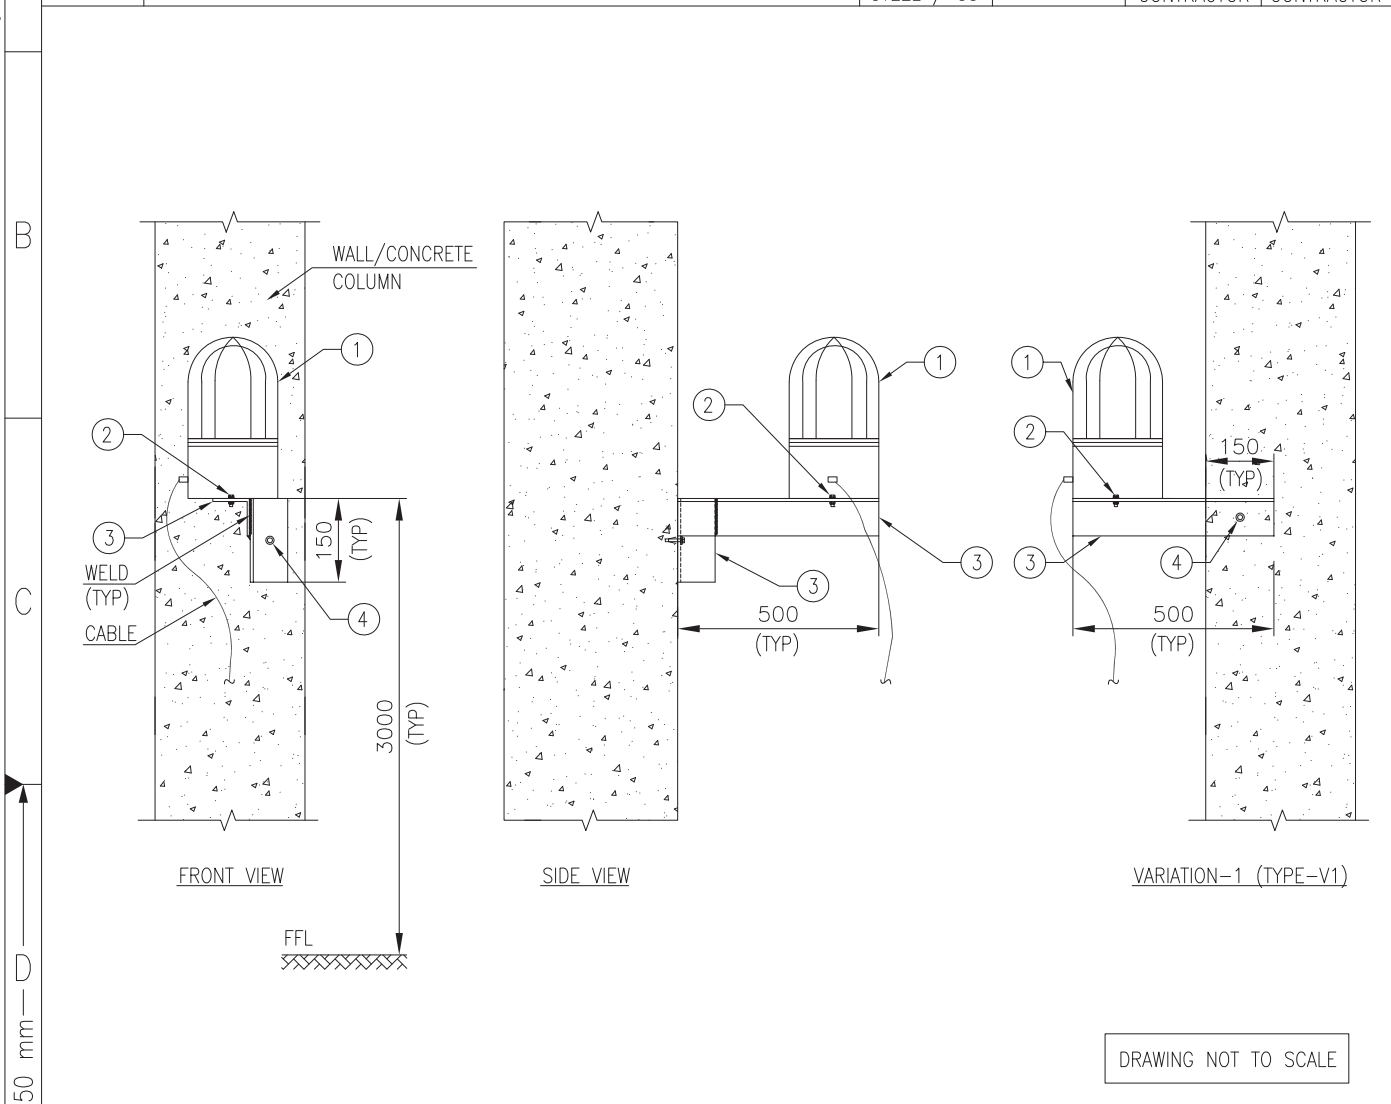


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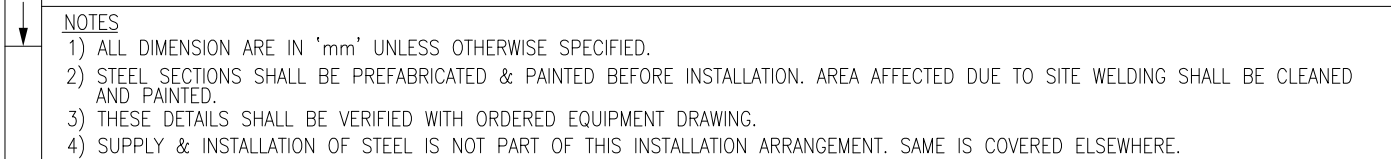
- 1) ALL DIMENSION ARE IN 'mm' UNLESS OTHERWISE SPECIFIED.
- 2) STEEL SECTIONS SHALL BE PREFABRICATED & PAINTED BEFORE INSTALLATION. AREA AFFECTED DUE TO SITE WELDING SHALL BE CLEANED AND PAINTED.
- 3) THESE DETAILS SHALL BE VERIFIED WITH ORDERED EQUIPMENT DRAWING.
- 4) SUPPLY & INSTALLATION OF STEEL IS NOT PART OF THIS INSTALLATION ARRANGEMENT. SAME IS COVERED ELSEWHERE.


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F

ISO A4

Code			Contract No.				Document ID				PIN-LEP-ELT-4010				Part		Rev.	
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Rev.	Date	Name		Date	Name	Date	Name	Description			Acc. Code							
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											Store Location: Folder							
											Store Name CFBC1							
Pro. Unit		TON			Group		Type of Document			Sheet 1 / 1								
Con. Unit		Scale		Order No.			 thyssenkrupp											
		NTS																
	Date	Name		Description														
Drawn	08.09.2017	KRP		INSTALLATION STANDARDS-														
Prepared	08.09.2017	MLD		COMMUNICATION & PA SYSTEM														
Checked	08.09.2017	RPM		FLASHING BEACON ON WALL/CONCRETE														
Approved	08.09.2017	RPM		COLUMN (CFBC1)														



F	BAR-Code	Store Location: Server/Share	
		Store Location: Folder	
		Store Name CFBR1	
		Pro. Unit TON	Group Type of Document Sheet 1 / 1
		Con. Unit Scale NTS	Order No.  thyssenkrupp

ISO A4		Date	Name		Description
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	Prepared	08.09.2017	MLD		COMMUNICATION & PA SYSTEM
	Checked	08.09.2017	RPM		FLASHING BEACON ON RAILING
	Approved	08.09.2017	RPM		(CFBR1)

1	2	3	4	5	6
ITEM	DESCRIPTION	MATERIAL	QTY.	SUPPLY BY	INSTALLATION BY
1	FLASHING BEACON	—	1 NO.	CLIENT	ELECTRICAL CONTRACTOR
2	HEXAGONAL HEAD BOLT M6 X 25mm LONG, THREADS UPTO HEAD, WITH NUTS & WASHERS (REFER NOTE-3)	H.D.G.I.	1 SET	ELECTRICAL CONTRACTOR	ELECTRICAL CONTRACTOR
3	ISA 75 (75 x 75 x 6mm)	M.S. PAINTED	AS REQUIRED	(REFER NOTE-3 & 4)	

FRONT VIEW

SIDE VIEW

VARIATION-1 (TYPE-V1)

DRAWING NOT TO SCALE


NOTES

- 1) ALL DIMENSION ARE IN 'mm' UNLESS OTHERWISE SPECIFIED.
- 2) STEEL SECTIONS SHALL BE PREFABRICATED & PAINTED BEFORE INSTALLATION. AREA AFFECTED DUE TO SITE WELDING SHALL BE CLEANED AND PAINTED.
- 3) THESE DETAILS SHALL BE VERIFIED WITH ORDERED EQUIPMENT DRAWING.
- 4) SUPPLY & INSTALLATION OF STEEL IS NOT PART OF THIS INSTALLATION ARRANGEMENT. SAME IS COVERED ELSEWHERE.

Code		Contract No.		Document ID		Part		Rev.	
				PIN-LEP-ELT-4010				00	
00	08.09.2017	KRP	MLD	08.09.2017	RPM	08.09.2017	RPM	ISSUED AS STANDARD	
Rev.	Date	Name		Date	Name	Date	Name	Description	Acc. Code
		Drawn/Prepared			Checked		Approved		


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Pro. Unit	TON	Group	Type of Document
Con. Unit	Scale	Order No.	
		NTS	

Date	Name	Description
Drawn	08.09.2017 KRP	INSTALLATION STANDARDS- COMMUNICATION & PA SYSTEM FLASHING BEACON ON STEEL STRUCTURE (CFBS1)
Prepared	08.09.2017 MLD	
Checked	08.09.2017 RPM	
Approved	08.09.2017 RPM	

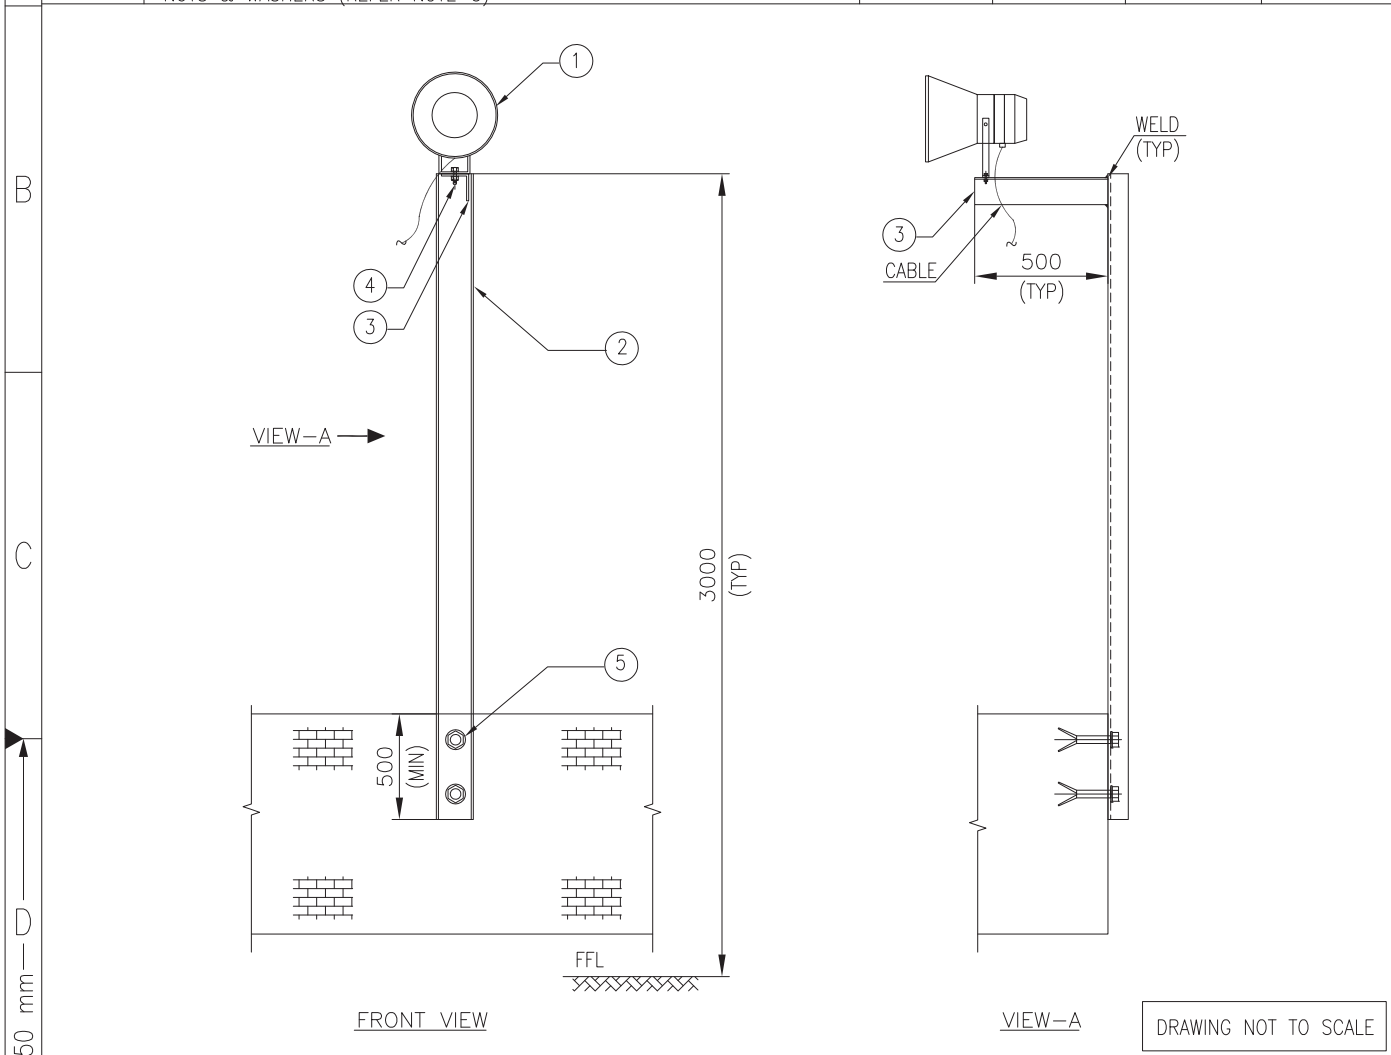


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- 3) THESE DETAILS SHALL BE VERIFIED WITH ORDERED EQUIPMENT DRAWING.
- 4) SUPPLY & INSTALLATION OF STEEL IS NOT PART OF THIS INSTALLATION ARRANGEMENT. SAME IS COVERED ELSEWHERE.

Code			Contract No.			Document ID				Part		Rev.
						PIN-LEP-ELT-4010						00
00	08.09.2017	KRP	MLD	08.09.2017	RPM	08.09.2017	RPM	ISSUED AS STANDARD				
Rev.	Date	Name		Date	Name	Date	Name	Description			Acc. Code	Status
	Drawn/Prepared			Checked		Approved						

BAR-Code	Store Location: Server/Share			
	Store Location: Folder			
	Store Name		CLSC2	
	Pro. Unit	TON	Group	Type of Document
				Sheet 1 / 1
	Con. Unit	Scale	Order No.	 thyssenkrupp
		NTS		

	Date	Name	Description INSTALLATION STANDARDS– COMMUNICATION & PA SYSTEM HORN TYPE LOUDSPEAKER ON WALL, FROM SIDE (CLSC2)
Drawn	08.09.2017	KRP	
Prepared	08.09.2017	MLD	
Checked	08.09.2017	RPM	
Approved	08.09.2017	RPM	

A	1		2		3		4	
	ITEM	DESCRIPTION			MATERIAL	QTY.	SUPPLY BY	INSTALLATION BY
	1	BOX TYPE LOUDSPEAKER			—	1 NO.	CLIENT	ELECTRICAL CONTRACTOR
	2	ACCESSORIES TO FIX LOUDSPEAKER SUCH AS PLASTIC ANCHORS, M6 HDGI SCREWS (REFER NOTE-2)			—	4 SETS	ELECTRICAL CONTRACTOR	ELECTRICAL CONTRACTOR

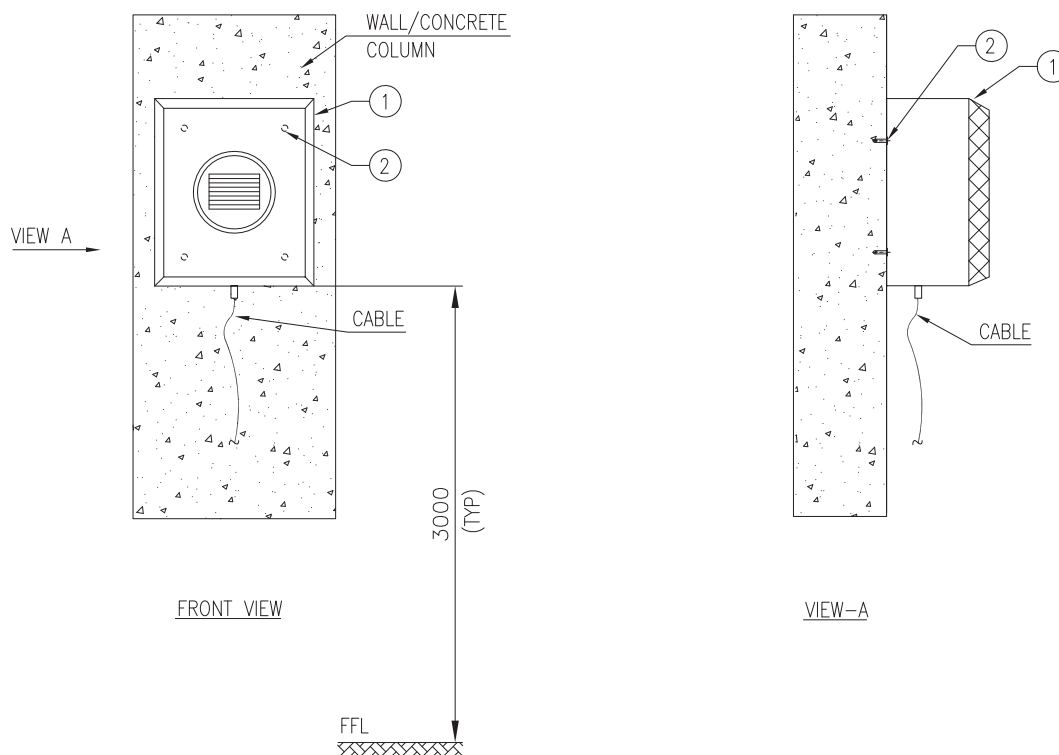

DRAWING NOT TO SCALE

NOTES

- NOTES
- 1) ALL DIMENSION ARE IN 'mm' UNLESS OTHERWISE SPECIFIED.
 - 2) THESE DETAILS SHALL BE VERIFIED WITH ORDERED EQUIPMENT DRAWING.

Code			Contract No.			Document ID				Part		Rev.
						PIN-LEP-ELT-4010						00
00	08.09.2017	KRP	MLD	08.09.2017	RPM	08.09.2017	RPM	ISSUED AS STANDARD				
Rev.	Date	Name		Date	Name	Date	Name	Description			Acc. Code	Status
	Drawn/Prepared			Checked		Approved						

BAR-Code	Store Location: Server/Share			
	Store Location: Folder			
	Store Name		CLSC3	
	Pro. Unit	TON	Group	Type of Document
				Sheet 1 / 1
	Con. Unit	Scale	Order No.	 thyssenkrupp
		NTS		

	Date	Name	Description INSTALLATION STANDARDS- COMMUNICATION & PA SYSTEM BOX TYPE LOUDSPEAKER ON WALL/ CONCRETE COLUMN (CLSC3)
Drawn	08.09.2017	KRP	
Prepared	08.09.2017	MLD	
Checked	08.09.2017	RPM	
Approved	08.09.2017	RPM	

1	2	3	4	5	6
ITEM	DESCRIPTION	MATERIAL	QTY.	SUPPLY BY	INSTALLATION BY
1	LOUDSPEAKER SUITABLE FOR CONCEALED/FALSE CEILING MOUNTING WITH FIXING CLAMPS/ SPRING MOUNTED CLAMPS (REFER NOTE-2)	—	1 NO.	CLIENT	ELECTRICAL CONTRACTOR

BRICK WALL/ GYPSUM BOARD

LOUDSPEAKER CONCEALED IN BRICK WALL/GYPSUM BOARD

LOUDSPEAKER ON FALSE CEILING

DRAWING NOT TO SCALE

NOTES

1) ALL DIMENSION ARE IN 'mm' UNLESS OTHERWISE SPECIFIED.

2) HARDWARE REQUIRED FOR INSTALLATION OF SPEAKER SHALL BE SUPPLIED & INSTALLED BY ELECTRICAL CONTRACTOR.

Code		Contract No.		Document ID				Part		Rev.	
				PIN-LEP-ELT-4010						00	
00	08.09.2017	KRP	MLD	08.09.2017	RPM	08.09.2017	RPM	ISSUED AS STANDARD		Cat. Code	Acc. Code
Rev.	Date	Name		Date	Name	Date	Name	Description		Acc. Code	Status
Drawn/Prepared			Date		Checked		Approved				

BAR-Code

Store Location: Server/Share

Store Location: Folder

Store Name
CLSF1

Pro. Unit: TON Group: Type of Document: Sheet: 1 / 1


Con. Unit: Scale: Order No.: **thyssenkrupp**

NTS

	Date	Name	Description
Drawn	08.09.2017	KRP	INSTALLATION STANDARDS COMMUNICATION & PA SYSTEM LOUDSPEAKER CONCEALED IN WALL/GYPSUM BAORD/ ON FALSE CEILING (CLSF1)
Prepared	08.09.2017	MLD	
Checked	08.09.2017	RPM	
Approved	08.09.2017	RPM	

	1	2	←50 mm→3	4	
A	ITEM	DESCRIPTION	MATERIAL	QTY.	SUPPLY BY INSTALLATION BY
	1	HORN TYPE LOUDSPEAKER	-	1 NO.	CLIENT ELECTRICAL CONTRACTOR
	2	HEXAGONAL HEAD BOLT M10 X 30mm LONG, THREADS UPTO HEAD, WITH SUITABLE NUTS & WASHERS (REFER NOTE-3)	HDGI	1 SET	ELECTRICAL CONTRACTOR ELECTRICAL CONTRACTOR
	3	ISMC 75	M.S. PAINTED	AS REQUIRED	(REFER NOTE- 4)
	4	ISMC 100	M.S. PAINTED	AS REQUIRED	(REFER NOTE- 4)
	5	M10 x 75 LONG ANCHOR FASTENER WITH SUITABLE NUT & WASHERS	GALVANISED STEEL / SS	4 SETS	ELECTRICAL CONTRACTOR ELECTRICAL CONTRACTOR
	6	150 x 150 x10 THK PLATE	M.S. PAINTED	1 NO.	(REFER NOTE- 4)
	7	200x200x100 (LxWxH)mm PEDESTAL	CONCRETE (GRADE M20)	AS REQUIRED	ELECTRICAL CONTRACTOR ELECTRICAL CONTRACTOR
B					
C	DRAWING NOT TO SCALE				
D	NOTES				
	1) ALL DIMENSION ARE IN ‘mm’ UNLESS OTHERWISE SPECIFIED.				
	2) STEEL SECTIONS SHALL BE PREFABRICATED & PAINTED BEFORE INSTALLATION. AREA AFFECTED DUE TO SITE WELDING SHALL BE CLEANED AND PAINTED.				
	3) THESE DETAILS SHALL BE VERIFIED WITH ORDERED EQUIPMENT DRAWING.				
	4) SUPPLY & INSTALLATION OF STEEL IS NOT PART OF THIS INSTALLATION ARRANGEMENT. SAME IS COVERED ELSEWHERE.				
E	Code	Contract No.	Document ID	PIN-LEP-ELT-4010	Part Rev. 00
	00	08.09.2017 KRP	MLD	08.09.2017 RPM	08.09.2017 RPM
	Rev.	Date Name	Date Name	Date Name	Description Acc. Code Cat. Code Acc. Code Status
		Drawn/Prepared	Checked	Approved	
F	BAR-Code		Store Location: Server/Share		
			Store Location: Folder		
			Store Name CLSP1		
	Pro. Unit	TON	Group	Type of Document	Sheet 1 / 1
	Con. Unit	Scale	Order No.	NTS thyssenkrupp	
ISO A4	Drawn	Date	Name	Description	
	Prepared	08.09.2017	KRP	INSTALLATION STANDARDS-	
	Checked	08.09.2017	MLD	COMMUNICATION & PA SYSTEM	
	Approved	08.09.2017	RPM	HORN TYPE LOUDSPEAKER ON	
				SELF STANDING PEDESTAL (CLSP1)	

A	1	2	← 50 mm → 3	4		
	ITEM	DESCRIPTION	MATERIAL	QTY.	SUPPLY BY	INSTALLATION BY
	1	HORN TYPE LOUDSPEAKER	—	1 NO.	CLIENT	ELECTRICAL CONTRACTOR
	2	ISMC 75	M.S. PAINTED	AS REQUIRED	(REFER NOTE-3)	
	3	HEXAGONAL HEAD BOLT M10 X 30mm LONG THREAD UPTO HEAD, WITH NUTS & WASHERS SUITABLE FOR CONNECTIONS SHOWN IN THIS DRAWING	H.D.G.I.	1 SET	ELECTRICAL CONTRACTOR	ELECTRICAL CONTRACTOR

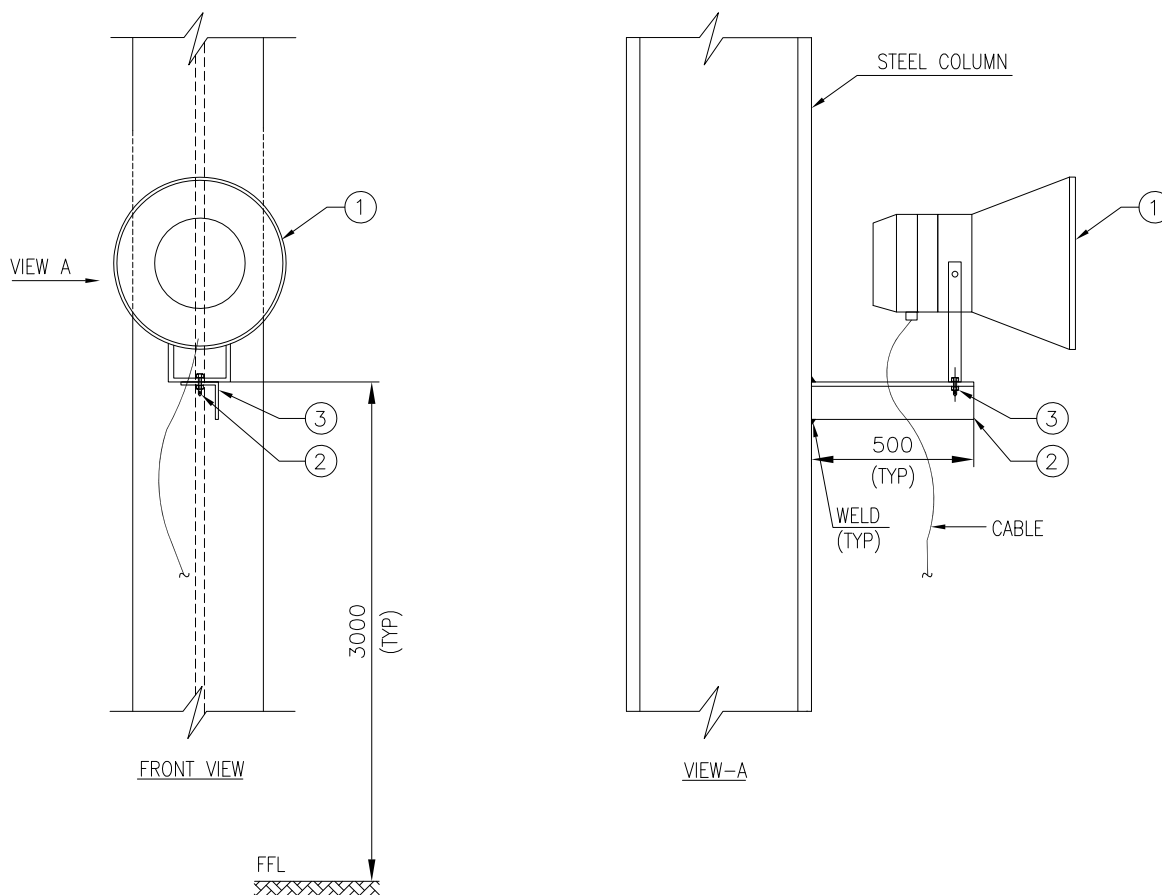


DRAWING NOT TO SCALE

NOTES

- NOTES
- 1) ALL DIMENSION ARE IN 'mm' UNLESS OTHERWISE SPECIFIED.
 - 2) STEEL SECTIONS SHALL BE PREFABRICATED & PAINTED BEFORE INSTALLATION. AREA AFFECTED DUE TO SITE WELDING SHALL BE CLEANED AND PAINTED.
 - 3) THESE DETAILS SHALL BE VERIFIED WITH ORDERED EQUIPMENT DRAWING.
 - 4) SUPPLY & INSTALLATION OF STEEL IS NOT PART OF THIS INSTALLATION ARRANGEMENT. SAME IS COVERED ELSEWHERE.

Code			Contract No.			Document ID				Part		Rev.
						PIN-LEP-ELT-4010						00
00	08.09.2017	KRP	MLD	08.09.2017	RPM	08.09.2017	RPM	ISSUED AS STANDARD				
Rev.	Date	Name		Date	Name	Date	Name	Description			Acc. Code	Status
	Drawn/Prepared			Checked		Approved						

BAR-Code	Store Location: Server/Share			
	Store Location: Folder			
	Store Name		CLSS1	
	Pro. Unit	TON	Group	Type of Document
				Sheet 1 / 1
	Con. Unit	Scale	Order No.	 thyssenkrupp
		NTS		

	Date	Name	Description INSTALLATION STANDARDS– COMMUNICATION & PA SYSTEM HORN TYPE LOUDSPEAKER ON STEEL STRUCTURE (CLSS1)
Drawn	08.09.2017	KRP	
Prepared	08.09.2017	MLD	
Checked	08.09.2017	RPM	
Approved	08.09.2017	RPM	

1	2	3	4	5	6
ITEM	DESCRIPTION	MATERIAL	QTY.	SUPPLY BY	INSTALLATION BY
1	MASTER CONTROL STATION WITH CHARACTER DISPLAY, PROGRAMMABLE KEYS, HANDSET, SPEAKER VOLUME CONTROL, DIAL PAD, GOOSE NECK MICROPHONE ETC. SUITABLE FOR DESK/CONTROL PANEL FRAME MOUNTING (REFER NOTE-2 & 3)	-	1 NO.	CLIENT	ELECTRICAL CONTRACTOR

DIGITAL MASTER CONTROL STATION

DRAWING NOT TO SCALE

NOTES

1) ALL DIMENSION ARE IN 'mm' UNLESS OTHERWISE SPECIFIED.

2) SKETCH INDICATED IS TYPICAL. EL CONTRACTOR SHALL INSTALL THE DIGITAL MASTER CONTROL STATION (MCS) IN CONSULTATION WITH SITE ENGINEER/VENDOR/CLIENT. DESK MOUNTING/ PANEL FRAME MOUNTING (FLUSHED WITH DESK) SHALL BE DECIDED AT SITE.

3) HARDWARE REQUIRED IF ANY, SUCH AS SCREWS FOR FIXING, RUBBER PAD ETC. SHALL BE SUPPLIED & INSTALLED BY EL CONTRACTOR.

Code	Contract No.	Document ID	PIN-LEP-ELT-4010	Part	Rev. 00
00	08.09.2017 KRP MLD	08.09.2017 RPM	08.09.2017 RPM	ISSUED AS STANDARD	
Rev.	Date	Name	Date	Name	Date
	Drawn/Prepared	Checked	Approved	Description	Acc. Code

BAR-Code	Store Location: Server/Share
	Store Location: Folder
	Store Name CMCS1
Pro. Unit	TON
Group	Type of Document
Sheet	1 / 1
Con. Unit	Scale
Order No.	
NTS	

Date	Name	Description
Drawn	08.09.2017 KRP	INSTALLATION STANDARDS- COMMUNICATION & PA SYSTEM MASTER CONTROL STATION ON DESK/ CONTROL PANEL FRAME (CMCS1)
Prepared	08.09.2017 MLD	
Checked	08.09.2017 RPM	
Approved	08.09.2017 RPM	

1		2		3		4	
ITEM	DESCRIPTION			MATERIAL	QTY.	SUPPLY BY	INSTALLATION BY
1	TELEPHONE/FIELD CALL STATION			PROJ. SPEC.	1 NO.	CLIENT	ELECTRICAL CONTRACTOR
2	ANCHOR FASTENER M6 x 50mm LONG WITH SUITABLE NUT & WASHER			GALVANISED STEEL / SS	2 SETS	ELECTRICAL CONTRACTOR	ELECTRICAL CONTRACTOR
3	ISMC 75			M.S. PAINTED	AS REQUIRED	(REFER NOTE-3 & 4)	
4	HEXAGONAL HEAD BOLT M10 X 30mm LONG, THREADS UPTO HEAD, WITH SUITABLE NUTS & WASHERS (REFER NOTE-3)			H.D.G.I.	4 SETS	ELECTRICAL CONTRACTOR	ELECTRICAL CONTRACTOR
5	CANOPY COVERED FROM 3 SIDES (REFER NOTE-5)			PROJ. SPEC.	1 NO.	ELECTRICAL CONTRACTOR	ELECTRICAL CONTRACTOR
6	HEXAGONAL HEAD BOLT M6 X 25mm LONG, THREADS UPTO HEAD, WITH SUITABLE NUTS & WASHERS (FOR CANOPY FIXING)			H.D.G.I.	4 SETS	ELECTRICAL CONTRACTOR	ELECTRICAL CONTRACTOR

FRONT VIEW

VIEW-A (DETAILED)

DRAWING NOT TO SCALE

NOTES

- 1) ALL DIMENSION ARE IN 'mm' UNLESS OTHERWISE STATED.
- 2) STEEL SECTIONS SHALL BE PREFABRICATED & PAINTED BEFORE INSTALLATION.
- 3) THESE DETAILS SHALL BE VERIFIED WITH ORDERED EQUIPMENT DRAWING.
- 4) SUPPLY & INSTALLATION OF STEEL IS NOT PART OF THIS INSTALLATION ARRANGEMENT. SAME IS COVERED ELSEWHERE.
- 5) CANOPY COVERED FROM 3 SIDES SHALL BE PROVIDED FOR TELEPHONE/FIELD CALL STATION INSTALLED OUTDOOR.

Code		Contract No.		Document ID		Part		Rev.	
00	08.09.2017	KRP	MLD	08.09.2017	RPM	08.09.2017	RPM	PIN-LEP-ELT-4010	
Rev.	Date	Name	Date	Name	Date	Name	Description	Acc. Code	Status
		Drawn/Prepared		Checked		Approved			

Store Location: Server/Share		Store Location: Folder		Store Name		Pro. Unit		Group		Type of Document		Sheet	
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Con. Unit		Scale		Order No.									
		NTS											

Date	Name	Description
08.09.2017	KRP	Drawn
08.09.2017	MLD	Prepared
08.09.2017	RPM	Checked
08.09.2017	RPM	Approved

thyssenkrupp

INSTALLATION STANDARDS-
COMMUNICATION & PA SYSTEM
TELEPHONE/FIELD CALL STATION ON WALL/
CONCRETE COLUMN (CTFC1)

ITEM	DESCRIPTION	MATERIAL	QTY.	SUPPLY BY	INSTALLATION BY
1	TELEPHONE/FIELD CALL STATION (FCS) WITH ACOUSTIC HOOD WITH FIXING ARRANGEMENT & HARDWARE REQUIRED FOR FIXING TELEPHONE/FCS ON HOOD	PROJ. SPEC.	1 NO.	CLIENT	ELECTRICAL CONTRACTOR
2	ANCHOR FASTENER M6 x 50mm LONG WITH SUITABLE NUT & WASHER	GALVANISED STEEL / SS	4 SETS	ELECTRICAL CONTRACTOR	ELECTRICAL CONTRACTOR
3	ISMC 75	M.S. PAINTED	AS REQUIRED	(REFER NOTE-3 & 4)	
4	HEXAGONAL HEAD BOLT M10 X 30mm LONG, THREADS UPTO HEAD, WITH SUITABLE NUTS & WASHERS (REFER NOTE-3)	H.D.G.I.	4 SETS	ELECTRICAL CONTRACTOR	ELECTRICAL CONTRACTOR

FRONT VIEW

VIEW-A

DRAWING NOT TO SCALE

NOTES


- 1) ALL DIMENSION ARE IN 'mm' UNLESS OTHERWISE STATED.
- 2) STEEL SECTIONS SHALL BE PREFABRICATED & PAINTED BEFORE INSTALLATION.
- 3) THESE DETAILS SHALL BE VERIFIED WITH ORDERED EQUIPMENT DRAWING.
- 4) SUPPLY & INSTALLATION OF STEEL IS NOT PART OF THIS INSTALLATION ARRANGEMENT. SAME IS COVERED ELSEWHERE.

Code		Contract No.		Document ID				Part		Rev.	
00	08.09.2017	KRP	MLD	08.09.2017	RPM	08.09.2017	RPM	PIN-LEP-ELT-4010		00	
Rev.	Date	Name		Date	Name	Date	Name	Description	Acc. Code	Cat. Code	Status
		Drawn/Prepared			Checked		Approved				

Store Location: Server/Share		Store Location: Folder		Store Name		Pro. Unit		Group		Type of Document		Sheet	
				CTFC2		TON						1 / 1	
Con. Unit		Scale		Order No.									
		NTS											

Date	Name	Description
08.09.2017	KRP	INSTALLATION STANDARDS- COMMUNICATION & PA SYSTEM TELEPHONE/FIELD CALL STATION ON WALL/ CONCRETE COLUMN WITH ACOUSTIC HOOD (CTFC2)
08.09.2017	MLD	
08.09.2017	RPM	
08.09.2017	RPM	

ITEM	DESCRIPTION	MATERIAL	QTY.	SUPPLY BY	INSTALLATION BY
1	TELEPHONE/FIELD CALL STATION	PROJ. SPEC.	1 NO.	CLIENT	ELECTRICAL CONTRACTOR
2	ISMC 75	M.S. PAINTED	AS REQUIRED	REFER NOTE-4	
3	25 x 3mm THK. FLAT	M.S. PAINTED	1.0 METER	REFER NOTE-4	
4	U BOLT M10 SIZE THREADED AT THE END SUITABLE FOR HANDRAIL PIPE WITH NUT & WASHERS.	H.D.G.I.	2 SETS	ELECTRICAL CONTRACTOR	ELECTRICAL CONTRACTOR
5	HEXAGONAL HEAD BOLT M10 X 30mm LONG, THREADS UPTO HEAD, WITH SUITABLE NUTS & WASHERS FOR THE CONNECTIONS SHOWN	H.D.G.I.	2 SETS	ELECTRICAL CONTRACTOR	ELECTRICAL CONTRACTOR
6	HEXAGONAL HEAD BOLT M6 X 25mm LONG, THREADS UPTO HEAD, WITH SUITABLE NUTS & WASHERS (REFER NOTE-3)	H.D.G.I.	4 SETS	ELECTRICAL CONTRACTOR	ELECTRICAL CONTRACTOR
7	CABLE TIE	PLASTIC	AS REQUIRED	ELECTRICAL CONTRACTOR	ELECTRICAL CONTRACTOR
8	CANOPY COVERED FROM 3 SIDES (REFER NOTE-5)	PROJ. SPEC.	1 NO.	ELECTRICAL CONTRACTOR	ELECTRICAL CONTRACTOR
9	HEXAGONAL HEAD BOLT M6 X 25mm LONG, THREADS UPTO HEAD, WITH SUITABLE NUTS & WASHERS (FOR CANOPY FIXING)	H.D.G.I.	4 SETS	ELECTRICAL CONTRACTOR	ELECTRICAL CONTRACTOR

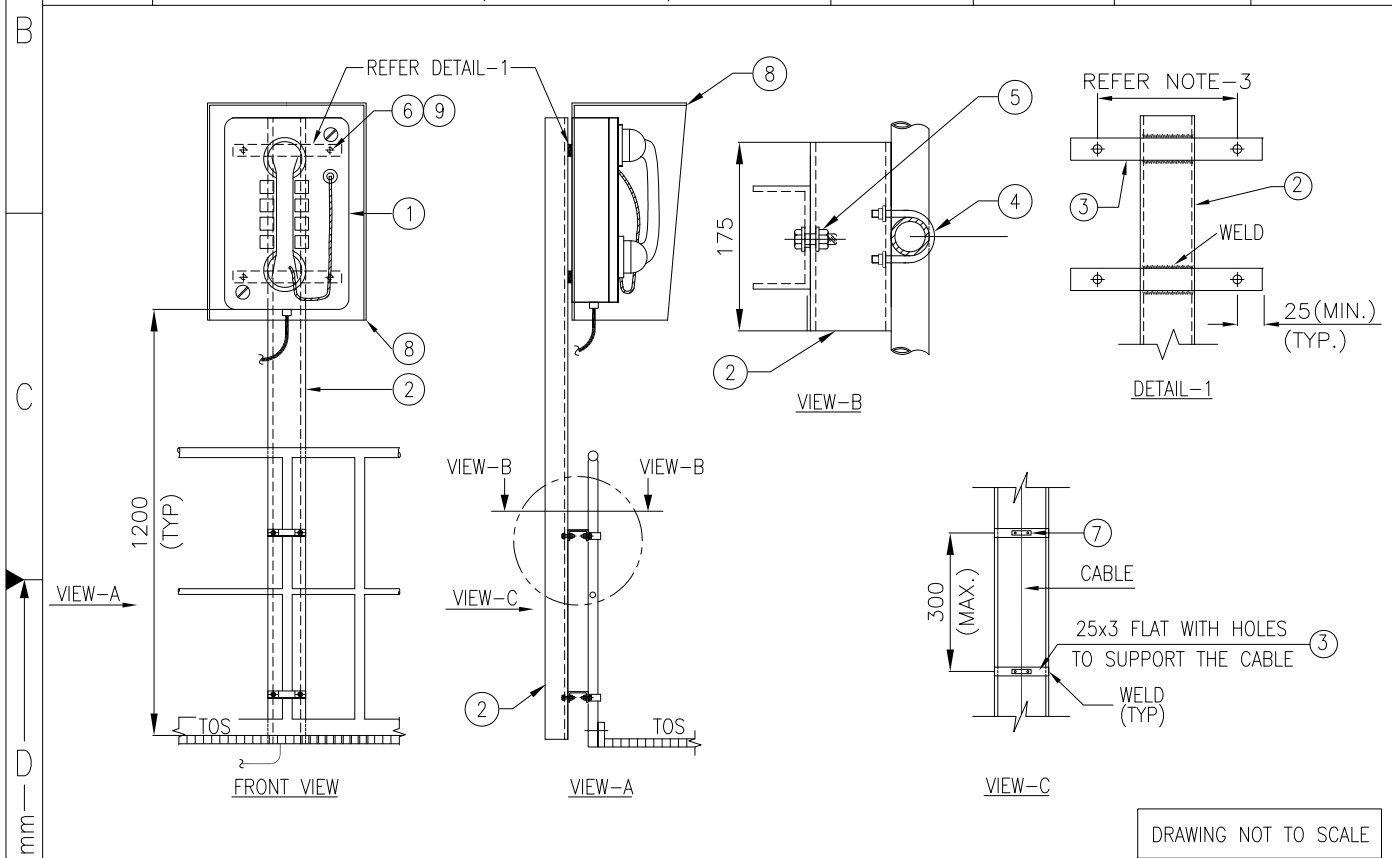

NOTES

- 1) ALL DIMENSION ARE IN 'mm' UNLESS OTHERWISE SPECIFIED.
- 2) STEEL SECTIONS SHALL BE PREFABRICATED & PAINTED BEFORE INSTALLATION. AREA AFFECTED DUE TO SITE WELDING SHALL BE CLEANED AND PAINTED.
- 3) THESE DETAILS SHALL BE VERIFIED WITH ORDERED EQUIPMENT DRAWING.
- 4) SUPPLY & INSTALLATION OF STEEL IS NOT PART OF THIS INSTALLATION ARRANGEMENT. SAME IS COVERED ELSEWHERE.
- 5) CANOPY COVERED FROM 3 SIDES SHALL BE PROVIDED FOR TELEPHONE/FIELD CALL STATION INSTALLED OUTDOOR.

Code		Contract No.		Document ID		Part		Rev.	
00		08.09.2017		PIN-LEP-ELT-4010				00	
Rev.	Date	Name	Date	Name	Date	Name	Description	Acc. Code	Status
00	08.09.2017	KRP	08.09.2017	RPM	08.09.2017	RPM	ISSUED AS STANDARD		
BAR-Code							Store Location: Server/Share		
							Store Location: Folder		
							Store Name CTFR1		
Pro. Unit		TON		Group		Type of Document		Sheet 1 / 1	
Con. Unit		Scale		Order No.					
		NTS							
Date		Name		Description					
Drawn		08.09.2017 KRP		INSTALLATION STANDARDS-					
Prepared		08.09.2017 MLD		COMMUNICATION & PA SYSTEM					
Checked		08.09.2017 RPM		TELEPHONE/ FIELD CALL STATION					
Approved		08.09.2017 RPM		ON RAILING (CTFR1)					

1	2	3	4	5	6
ITEM	DESCRIPTION	MATERIAL	QTY.	SUPPLY BY	INSTALLATION BY
1	TELEPHONE/FIELD CALL STATION (FCS) WITH ACOUSTIC HOOD WITH FIXING ARRANGEMENT & HARDWARE REQUIRED FOR FIXING TELEPHONE/FCS ON HOOD	PROJ. SPEC.	1 NO.	CLIENT	ELECTRICAL CONTRACTOR
2	ISMC 75	M.S. PAINTED	AS REQUIRED	REFER NOTE-4	
3	25 x 3mm THK. FLAT	M.S. PAINTED	0.5 METER	REFER NOTE-4	
4	U BOLT M10 SIZE THREADED AT THE END SUITABLE FOR HANDRAIL PIPE WITH NUT & WASHERS.	H.D.G.I.	2 SETS	ELECTRICAL CONTRACTOR	ELECTRICAL CONTRACTOR
5	HEXAGONAL HEAD BOLT M10 X 30mm LONG, THREADS UPTO HEAD, WITH SUITABLE NUTS & WASHERS FOR THE CONNECTIONS SHOWN	H.D.G.I.	6 SETS	ELECTRICAL CONTRACTOR	ELECTRICAL CONTRACTOR
6	HEXAGONAL HEAD BOLT M10 X 30mm LONG, THREADS UPTO HEAD, WITH SUITABLE NUTS & WASHERS (REFER NOTE-3)	H.D.G.I.	4 SETS	ELECTRICAL CONTRACTOR	ELECTRICAL CONTRACTOR
7	CABLE TIE	PLASTIC	AS REQUIRED	ELECTRICAL CONTRACTOR	ELECTRICAL CONTRACTOR

VIEW-A

FRONT VIEW

VIEW-A

VIEW-B

VIEW-C

DRAWING NOT TO SCALE

NOTES

- 1) ALL DIMENSION ARE IN 'mm' UNLESS OTHERWISE SPECIFIED.
- 2) STEEL SECTIONS SHALL BE PREFABRICATED & PAINTED BEFORE INSTALLATION. AREA AFFECTED DUE TO SITE WELDING SHALL BE CLEANED AND PAINTED.
- 3) THESE DETAILS SHALL BE VERIFIED WITH ORDERED EQUIPMENT DRAWING.
- 4) SUPPLY & INSTALLATION OF STEEL IS NOT PART OF THIS INSTALLATION ARRANGEMENT. SAME IS COVERED ELSEWHERE.

Code		Contract No.		Document ID		Part		Rev.	
				PIN-LEP-ELT-4010				00	
00	08.09.2017	KRP	MLD	08.09.2017	RPM	08.09.2017	RPM	ISSUED AS STANDARD	
Rev.	Date	Name		Date	Name	Date	Name	Description	Acc. Code
		Drawn/Prepared			Checked		Approved		

BAR-Code	Store Location: Server/Share			
	Store Location: Folder			
	Store Name CTFR2			
	Pro. Unit	TON	Group	Type of Document
	Sheet	1 / 1		
Con. Unit	Scale	Order No.		
NTS				

	Date	Name	Description
Drawn	08.09.2017	KRP	INSTALLATION STANDARDS- COMMUNICATION & PA SYSTEM TELEPHONE/ FIELD CALL STATION ON RAILING WITH ACOUSTIC HOOD (CTFR2)
Prepared	08.09.2017	MLD	
Checked	08.09.2017	RPM	
Approved	08.09.2017	RPM	

1	2	3	4
ITEM	DESCRIPTION	MATERIAL	QTY.
1	TELEPHONE/FIELD CALL STATION	PROJ. SPEC.	1 NO.
2	ISMC 75	M.S. PAINTED	AS REQUIRED
3	HEXAGONAL HEAD BOLT M10 X 30mm LONG, THREADS UPTO HEAD, WITH SUITABLE NUTS & WASHERS (REFER NOTE-3)	H.D.G.I.	4 SETS
4	CANOPY COVERED FROM 3 SIDES (REFER NOTE-5)	PROJ SPEC.	1 NO.
5	HEXAGONAL HEAD BOLT M6 X 25mm LONG, THREADS UPTO HEAD, WITH SUITABLE NUTS & WASHERS (FOR CANOPY FIXING)	H.D.G.I.	4 SETS

FRONT VIEW

VIEW-A (DETAILED)

DRAWING NOT TO SCALE

NOTES

- 1) ALL DIMENSION ARE IN 'mm' UNLESS OTHERWISE STATED.
- 2) STEEL SECTIONS SHALL BE PREFABRICATED & PAINTED BEFORE INSTALLATION. AREA AFFECTED DUE TO SITE WELDING SHALL BE CLEANED AND PAINTED.
- 3) THESE DETAILS SHALL BE VERIFIED WITH ORDERED EQUIPMENT DRAWING.
- 4) SUPPLY & INSTALLATION OF STEEL IS NOT PART OF THIS INSTALLATION ARRANGEMENT. SAME IS COVERED ELSEWHERE.
- 5) CANOPY COVERED FROM 3 SIDES SHALL BE PROVIDED FOR TELEPHONE/FIELD CALL STATION INSTALLED OUTDOOR.

Code		Contract No.		Document ID		Part		Rev.	
00	08.09.2017	KRP	MLD	08.09.2017	RPM	08.09.2017	RPM	PIN-LEP-ELT-4010	00
Rev.	Date	Name		Date	Name	Date	Name	ISSUED AS STANDARD	
		Drawn/Prepared			Checked		Approved	Description	Acc. Code
BAR-Code								Store Location: Server/Share	
								Store Location: Folder	
								Store Name	
								CTFS1	
Pro. Unit		TON		Group		Type of Document		Sheet	
								1 / 1	
Con. Unit		Scale		Order No.					
		NTS							

	Date	Name
Drawn	08.09.2017	KRP
Prepared	08.09.2017	MLD
Checked	08.09.2017	RPM
Approved	08.09.2017	RPM

Description

INSTALLATION STANDARDS-
COMMUNICATION & PA SYSTEM
TELEPHONE/FIELD CALL STATION ON
STEEL STRUCTURE (CTFS1)

1 2 3 4

ITEM DESCRIPTION MATERIAL QTY. SUPPLY BY INSTALLATION BY

1 TELEPHONE/FIELD CALL STATION (FCS) WITH ACOUSTIC HOOD WITH FIXING ARRANGEMENT & HARDWARE REQUIRED FOR FIXING TELEPHONE/FCS ON HOOD PROJ. SPEC. 1 NO. CLIENT ELECTRICAL CONTRACTOR

2 ISMC 75 M.S. PAINTED AS REQUIRED (REFER NOTE-3 & 4)

3 HEXAGONAL HEAD BOLT M10 X 30mm LONG, THREADS UPTO HEAD, WITH SUITABLE NUTS & WASHERS (REFER NOTE-3) H.D.G.I. 4 SETS ELECTRICAL CONTRACTOR ELECTRICAL CONTRACTOR

STEEL COLUMN

VIEW-A

CABLE

1200

FFL

FRONT VIEW

FIXING ARRANGEMENT FOR TELEPHONE/FCS ON HOOD

WELD (TYP)

FFL

VIEW-A

DRAWING NOT TO SCALE

NOTES

1) ALL DIMENSION ARE IN 'mm' UNLESS OTHERWISE STATED.

2) STEEL SECTIONS SHALL BE PREFABRICATED & PAINTED BEFORE INSTALLATION. AREA AFFECTED DUE TO SITE WELDING SHALL BE CLEANED AND PAINTED.

3) THESE DETAILS SHALL BE VERIFIED WITH ORDERED EQUIPMENT DRAWING.

4) SUPPLY & INSTALLATION OF STEEL IS NOT PART OF THIS INSTALLATION ARRANGEMENT. SAME IS COVERED ELSEWHERE.

Code Contract No. Document ID Part Rev.

00 08.09.2017 KRP MLD 08.09.2017 RPM 08.09.2017 RPM PIN-LEP-ELT-4010 00

Rev. Date Name Date Name Date Name Description Acc. Code Cat. Code Acc. Code Status

00 08.09.2017 KRP MLD 08.09.2017 RPM 08.09.2017 RPM PIN-LEP-ELT-4010 00

BAR-Code

Store Location: Server/Share

Store Location: Folder

Store Name cTFS2

Pro. Unit TON Group Type of Document Sheet 1 / 1

Con. Unit Scale Order No.

NTS

thysenkruupp

ISO A4

Date Name

Drawn 08.09.2017 KRP

Prepared 08.09.2017 MLD

Checked 08.09.2017 RPM


Approved 08.09.2017 RPM

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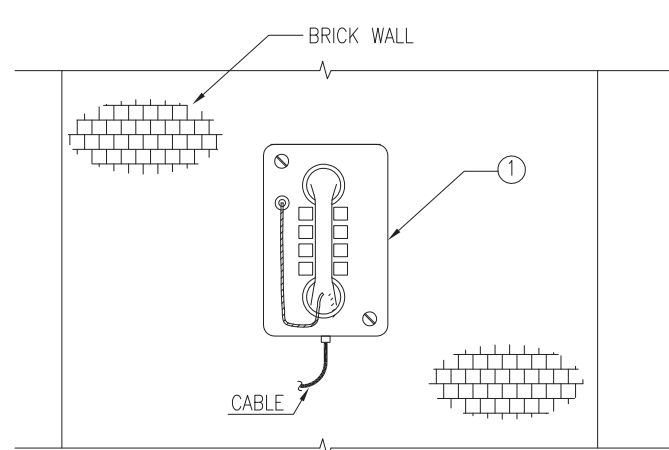
INSTALLATION STANDARDS- COMMUNICATION & PA SYSTEM TELEPHONE/FIELD CALL STATION ON STEEL STRUCTURE WITH ACOUSTIC HOOD (CTFS2)

1	2	3	4
ITEM	DESCRIPTION	MATERIAL	QTY.
1	STANDARD/VOIP PHONE WITH WALL MOUNTING ADAPTER (REFER NOTE-2 & 3)	-	1 NO.
		SUPPLY BY	CLIENT
		INSTALLATION BY	ELECTRICAL CONTRACTOR

VARIATION-1 (TYPE V1)
(ON DESK/TABLE)

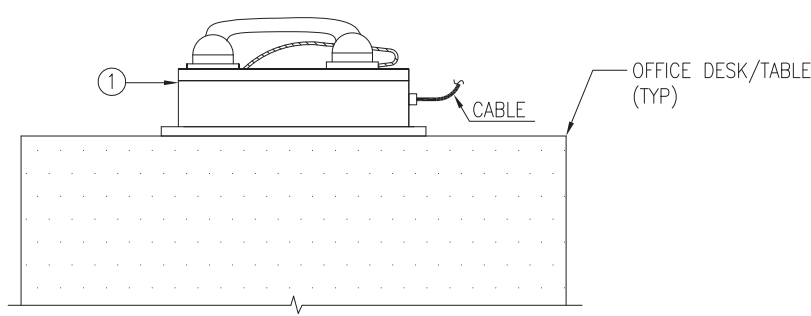

VARIATION-2 (TYPE V2)
(ON BRICK WALL)



DRAWING NOT TO SCALE

NOTES

- 1) ALL DIMENSION ARE IN 'mm' UNLESS OTHERWISE STATED.
- 2) SKETCH INDICATED IS TYPICAL. GENERALLY, INSTALLATION IS DESK/TABLE MOUNTED. MOUNTING ON WALL SHALL BE DECIDED AT SITE IN CONSULTATION WITH SITE ENGINEER/CLIENT.
- 3) HARDWARE REQUIRED FOR BRICK WALL MOUNTING SHALL BE SUPPLIED & INSTALLED BY EL CONTRACTOR.

Code				Contract No.				Document ID				Part		Rev.	
								PIN-LEP-ELT-4010						00	
00	08.09.2017	KRP	MLD	08.09.2017	RPM	08.09.2017	RPM	ISSUED AS STANDARD				Cat. Code	Acc. Code	Status	
Rev.	Date	Name		Date	Name	Date	Name	Description				Acc. Code			
Drawn/Prepared				Checked				Approved							

BAR-Code

Store Location: Server/Share

Store Location: Folder

Store Name
CTFZ1


Pro. Unit TON Group Type of Document Sheet 1 / 1

Con. Unit Scale Order No.


ISO A4

	Date	Name
Drawn	08.09.2017	KRP
Prepared	08.09.2017	MLD
Checked	08.09.2017	RPM
Approved	08.09.2017	RPM



NTS

 **thyssenkrupp**

Description
INSTALLATION STANDARDS-
COMMUNICATION & PA SYSTEM
TELEPHONE SET ON DESK/ TABLE/
BRICK WALL (CTFZ1)

Plant 1.0 MTPA ALUMINA REFINERY STREAM-5	Client NALCO	Contract Code NAL	Document ID 6695-ELT-G00-EC-0027	Contract No. 66-6695
	ELECTRICAL INSTALLATION PART- VI - INSTALLATION DETAIL- FIRE ALRAM			नालको  NALCO नेशनल एल्युमिनियम कम्पनी लिमिटेड National Aluminium Company Ltd.
				Rev 0 Page 1 of 2


INSTALLATION DETAIL- FIRE ALRAM

Plant 1.0 MTPA ALUMINA REFINERY STREAM-5	Client NALCO	Contract Code NAL	Document ID 6695-ELT-G00-EC-0027	Contract No. 66-6695
 thyssenkrupp	ELECTRICAL INSTALLATION PART- VI - INSTALLATION DETAIL- FIRE ALARM			 नेशनल एल्युमिनियम कम्पनी लिमिटेड National Aluminium Company Ltd.
				Rev 0 Page 2 of 2

LIST OF INSTALLATION STANDARDS

Sr. No.	Description	Typical No.	No. of Sheets	Rev
1	Hooter/Sounder on wall/ concrte column	FAHC1	1	00
2	Hooter/Sounder on steel structure	FAHS1	1	00
3	Hooter/Sounder on wall/ concrte column/ false ceiling	FAHZ1	1	00
4	Siren on brick/ concrete wall	FASC1	1	00
5	Siren on concrete column	FASC2	1	00
6	Siren on steel structure	FASS1	1	00
7	Beam Detector on Wall/ Concrete Column : Type 1	FBDC1	1	00
8	Beam Detector on Wall/ Concrete Column : Type 2	FBDC2	1	00
9	Beam Detector on Steel structure	FBDS1	1	00
10	Beam Reflector on wall/ concrete column	FBRC1	1	00
11	Beam Reflector on brick/concrete wall/ gypsum board	FBRC2	1	00
12	Beam Reflector on Steel Structure	FBRS1	1	00
13	Manual Call Point on Wall/ Concrete Column	FCPC1	1	00
14	Manual call point concealed in wall/ gypsum board, direct on wall/ gypsum board	FCPC2	1	00
15	Manual Call Point on Self standing Pedestal	FCPP1	1	00
16	Manual Call Point on Steel platform	FCPP2	1	00
17	Manual Call Point on railing	FCPR1	1	00
18	Manual Call Point on Steel structure	FCPS1	1	00
19	Multi-sensor detector on Concrete Ceiling	FMDC1	1	00
20	Multi-sensor detector on false ceiling	FMDF1	1	00
21	Multi-sensor detector in false floor Type-1	FMDF2	1	00
22	Multi-sensor detector in false floor Type-2	FMDF3	1	00
23	Multi-sensor detector on Steel structure	FMDS1	1	00
24	Response Indicator concealed in wall/ gypsum board	FRIC1	1	00
25	Response Indicator on False Ceiling	FRIF1	1	00
26	Linear heat sensing cable on cable tray	FSCT1	1	00

ITEM	DESCRIPTION	MATERIAL	QTY.	SUPPLY BY	INSTALLATION BY
1	HOOTER/SOUNDER	—	1 NO.	CLIENT	ELECTRICAL CONTRACTOR
2	ISA 75 (75X75X6mm)	M.S. PAINTED	AS REQUIRED	(REFER NOTE-3)	
3	HEXAGONAL HEAD BOLT M10 X 30mm LONG THREAD UPTO HEAD, WITH NUTS & WASHERS SUITABLE FOR CONNECTIONS SHOWN IN THIS DRAWING	H.D.G.I.	1 SET	ELECTRICAL CONTRACTOR	ELECTRICAL CONTRACTOR

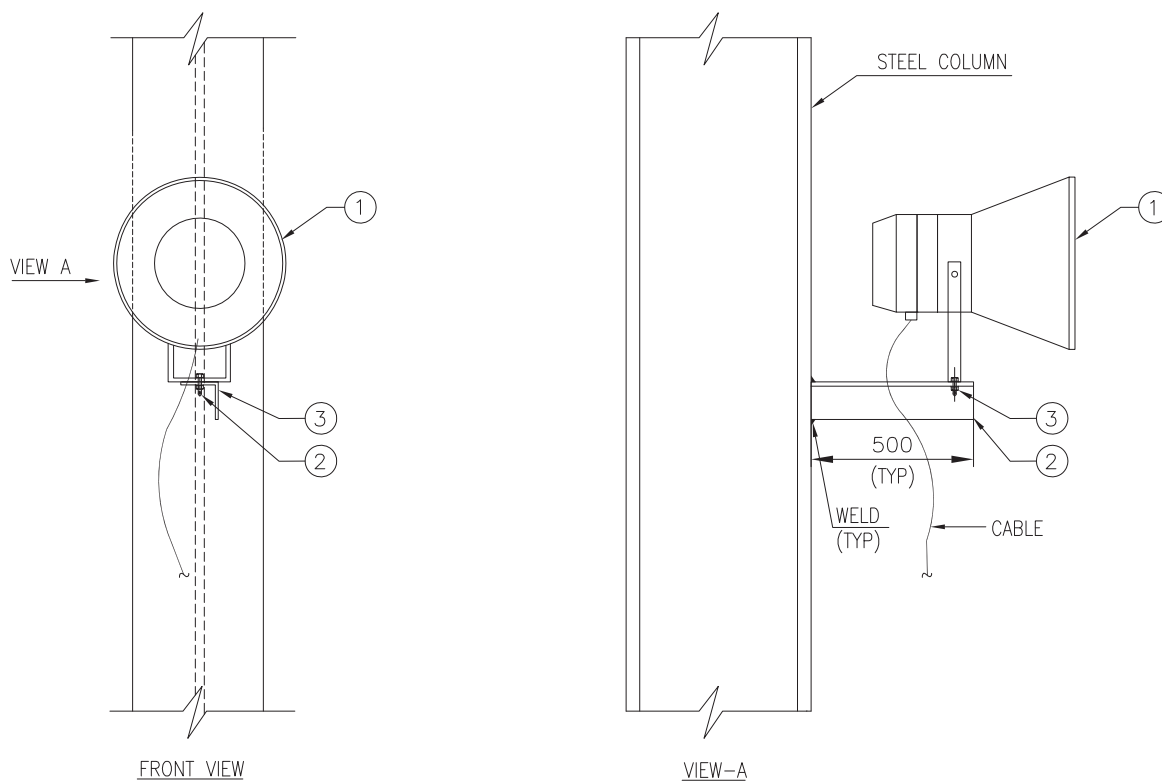

DRAWING NOT TO SCALE


NOTES

- 1) ALL DIMENSION ARE IN 'mm' UNLESS OTHERWISE SPECIFIED.
- 2) STEEL SECTIONS SHALL BE PREFABRICATED & PAINTED BEFORE INSTALLATION. AREA AFFECTED DUE TO SITE WELDING SHALL BE CLEANED AND PAINTED.
- 3) THESE DETAILS SHALL BE VERIFIED WITH ORDERED EQUIPMENT DRAWING.
- 4) SUPPLY & INSTALLATION OF STEEL IS NOT PART OF THIS INSTALLATION ARRANGEMENT. SAME IS COVERED ELSEWHERE.

ISO A4

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E

Code				Contract No.				Document ID				PIN-LEP-ELT-4011				Part		Rev.									
00		15.09.2017		KRP		MLD		15.09.2017		RPM		15.09.2017		RPM		ISSUED AS STANDARD						Cat. Code		Acc. Code		Status	
Rev.		Date		Name				Date		Name		Date		Name		Description				Acc. Code							
				Drawn/Prepared						Checked				Approved													
BAR-Code																Store Location: Server/Share											
																Store Location: Folder											
																Store Name FAHS1											
Pro. Unit				TON				Group				Type of Document				Sheet 1 / 1											
Con. Unit				Scale				Order No.				 thyssenkrupp															
				NTS																							
		Date		Name				Description																			
Drawn		15.09.2017		KRP				INSTALLATION STANDARDS – FIRE ALARM SYSTEM																			
Prepared		15.09.2017		MLD				HOOTER/SOUNDER ON STEEL STRUCTURE																			
Checked		15.09.2017		RPM				(FAHS1)																			
Approved		15.09.2017		RPM																							

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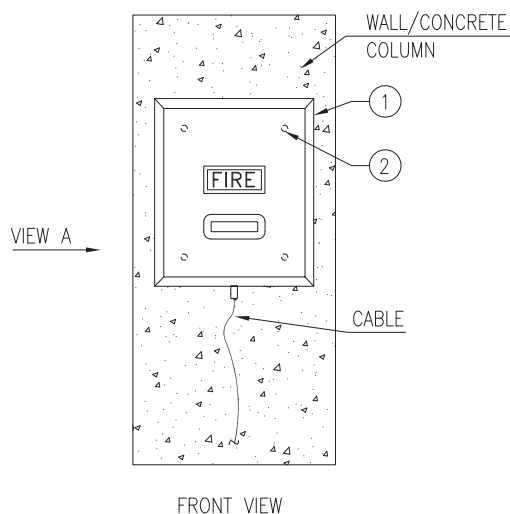
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50 mm


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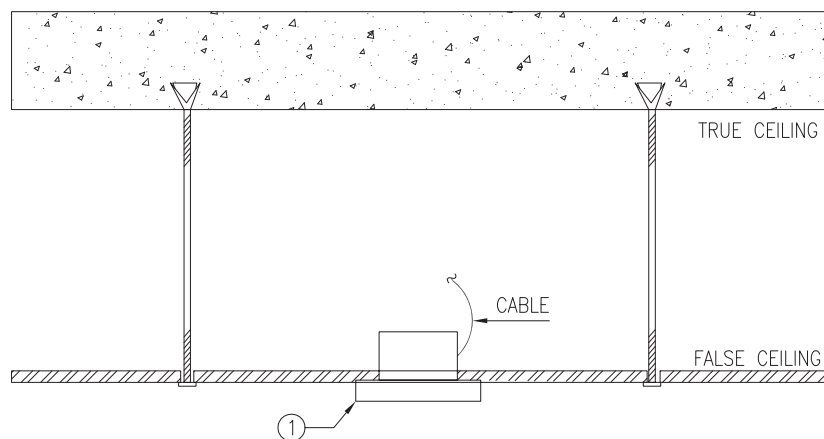
ITEM	DESCRIPTION	MATERIAL	QTY.	SUPPLY BY	INSTALLATION BY
1	HOOTER/SOUNDER	—	1 NO.	CLIENT	ELECTRICAL CONTRACTOR
2	ACCESSORIES TO FIX HOOTER/SOUNDER SUCH AS PLASTIC ANCHORS, M6 HDGI SCREWS ETC. (REFER NOTE-2)	—	4 SETS	ELECTRICAL CONTRACTOR	ELECTRICAL CONTRACTOR



FRONT VIEW




VIEW-A

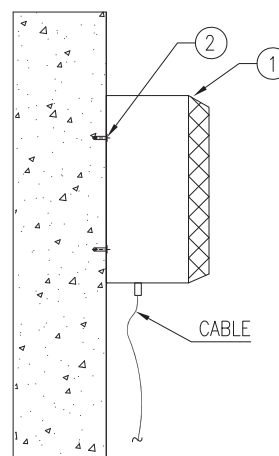HOOTER/SOUNDER ON WALL/CONCRETE COLUMN
(VARIATION-1 : TYPE V1)HOOTER/SOUNDER ON FALSE CEILING
(VARIATION-2 : TYPE V2)

DRAWING NOT TO SCALE

NOTES

- 1) ALL DIMENSION ARE IN 'mm' UNLESS OTHERWISE SPECIFIED.
- 2) THESE DETAILS SHALL BE VERIFIED WITH ORDERED EQUIPMENT DRAWING.

Code			Contract No.				Document ID				PIN-LEP-ELT-4011			Part	Rev.
00	15.09.2017	KRP	MLD	15.09.2017	RPM	15.09.2017	RPM	ISSUED AS STANDARD				Cat. Code	Acc. Code	Status	
Rev.	Date	Name		Date	Name	Date	Name	Description			Acc. Code		Acc. Code	Status	
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BAR-Code								Store Location: Server/Share							
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		Con. Unit	Scale NTS		Order No.			 thyssenkrupp							
	Date	Name						Description							
Drawn	15.09.2017	KRP						INSTALLATION STANDARDS – FIRE ALARM SYSTEM							
Prepared	15.09.2017	MLD						HOOTER/SOUNDER ON WALL/							
Checked	15.09.2017	RPM						CONCRETE COLUMN/ FALSE CEILING							
Approved	15.09.2017	RPM						(FAHZ1)							

ISO A4

1	2	3	4	5	6
ITEM	DESCRIPTION	MATERIAL	QTY.	SUPPLY BY	INSTALLATION BY
1	SIREN	—	1 NO.	CLIENT	ELECTRICAL CONTRACTOR
2	HEXAGONAL HEAD BOLT M10 X 30mm LONG, THREADS UPTO HEAD, WITH SUITABLE NUTS & WASHERS (REFER NOTE-3)	HDGI	4 SETS	ELECTRICAL CONTRACTOR	ELECTRICAL CONTRACTOR
3	ISM 75	M.S. PAINTED	AS REQUIRED	(REFER NOTE- 4)	
4	M10 x 75 LONG ANCHOR FASTENER WITH SUITABLE NUT & WASHERS	GALVANISED STEEL / SS	4 SETS	ELECTRICAL CONTRACTOR	ELECTRICAL CONTRACTOR
5	150 x 150 x10 THK PLATE	M.S. PAINTED	1 NO.	(REFER NOTE- 4)	
6	250 x 250 x10 THK PLATE	M.S. PAINTED	1 NO.	(REFER NOTE- 3 & 4)	

VIEW A

VIEW-A

DETAIL-1

DRAWING NOT TO SCALE

NOTES

- 1) ALL DIMENSION ARE IN 'mm' UNLESS OTHERWISE SPECIFIED.
- 2) STEEL SECTIONS SHALL BE PREFABRICATED & PAINTED BEFORE INSTALLATION. AREA AFFECTED DUE TO SITE WELDING SHALL BE CLEANED AND PAINTED.
- 3) THESE DETAILS SHALL BE VERIFIED WITH ORDERED EQUIPMENT DRAWING.
- 4) SUPPLY & INSTALLATION OF STEEL IS NOT PART OF THIS INSTALLATION ARRANGEMENT. SAME IS COVERED ELSEWHERE.

Code		Contract No.		Document ID		Part		Rev.	
00	15.09.2017	KRP	MLD	15.09.2017	RPM	15.09.2017	RPM	PIN-LEP-ELT-4011	00
Rev.	Date	Name		Date	Name	Date	Name	Description	Acc. Code
		Drawn/Prepared			Checked		Approved		

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Con. Unit		Scale		Order No.									
		NTS											

Date		Name		Description	
Drawn	15.09.2017	KRP		INSTALLATION STANDARDS - FIRE ALARM SYSTEM	
Prepared	15.09.2017	MLD		SIREN ON BRICK/CONCRETE WALL	
Checked	15.09.2017	RPM		(FASC1)	
Approved	15.09.2017	RPM			

1

2

50 mm

3

4

ITEM	DESCRIPTION	MATERIAL	QTY.	SUPPLY BY	INSTALLATION BY
1	SIREN	—	1 NO.	CLIENT	ELECTRICAL CONTRACTOR
2	HEXAGONAL HEAD BOLT M10 X 30mm LONG, THREADS UPTO HEAD, WITH SUITABLE NUTS & WASHERS (REFER NOTE-3)	HDGI	4 SETS	ELECTRICAL CONTRACTOR	ELECTRICAL CONTRACTOR
3	ISMC 75	M.S. PAINTED	AS REQUIRED	(REFER NOTE- 4)	
4	250 x 250 x10 THK PLATE	M.S. PAINTED	1 NO.	(REFER NOTE- 3 & 4)	
5	150 x 150 x10 THK PLATE	M.S. PAINTED	1 NO.	(REFER NOTE- 4)	
6	ISMC 100	M.S. PAINTED	AS REQUIRED	(REFER NOTE- 4)	
7	M10 x 75 LONG ANCHOR FASTENER WITH SUITABLE NUT & WASHERS	GALVANISED STEEL / SS	4 SETS	ELECTRICAL CONTRACTOR	ELECTRICAL CONTRACTOR

VIEW A

FRONT VIEW

VIEW-A

DRAWING NOT TO SCALE

NOTES

1) ALL DIMENSION ARE IN 'mm' UNLESS OTHERWISE SPECIFIED.

2) STEEL SECTIONS SHALL BE PREFABRICATED & PAINTED BEFORE INSTALLATION. AREA AFFECTED DUE TO SITE WELDING SHALL BE CLEANED AND PAINTED.

3) THESE DETAILS SHALL BE VERIFIED WITH ORDERED EQUIPMENT DRAWING.

4) SUPPLY & INSTALLATION OF STEEL IS NOT PART OF THIS INSTALLATION ARRANGEMENT. SAME IS COVERED ELSEWHERE.

Code		Contract No.			Document ID			Part		Rev.				
					PIN-LEP-ELT-4011					00				
00	15.09.2017	KRP	MLD	15.09.2017	RPM	15.09.2017	RPM	ISSUED AS STANDARD						
Rev.	Date	Name		Date	Name		Date	Name		Description				
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Con. Unit		Scale		Order No.		<div> thyssenkrupp</div>								
NTS														

	Date	Name		Description						
Drawn	15.09.2017	KRP		INSTALLATION STANDARDS - FIRE ALARM SYSTEM						
Prepared	15.09.2017	MLD		SIREN ON CONCRETE COLUMN						
Checked	15.09.2017	RPM		(FASC2)						
Approved	15.09.2017	RPM								


The image contains two technical drawings of a steel column base plate assembly.

FRONT VIEW: This drawing shows the front elevation of the assembly. A vertical dashed line represents the centerline of the **STEEL COLUMN**. Two rectangular base plates are positioned on either side of the centerline. Callouts 1 and 2 point to the top flange of the column. Callout 3 points to the base plate, with the note **WELDED TO ITEM 4**. Callout 4 points to the base plate, with the note **WELDED TO ITEM 4 & STEEL COLUMN**. Callout 5 points to the base plate. An arrow labeled **VIEW A** points to the right.

VIEW-A: This drawing shows the side elevation of the assembly. It features a circular cross-section of the column flange. Callout 1 points to the top flange, callout 2 points to the web, callout 3 points to the base plate, callout 4 points to the base plate, and callout 5 points to the base plate. A note **WELD (TYP)** points to the weld between the base plate and the column. A dimension line indicates a maximum width of **500 (MAX)**.

NOTES

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- 3) THESE DETAILS SHALL BE VERIFIED WITH ORDERED EQUIPMENT DRAWING.
- 4) SUPPLY & INSTALLATION OF STEEL IS NOT PART OF THIS INSTALLATION ARRANGEMENT. SAME IS COVERED ELSEWHERE.

BAR-Code	Store Location: Server/Share		
	Store Location: Folder		
	Store Name FASS1		
	Pro. Unit	TON	Group
	Type of Document	Sheet 1 / 1	
Con. Unit	Scale NTS	Order No.	 thyssenkrupp

	Date	Name	Description INSTALLATION STANDARDS – FIRE ALARM SYSTEM SIREN ON STEEL STRUCTURE (FASS1)
Drawn	15.09.2017	KRP	
Prepared	15.09.2017	MLD	
Checked	15.09.2017	RPM	
Approved	15.09.2017	RPM	

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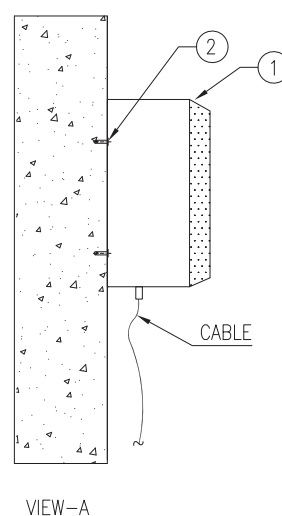
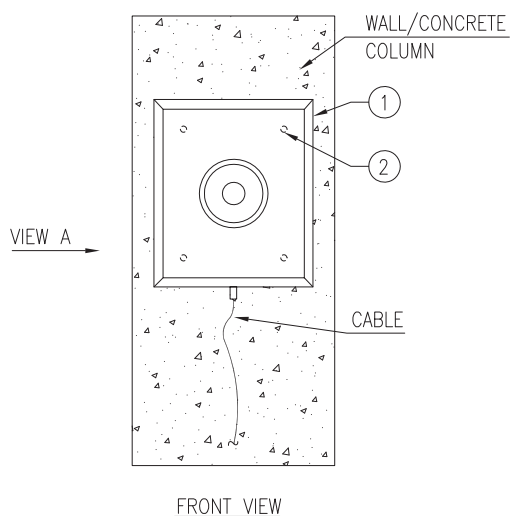
2

50 mm

3

4


ITEM	DESCRIPTION	MATERIAL	QTY.	SUPPLY BY	INSTALLATION BY
1	BEAM DETECTOR	—	1 NO.	CLIENT	ELECTRICAL CONTRACTOR
2	ACCESSORIES TO FIX BEAM DETECTOR SUCH AS PLASTIC ANCHORS, M6 HDGI SCREWS ETC. (REFER NOTE-2)	—	4 SETS	ELECTRICAL CONTRACTOR	ELECTRICAL CONTRACTOR




DRAWING NOT TO SCALE

NOTES

- 1) ALL DIMENSION ARE IN 'mm' UNLESS OTHERWISE SPECIFIED.
- 2) THESE DETAILS SHALL BE VERIFIED WITH ORDERED EQUIPMENT DRAWING.

Code				Contract No.				Document ID				PIN-LEP-ELT-4011				Part		Rev.									
00		15.09.2017		KRP		MLD		15.09.2017		RPM		15.09.2017		RPM		ISSUED AS STANDARD						Cat. Code		Acc. Code		Status	
Rev.		Date		Name				Date		Name		Date		Name		Description				Acc. Code				Acc. Code		Status	
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Con. Unit		Scale				Order No.				 thyssenkrupp																	
		NTS																									
		Date		Name		Description																					
Drawn		15.09.2017		KRP		INSTALLATION STANDARDS – FIRE ALARM SYSTEM																					
Prepared		15.09.2017		MLD		BEAM DETECTOR ON WALL/																					
Checked		15.09.2017		RPM		CONCRETE COLUMN : TYPE 1																					
Approved		15.09.2017		RPM		(FBDC1)																					


ITEM	DESCRIPTION	MATERIAL	QTY.	SUPPLY BY	INSTALLATION BY
1	BEAM DETECTOR	—	1 NO.	CLIENT	ELECTRICAL CONTRACTOR
2	HEXAGONAL HEAD BOLT M10 X 30mm LONG THREAD UPTO HEAD, WITH NUTS & WASHERS (REFER NOTE-3)	H.D.G.I.	4 SETS	ELECTRICAL CONTRACTOR	ELECTRICAL CONTRACTOR
3	ISMC 75	M.S. PAINTED	AS REQUIRED	(REFER NOTE-3 & 4)	
4	100 x 100 x 10 THK. PLATE	M.S. PAINTED	1 NO.	(REFER NOTE- 3 & 4)	

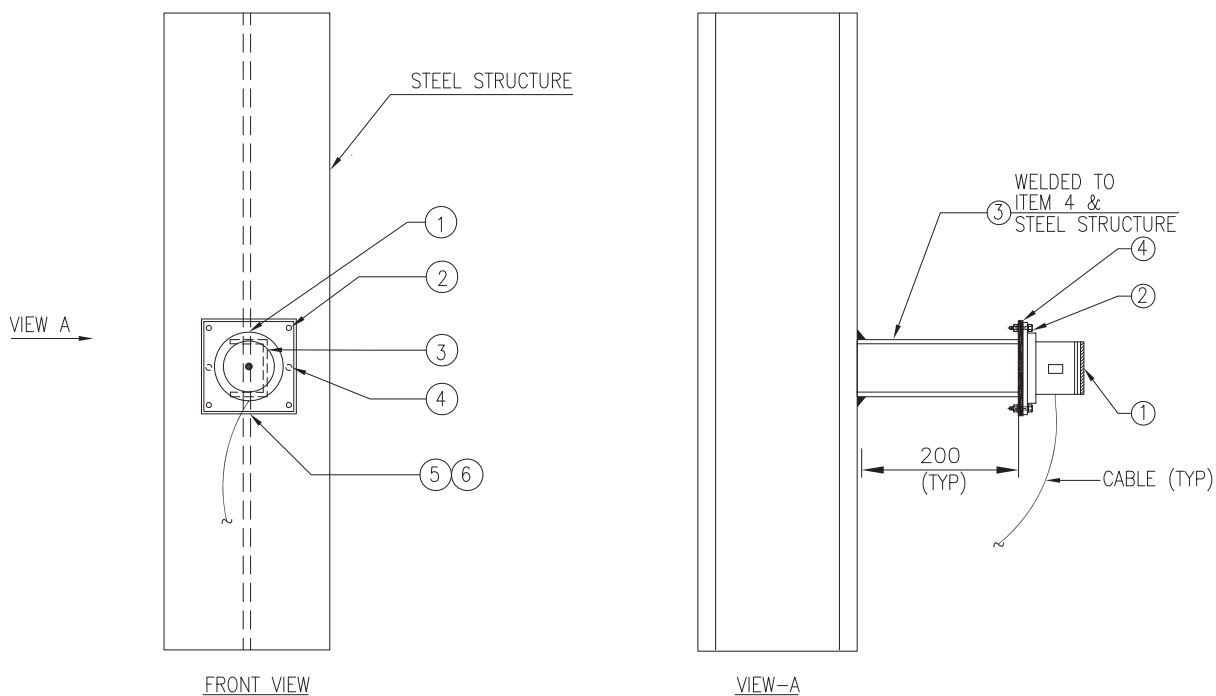

DRAWING NOT TO SCALE

NOTES

- 1) ALL DIMENSION ARE IN 'mm' UNLESS OTHERWISE SPECIFIED.
- 2) STEEL SECTIONS SHALL BE PREFABRICATED & PAINTED BEFORE INSTALLATION. AREA AFFECTED DUE TO SITE WELDING SHALL BE CLEANED AND PAINTED.
- 3) THESE DETAILS SHALL BE VERIFIED WITH ORDERED EQUIPMENT DRAWING.
- 4) SUPPLY & INSTALLATION OF STEEL IS NOT PART OF THIS INSTALLATION ARRANGEMENT. SAME IS COVERED ELSEWHERE.

Code				Contract No.				Document ID				PIN-LEP-ELT-4011				Part		Rev.									
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Con. Unit		Scale				Order No.				NTS																	
														 thyssenkrupp													
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Prepared		15.09.2017		MLD		BEAM DETECTOR ON STEEL STRUCTURE																					
Checked		15.09.2017		RPM		(FBDS1)																					
Approved		15.09.2017		RPM																							

ISO A4

	Date	Name
Drawn	15.09.2017	KRP
Prepared	15.09.2017	MLD
Checked	15.09.2017	RPM
Approved	15.09.2017	RPM

1	2	3	4	5	6
ITEM	DESCRIPTION	MATERIAL	QTY.	SUPPLY BY	INSTALLATION BY
1	BEAM REFLECTOR	—	1 NO.	CLIENT	ELECTRICAL CONTRACTOR
2	HEXAGONAL HEAD BOLT M6 X 25mm LONG, THREADS UPTO HEAD, WITH SUITABLE NUTS & WASHERS (REFER NOTE-3)	HDGI	4 SETS	ELECTRICAL CONTRACTOR	ELECTRICAL CONTRACTOR
3	ANCHOR FASTENER M8 x 75 LONG WITH SUITABLE NUT & WASHER	GALVANISED STEEL / SS	2 SETS	ELECTRICAL CONTRACTOR	ELECTRICAL CONTRACTOR
4	25 x 3mm THK. FLAT AS INDICATED IN PLAN VIEW	M.S. PAINTED	AS REQUIRED	(REFER NOTE 3 & 4)	

FRONT VIEW

VIEW-A

PLAN VIEW

DRAWING NOT TO SCALE

NOTES

1) ALL DIMENSION ARE IN 'mm' UNLESS OTHERWISE SPECIFIED.

2) STEEL SECTIONS SHALL BE PREFABRICATED & PAINTED BEFORE INSTALLATION.

3) THESE DETAILS SHALL BE VERIFIED WITH ORDERED EQUIPMENT DRAWING.

4) SUPPLY & INSTALLATION OF STEEL IS NOT PART OF THIS INSTALLATION ARRANGEMENT. SAME IS COVERED ELSEWHERE.

Code				Contract No.				Document ID				Part		Rev.	
00				15.09.2017 KRP				15.09.2017 RPM				ISSUED AS STANDARD		00	
Rev.	Date	Name	Drawn/Prepared	Date	Name	Checked	Date	Name	Approved	Description	Acc. Code	Cat. Code	Acc. Code	Status	

BAR-Code				Store Location: Server/Share			
				Store Location: Folder			
				Store Name FBRC1			
Pro. Unit		TON		Group		Type of Document	
						Sheet 1 / 1	
Con. Unit		Scale		Order No.			
		NTS					

	Date	Name	Description
Drawn	15.09.2017	KRP	INSTALLATION STANDARDS – FIRE ALARM SYSTEM REFLECTOR ON WALL/CONCRETE COLUMN (FBRC1)
Prepared	15.09.2017	MLD	
Checked	15.09.2017	RPM	
Approved	15.09.2017	RPM	

1	2	3	4	5	6
ITEM	DESCRIPTION	MATERIAL	QTY.	SUPPLY BY	INSTALLATION BY
1	BEAM REFLECTOR	—	1 NO.	CLIENT	ELECTRICAL CONTRACTOR
2	ACCESSORIES TO FIX BEAM REFLECTOR SUCH AS PLASTIC ANCHORS, M6 HDGI SCREWS ETC. (REFER NOTE-2)	HDGI	6 SETS	ELECTRICAL CONTRACTOR	ELECTRICAL CONTRACTOR

BRICK/CONCRETE WALL/
GYPSUM BOARD

②

①

DRAWING NOT TO SCALE

NOTES

1) ALL DIMENSION ARE IN 'mm' UNLESS OTHERWISE SPECIFIED.

2) THESE DETAILS SHALL BE VERIFIED WITH ORDERED EQUIPMENT DRAWING.

Code				Contract No.				Document ID				Part		Rev.	
								PIN-LEP-ELT-4011						00	
00	15.09.2017	KRP	MLD	15.09.2017	RPM	15.09.2017	RPM	ISSUED AS STANDARD				Cat. Code	Acc. Code	Status	
Rev.	Date	Name		Date	Name	Date	Name	Description				Acc. Code			
Drawn/Prepared				Date		Checked		Date		Approved					

BAR-Code

Store Location: Server/Share

Store Location: Folder

Store Name
FBRC2

Pro. Unit TON Group Type of Document Sheet 1 / 1

Con. Unit Scale Order No.

thyssenkrupp

ISO A4

	Date	Name
Drawn	15.09.2017	KRP
Prepared	15.09.2017	MLD
Checked	15.09.2017	RPM
Approved	15.09.2017	RPM

Description

INSTALLATION STANDARDS – FIRE ALARM SYSTEM
BEAM REFLECTOR ON BRICK/CONCRETE
WALL/ GYPSUM BOARD
(FBRC2)

1	2	3	4
ITEM	DESCRIPTION	MATERIAL	QTY.
1	BEAM REFLECTOR	—	1 NO.
2	HEXAGONAL HEAD BOLT M6 X 25mm LONG, THREADS UPTO HEAD, WITH SUITABLE NUTS & WASHERS (REFER NOTE-3)	HDGI	4 SETS
3	25 x 3mm THK. FLAT	M.S. PAINTED	AS REQUIRED

STEEL STRUCTURE

VIEW A

FRONT VIEW

VIEW-A

PLAN VIEW

DRAWING NOT TO SCALE

NOTES

- 1) ALL DIMENSION ARE IN 'mm' UNLESS OTHERWISE SPECIFIED.
- 2) STEEL SECTIONS SHALL BE PREFABRICATED & PAINTED BEFORE INSTALLATION. AREA AFFECTED DUE TO SITE WELDING SHALL BE CLEANED AND PAINTED.
- 3) THESE DETAILS SHALL BE VERIFIED WITH ORDERED EQUIPMENT DRAWING.
- 4) SUPPLY & INSTALLATION OF STEEL IS NOT PART OF THIS INSTALLATION ARRANGEMENT. SAME IS COVERED ELSEWHERE.

Code				Contract No.				Document ID				Part		Rev.	
								PIN-LEP-ELT-4011						00	
00	15.09.2017	KRP	MLD	15.09.2017	RPM	15.09.2017	RPM	ISSUED AS STANDARD					Cat. Code	Acc. Code	Status
Rev.	Date	Name		Date	Name	Date	Name	Description				Acc. Code			
Drawn/Prepared				Checked				Approved							

BAR-Code

Store Location: Server/Share

Store Location: Folder

Store Name
FBR1

Pro. Unit TON Group Type of Document Sheet 1 / 1

Con. Unit Scale Order No.


ISO A4

	Date	Name
Drawn	15.09.2017	KRP
Prepared	15.09.2017	MLD
Checked	15.09.2017	RPM
Approved	15.09.2017	RPM

Description


INSTALLATION STANDARDS – FIRE ALARM SYSTEM
BEAM REFLECTOR ON STEEL STRUCTURE
(FBR1)

ITEM	DESCRIPTION	MATERIAL	QTY.	SUPPLY BY	INSTALLATION BY
1	MANUAL CALL POINT	PROJ. SPEC.	1 NO.	CLIENT	ELECTRICAL CONTRACTOR
2	ANCHOR FASTENER M6 x 50mm LONG WITH SUITABLE NUT & WASHER	GALVANISED STEEL / SS	2 SETS	ELECTRICAL CONTRACTOR	ELECTRICAL CONTRACTOR
3	ISMC 75	M.S. PAINTED	AS REQUIRED	(REFER NOTE-3 & 4)	
4	HEXAGONAL HEAD BOLT M6 X 25mm LONG, THREADS UPTO HEAD, WITH SUITABLE NUTS & WASHERS (REFER NOTE-3)	H.D.G.I.	4 SETS	ELECTRICAL CONTRACTOR	ELECTRICAL CONTRACTOR
5	CANOPY COVERED FROM 3 SIDES (REFER NOTE-5)	PROJ SPEC.	1 NO.	ELECTRICAL CONTRACTOR	ELECTRICAL CONTRACTOR
6	HEXAGONAL HEAD BOLT M6 X 25mm LONG, THREADS UPTO HEAD, WITH SUITABLE NUTS & WASHERS (FOR CANOPY FIXING)	H.D.G.I.	4 SETS	ELECTRICAL CONTRACTOR	ELECTRICAL CONTRACTOR

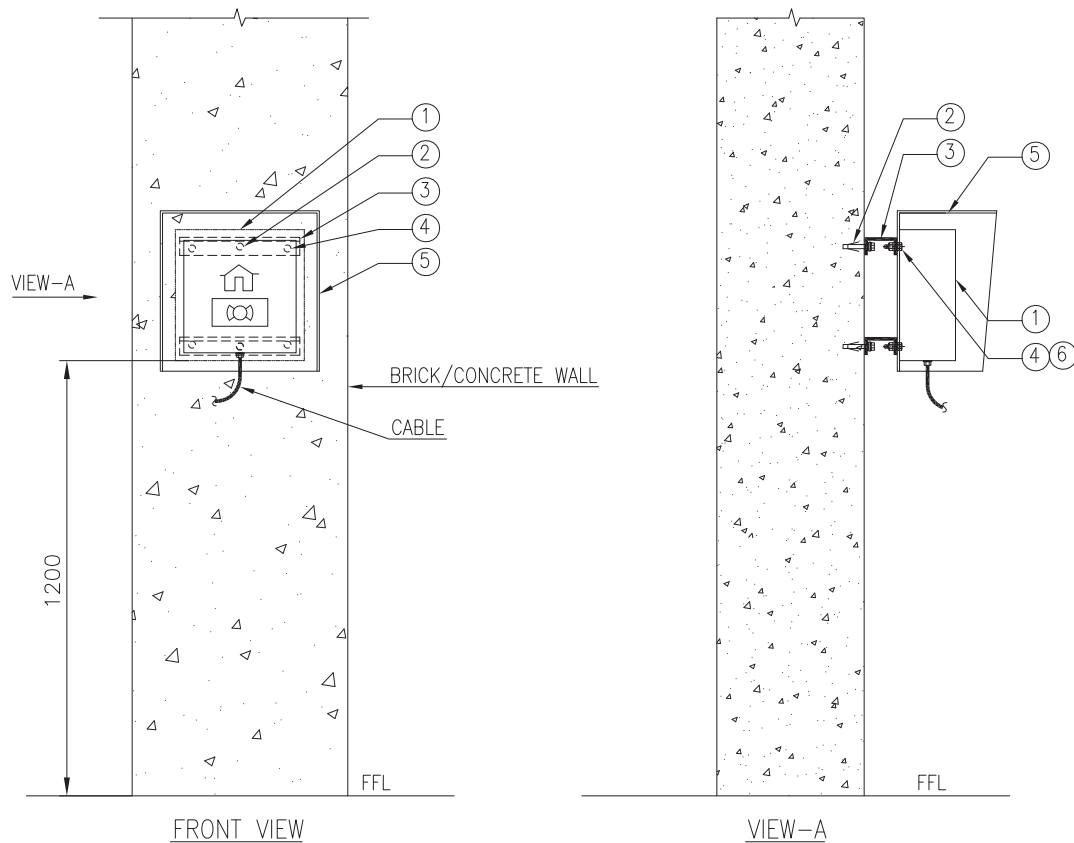

NOTES

- 1) ALL DIMENSION ARE IN 'mm' UNLESS OTHERWISE STATED.
- 2) STEEL SECTIONS SHALL BE PREFABRICATED & PAINTED BEFORE INSTALLATION.
- 3) THESE DETAILS SHALL BE VERIFIED WITH ORDERED EQUIPMENT DRAWING.
- 4) SUPPLY & INSTALLATION OF STEEL IS NOT PART OF THIS INSTALLATION ARRANGEMENT. SAME IS COVERED ELSEWHERE.
- 5) CANOPY COVERED FROM 3 SIDES SHALL BE PROVIDED FOR MANUAL CALL POINT INSTALLED OUTDOOR.

Code				Contract No.				Document ID				Part		Rev.
00				15.09.2017				PIN-LEP-ELT-4011						00
00	15.09.2017	KRP	MLD	15.09.2017	RPM	15.09.2017	RPM	ISSUED AS STANDARD			Cat. Code	Acc. Code	Status	
Rev.	Date	Name		Date	Name		Date	Name		Description	Acc. Code			
		Drawn/Prepared				Checked				Approved				
BAR-Code										Store Location: Server/Share				
										Store Location: Folder				
										Store Name FCPC1				
Pro. Unit		TON			Group		Type of Document			Sheet 1 / 1				
Con. Unit		Scale			Order No.			 thyssenkrupp						
		NTS												
	Date	Name		Description INSTALLATION STANDARDS – FIRE ALARM SYSTEM MANUAL CALL POINT MOUNTED ON WALL/CONCRETE COLUMN (FCPC1)										
Drawn	15.09.2017	KRP												
Prepared	15.09.2017	MLD												
Checked	15.09.2017	RPM												
Approved	15.09.2017	RPM												

ISO A4

	Date	Name
Drawn	15.09.2017	KRP
Prepared	15.09.2017	MLD
Checked	15.09.2017	RPM
Approved	15.09.2017	RPM

1	2	3	4	5	6
ITEM	DESCRIPTION	MATERIAL	QTY.	SUPPLY BY	INSTALLATION BY
1	MANUAL CALL POINT FOR CONCEALED/ DIRECT ON WALL MOUNTING WITH REQUIRED HARDWARE SUCH AS PLASTIC ANCHORS, M6 HDGI SCREWS ETC. (REFER NOTE-2)	-	1 NO.	CLIENT	ELECTRICAL CONTRACTOR

BRICK WALL/
GYPSUM BOARD

CHIPPING REQUIRED FOR CABLE
IN CASE OF BRICK WALL

50 mm

MANUAL CALL POINT CONCEALED IN BRICK WALL/GYPSUM BOARD
(VARIATION-1: TYPE V1)

VIEW A

50 mm

BRICK WALL/
GYPSUM BOARD

REFER NOTE-2

MANUAL CALL POINT DIRECT ON BRICK WALL/GYPSUM BOARD
(VARIATION-2: TYPE V2)

DRAWING NOT TO SCALE

NOTES

1) ALL DIMENSION ARE IN 'mm' UNLESS OTHERWISE SPECIFIED.

2) HARDWARE REQUIRED FOR INSTALLATION OF SPEAKER SHALL BE SUPPLIED & INSTALLED BY ELECTRICAL CONTRACTOR.

Code		Contract No.		Document ID				Part		Rev.	
00	15.09.2017	KRP	MLD	15.09.2017	RPM	15.09.2017	RPM	PIN-LEP-ELT-4011		00	
Rev.	Date	Name		Date	Name	Date	Name	Description	Acc. Code	Cat. Code	Status
		Drawn/Prepared			Checked		Approved				

BAR-Code

Store Location: Server/Share

Store Location: Folder

Store Name
FCPC2

Pro. Unit: TON Group: Type of Document: Sheet: 1 / 1

Con. Unit: Scale: Order No.: **thyssenkrupp**

ISO A4

	Date	Name
Drawn	15.09.2017	KRP
Prepared	15.09.2017	MLD
Checked	15.09.2017	RPM
Approved	15.09.2017	RPM

Description

INSTALLATION STANDARDS – FIRE ALARM SYSTEM
MANUAL CALL POINT CONCEALED IN WALL/
GYPSUM BOARD, DIRECT ON WALL/ GYPSUM
BOARD (FCPC2)

1		2		3		4	
ITEM	DESCRIPTION			MATERIAL	QTY.	SUPPLY BY	INSTALLATION BY
1	MANUAL CALL POINT			PROJ. SPEC.	1 NO.	CLIENT	ELECTRICAL CONTRACTOR
2	ISMC 75			M.S. PAINTED	AS REQUIRED	REFER NOTE-4	
3	150 x 150 x10 THK PLATE			M.S. PAINTED	1 NO.	REFER NOTE-4	
4	25 x 3mm THK. FLAT			M.S. PAINTED	1 METER	REFER NOTE-3 & 4	
5	HEXAGONAL HEAD BOLT M6 X 25mm LONG, THREADS UPTO HEAD, WITH SUITABLE NUTS & WASHERS (REFER NOTE-3)			H.D.G.I.	4 SETS	ELECTRICAL CONTRACTOR	ELECTRICAL CONTRACTOR
6	ANCHOR FASTENER M8 x 75 LONG WITH SUITABLE NUT & WASHER			GALVANISED STEEL / SS	4 NOS.	ELECTRICAL CONTRACTOR	ELECTRICAL CONTRACTOR
7	CABLE TIE			PLASTIC	AS REQUIRED	ELECTRICAL CONTRACTOR	ELECTRICAL CONTRACTOR
8	EDGE PROTECTION FOR CABLE			RUBBER	1 NO.	ELECTRICAL CONTRACTOR	ELECTRICAL CONTRACTOR
9	200x200x100 (LxWxH)mm PEDESTAL			CONCRETE (GRADE M20)	AS REQUIRED	ELECTRICAL CONTRACTOR	ELECTRICAL CONTRACTOR
10	CANOPY COVERED FROM 3 SIDES (REFER NOTE-5)			PROJ. SPEC.	1 NO.	ELECTRICAL CONTRACTOR	ELECTRICAL CONTRACTOR
11	HEXAGONAL HEAD BOLT M6 X 25mm LONG, THREADS UPTO HEAD, WITH SUITABLE NUTS & WASHERS (FOR CANOPY FIXING)			H.D.G.I.	4 SETS	ELECTRICAL CONTRACTOR	ELECTRICAL CONTRACTOR

NOTES

- ALL DIMENSION ARE IN 'mm' UNLESS OTHERWISE STATED.
- STEEL SECTIONS SHALL BE PREFABRICATED & PAINTED BEFORE INSTALLATION. AREA AFFECTED DUE TO SITE WELDING SHALL BE CLEANED AND PAINTED.
- THESE DETAILS SHALL BE VERIFIED WITH ORDERED EQUIPMENT DRAWING.
- SUPPLY & INSTALLATION OF STEEL IS NOT PART OF THIS INSTALLATION ARRANGEMENT. SAME IS COVERED ELSEWHERE.
- CANOPY COVERED FROM 3 SIDES SHALL BE PROVIDED FOR MANUAL CALL POINT INSTALLED OUTDOOR.
- IN CASE OF ACID PROOF/BRICK LINING AREA, SUCH ARRANGEMENT SHALL BE FOLLOWED BY EL CONTRACTOR BEFORE START OF LINING WORK

DRAWING NOT TO SCALE

Code		Contract No.		Document ID		Part		Rev.	
00	15.09.2017	KRP	MLD	15.09.2017	RPM	15.09.2017	RPM	PIN-LEP-ELT-4011	00
Rev.	Date	Name	Drawn/Prepared	Date	Name	Date	Name	Description	Acc. Code

Store Location: Server/Share		Store Location: Folder		Store Name	
				FCPP1	
Pro. Unit	TON	Group	Type of Document	Sheet 1 / 1	
Con. Unit	Scale	Order No.	NTS		


Date	Name	Description
Drawn	15.09.2017 KRP	INSTALLATION STANDARDS – FIRE ALARM SYSTEM MANUAL CALL POINT ON SELF STANDING PEDESTAL (FCPP1)
Prepared	15.09.2017 MLD	
Checked	15.09.2017 RPM	
Approved	15.09.2017 RPM	



- DRAWING NOT TO SCALE

ISO A4

A	1	2	50 mm	3	4	
	ITEM	DESCRIPTION	MATERIAL	QTY.	SUPPLY BY	INSTALLATION BY
	1	MANUAL CALL POINT	PROJ. SPEC.	1 NO.	CLIENT	ELECTRICAL CONTRACTOR
	2	ISMC 75	M.S. PAINTED	AS REQUIRED	REFER NOTE-4	
	3	25 x 3mm THK. FLAT	M.S. PAINTED	1.0 METER	REFER NOTE-3 & 4	
	4	U BOLT M10 SIZE THREADED AT THE END SUITABLE FOR HANDRAIL PIPE WITH NUT & WASHERS.	H.D.G.I.	2 SETS	ELECTRICAL CONTRACTOR	ELECTRICAL CONTRACTOR
	5	HEXAGONAL HEAD BOLT M6 X 25mm LONG, THREADS UPTO HEAD, WITH SUITABLE NUTS & WASHERS (REFER NOTE-3)	H.D.G.I.	6 SETS	ELECTRICAL CONTRACTOR	ELECTRICAL CONTRACTOR
	6	CABLE TIE	PLASTIC	AS REQUIRED	ELECTRICAL CONTRACTOR	ELECTRICAL CONTRACTOR
	7	EDGE PROTECTION FOR CABLE	RUBBER	1 NO.	ELECTRICAL CONTRACTOR	ELECTRICAL CONTRACTOR
	8	CANOPY COVERED FROM 3 SIDES (REFER NOTE-5)	PROJ. SPEC.	1 NO.	ELECTRICAL CONTRACTOR	ELECTRICAL CONTRACTOR
9	HEXAGONAL HEAD BOLT M6 X 25mm LONG, THREADS UPTO HEAD, WITH SUITABLE NUTS & WASHERS (FOR CANOPY FIXING)	H.D.G.I.	4 SETS	ELECTRICAL CONTRACTOR	ELECTRICAL CONTRACTOR	

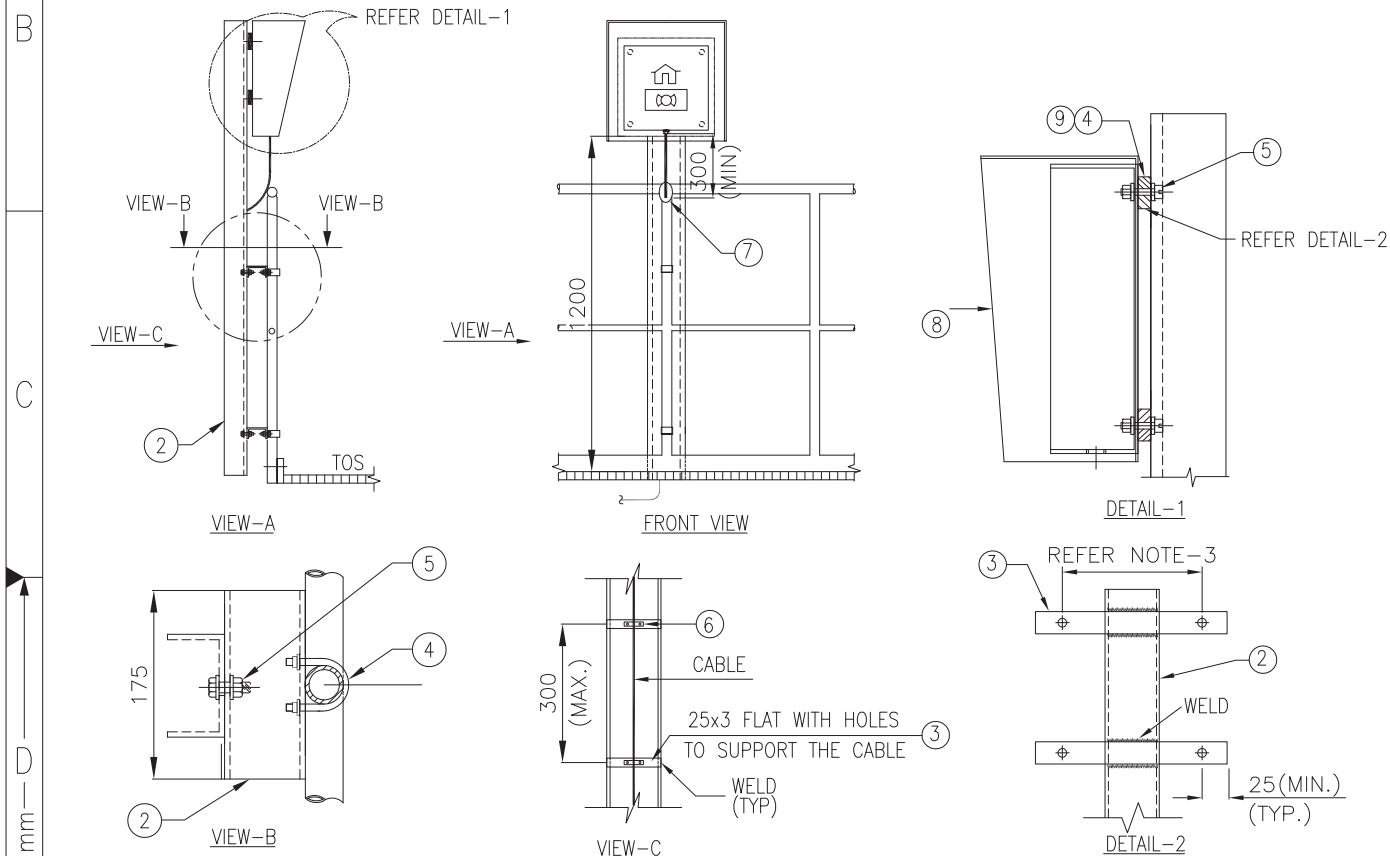

NOTES

- 1) ALL DIMENSION ARE IN 'mm' UNLESS OTHERWISE STATED.
- 2) STEEL SECTIONS SHALL BE PREFABRICATED & PAINTED BEFORE INSTALLATION. AREA AFFECTED DUE TO SITE WELDING SHALL BE CLEANED AND PAINTED.
- 3) THESE DETAILS SHALL BE VERIFIED WITH ORDERED EQUIPMENT DRAWING.
- 4) SUPPLY & INSTALLATION OF STEEL IS NOT PART OF THIS INSTALLATION ARRANGEMENT. SAME IS COVERED ELSEWHERE.
- 5) CANOPY COVERED FROM 3 SIDES SHALL BE PROVIDED FOR MANUAL CALL POINT INSTALLED OUTDOOR.

DRAWING NOT TO SCALE

Code	Contract No.	Document ID	Part	Rev.
00	15.09.2017	KRP	MLD	15.09.2017
Rev.	Date	Name	Date	Name
Drawn/Prepared	Checked	Approved	Description	Acc. Code
BAR-Code	Store Location: Server/Share	Store Location: Folder	Store Name	FCPR1
Pro. Unit	TON	Group	Type of Document	Sheet
Con. Unit	Scale	Order No.	NTS	1 / 1
thysenkrupp	Description			
thysenkrupp	INSTALLATION STANDARDS – FIRE ALARM SYSTEM			
thysenkrupp	MANUAL CALL POINT ON RAILING			
thysenkrupp	(FCPR1)			
Date	Name			
Drawn	15.09.2017	KRP		
Prepared	15.09.2017	MLD		
Checked	15.09.2017	RPM		
Approved	15.09.2017	RPM		

WELD (TYP)

5 3 2

4 1

F.F.L.

VIEW-A

	Date	Name		Description
Drawn	15.09.2017	KRP		INSTALLATION STANDARDS – FIRE ALARM SYSTEM MANUAL CALL POINT ON STEEL STRUCTURE (FCPS1)
Prepared	15.09.2017	MLD		
Checked	15.09.2017	RPM		
Approved	15.09.2017	RPM		

1


2

50 mm

3

4


ITEM	DESCRIPTION	MATERIAL	QTY.	SUPPLY BY	INSTALLATION BY
1	MULTI-SENSOR DETECTOR WITH BASE AND JUNCTION BOX	—	1 NO.	CLIENT	ELECTRICAL CONTRACTOR
2	HARDWARE TO FIX DETECTOR, JUNCTION BOX SUCH AS PLASTIC ANCHORS, SUITABLE SIZE SCREWS ETC. (REFER NOTE-2)	HDGI	AS REQUIRED	ELECTRICAL CONTRACTOR	ELECTRICAL CONTRACTOR

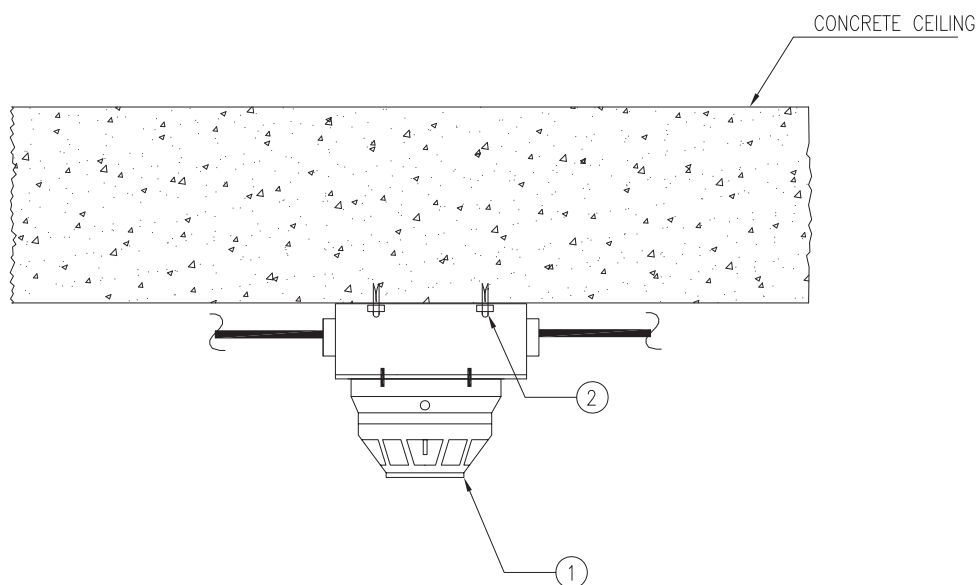

DRAWING NOT TO SCALE

NOTES

- 1) ALL DIMENSION ARE IN 'mm' UNLESS OTHERWISE SPECIFIED.
- 2) THESE DETAILS SHALL BE VERIFIED WITH ORDERED EQUIPMENT DRAWING.

Code				Contract No.				Document ID				PIN-LEP-ELT-4011				Part		Rev.							
00		15.09.2017		KRP		MLD		15.09.2017		RPM		15.09.2017		RPM		ISSUED AS STANDARD				Cat. Code		Acc. Code		Status	
Rev.		Date		Name		Date		Name		Date		Name		Description				Acc. Code							
		Drawn/Prepared				Date		Checked				Date		Approved											
BAR-Code														Store Location: Server/Share											
														Store Location: Folder											
														Store Name											
														FMDC1											
Pro. Unit				TON				Group				Type of Document				Sheet									
																1 / 1									
Con. Unit				Scale				Order No.				 thyssenkrupp													
				NTS																					
		Date		Name		Description INSTALLATION STANDARDS – FIRE ALARM SYSTEM MULTI-SENSOR DETECTOR ON CONCRETE CEILING (FMDC1)																			
Drawn		15.09.2017		KRP																					
Prepared		15.09.2017		MLD																					
Checked		15.09.2017		RPM																					
Approved		15.09.2017		RPM																					

ISO A4

	Date	Name
Drawn	15.09.2017	KRP
Prepared	15.09.2017	MLD
Checked	15.09.2017	RPM
Approved	15.09.2017	RPM

1	2	3	4	5	6
ITEM	DESCRIPTION	MATERIAL	QTY.	SUPPLY BY	INSTALLATION BY
1	MULTI-SENSOR DETECTOR WITH BASE	—	1 NO.	CLIENT	ELECTRICAL CONTRACTOR
2	ACCESSORIES TO FIX DETECTOR SUCH AS SUITABLE SIZE SCREWS ETC. (REFER NOTE-2 & 3)	—	AS REQUIRED	ELECTRICAL CONTRACTOR	ELECTRICAL CONTRACTOR

TRUE CEILING

FALSE CEILING

②
①

DRAWING NOT TO SCALE

NOTES

1) ALL DIMENSION ARE IN 'mm' UNLESS OTHERWISE SPECIFIED.

2) THESE DETAILS SHALL BE VERIFIED WITH ORDERED EQUIPMENT DRAWING.

3) SIMILAR INSTALLATION IS APPLICABLE IN CASE OF GYPSUM BOARD.

Code		Contract No.		Document ID		Part		Rev.	
00	15.09.2017	KRP	MLD	15.09.2017	RPM	15.09.2017	RPM	PIN-LEP-ELT-4011	
Rev.	Date	Name		Date	Name	Date	Name	Cat. Code	Acc. Code
		Drawn/Prepared			Checked		Approved		

Store Location: Server/Share		Store Location: Folder		Store Name		Pro. Unit		Group		Type of Document		Sheet	
				FMDf1		TON						1 / 1	
Con. Unit		Scale		Order No.									
		NTS											

	Date	Name	Description
Drawn	15.09.2017	KRP	INSTALLATION STANDARDS – FIRE ALARM SYSTEM MULTI-SENSOR DETECTOR ON FALSE CEILING (FMDf1)
Prepared	15.09.2017	MLD	
Checked	15.09.2017	RPM	
Approved	15.09.2017	RPM	

1	2	3	4
ITEM	DESCRIPTION	MATERIAL	QTY.
1	MULTI-SENSOR DETECTOR WITH BASE AND JUNCTION BOX	—	1 NO.
2	HARDWARE TO FIX DETECTOR, JUNCTION BOX SUCH AS SUITABLE SIZE SCREWS ETC. (REFER NOTE-3)	HDMI	AS REQUIRED
3	ISA 75 (75X75X6mm)	MS PAINTED	AS REQUIRED

DRAWING NOT TO SCALE

NOTES



- 1) ALL DIMENSION ARE IN 'mm' UNLESS OTHERWISE SPECIFIED.
- 2) STEEL SECTIONS SHALL BE PREFABRICATED & PAINTED BEFORE INSTALLATION. AREA AFFECTED DUE TO SITE WELDING SHALL BE CLEANED AND PAINTED.
- 3) THESE DETAILS SHALL BE VERIFIED WITH ORDERED EQUIPMENT DRAWING.
- 4) SUPPLY & INSTALLATION OF STEEL IS NOT PART OF THIS INSTALLATION ARRANGEMENT. SAME IS COVERED ELSEWHERE.

Code		Contract No.		Document ID		Part		Rev.	
00	15.09.2017	KRP	MLD	15.09.2017	RPM	15.09.2017	RPM	PIN-LEP-ELT-4011	
Rev.	Date	Name		Date	Name	Date	Name	Cat. Code	Acc. Code
		Drawn/Prepared			Checked		Approved		

Store Location: Server/Share		Store Location: Folder		Store Name		Pro. Unit		Group		Type of Document		Sheet	
				FMDF2		TON						1 / 1	
Con. Unit		Scale		Order No.									
		NTS											

Date		Name		Description	
Drawn	15.09.2017	KRP		INSTALLATION STANDARDS – FIRE ALARM SYSTEM	
Prepared	15.09.2017	MLD		MULTI-SENSOR DETECTOR IN FALSE FLOOR	
Checked	15.09.2017	RPM		TYPE-1 (FMDF2)	
Approved	15.09.2017	RPM			


ITEM	DESCRIPTION	MATERIAL	QTY.	SUPPLY BY	INSTALLATION BY
1	MULTI-SENSOR DETECTOR WITH BASE AND JUNCTION BOX	—	1 NO.	CLIENT	ELECTRICAL CONTRACTOR
2	HARDWARE TO FIX DETECTOR, JUNCTION BOX SUCH AS SUITABLE SIZE SCREWS ETC. (REFER NOTE-3)	HDGI	AS REQUIRED	ELECTRICAL CONTRACTOR	ELECTRICAL CONTRACTOR
3	ISA 75 (75X75X6mm)	MS PAINTED	AS REQUIRED	(REFER NOTE 3 & 4)	
4	ANCHOR FASTENER M6 x 50mm LONG WITH SUITABLE NUT & WASHER	GALVANISED STEEL / SS	2 SETS	ELECTRICAL CONTRACTOR	ELECTRICAL CONTRACTOR
5	150 x 150 x10 THK PLATE	M.S. PAINTED	1 NO.	(REFER NOTE 4)	

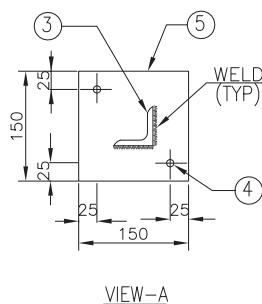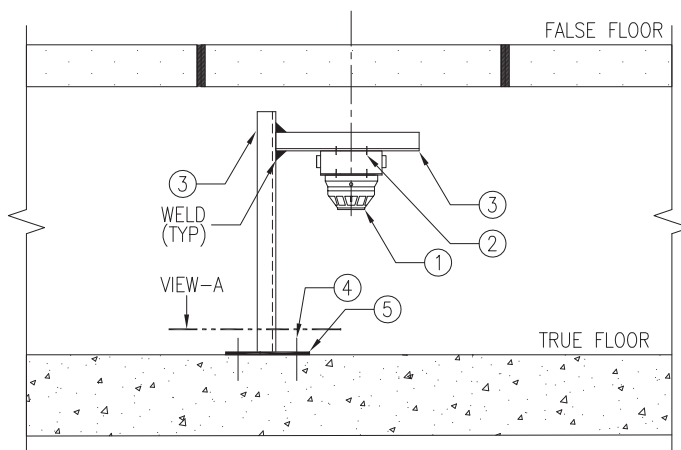

DRAWING NOT TO SCALE

NOTES

- 1) ALL DIMENSION ARE IN 'mm' UNLESS OTHERWISE SPECIFIED.
- 2) STEEL SECTIONS SHALL BE PREFABRICATED & PAINTED BEFORE INSTALLATION. AREA AFFECTED DUE TO SITE WELDING SHALL BE CLEANED AND PAINTED.
- 3) THESE DETAILS SHALL BE VERIFIED WITH ORDERED EQUIPMENT DRAWING.
- 4) SUPPLY & INSTALLATION OF STEEL IS NOT PART OF THIS INSTALLATION ARRANGEMENT. SAME IS COVERED ELSEWHERE.

Code				Contract No.				Document ID				PIN-LEP-ELT-4011				Part		Rev.							
00		15.09.2017		KRP		MLD		15.09.2017		RPM		15.09.2017		RPM		ISSUED AS STANDARD				Cat. Code		Acc. Code		Status	
Rev.		Date		Name		Date		Name		Date		Name		Description				Acc. Code				Acc. Code		Status	
		Drawn/Prepared				Checked				Approved															
BAR-Code														Store Location: Server/Share											
														Store Location: Folder											
														Store Name FMDF3											
		Pro. Unit		TON				Group		Type of Document				Sheet 1 / 1											
		Con. Unit		Scale NTS		Order No.				 thyssenkrupp															
		Date		Name		Description																			
Drawn		15.09.2017		KRP		INSTALLATION STANDARDS – FIRE ALARM SYSTEM																			
Prepared		15.09.2017		MLD		MULTI-SENSOR DETECTOR IN FALSE FLOOR																			
Checked		15.09.2017		RPM		TYPE-2 (FMDF3)																			
Approved		15.09.2017		RPM																					

ISO A4

	Date	Name
Drawn	15.09.2017	KRP
Prepared	15.09.2017	MLD
Checked	15.09.2017	RPM
Approved	15.09.2017	RPM

1		2		3		4	
ITEM	DESCRIPTION			MATERIAL	QTY.	SUPPLY BY	INSTALLATION BY
1	MULTI-SENSOR DETECTOR WITH BASE AND JUNCTION BOX			—	1 NO.	CLIENT	ELECTRICAL CONTRACTOR
2	HARDWARE TO FIX DETECTOR, JUNCTION BOX SUCH AS SUITABLE SIZE SCREWS ETC. (REFER NOTE-2)			HDGI	AS REQUIRED	ELECTRICAL CONTRACTOR	ELECTRICAL CONTRACTOR
3	ISMC 75			M.S. PAINTED	AS REQUIRED	(REFER NOTE-3 & 4)	

DRAWING NOT TO SCALE

NOTES

- 1) ALL DIMENSION ARE IN 'mm' UNLESS OTHERWISE SPECIFIED.
- 2) STEEL SECTIONS SHALL BE PREFABRICATED & PAINTED BEFORE INSTALLATION. AREA AFFECTED DUE TO SITE WELDING SHALL BE CLEANED AND PAINTED.
- 3) THESE DETAILS SHALL BE VERIFIED WITH ORDERED EQUIPMENT DRAWING.
- 4) SUPPLY & INSTALLATION OF STEEL IS NOT PART OF THIS INSTALLATION ARRANGEMENT. SAME IS COVERED ELSEWHERE.

Code		Contract No.		Document ID		Part		Rev.	
00	15.09.2017	KRP	MLD	15.09.2017	RPM	15.09.2017	RPM	PIN-LEP-ELT-4011	
Rev.	Date	Name		Date	Name	Date	Name	Description	Acc. Code
		Drawn/Prepared			Checked		Approved		

Store Location: Server/Share		Store Location: Folder		Store Name		Pro. Unit		Group		Type of Document		Sheet	
				FMDS1		TON						1 / 1	
Con. Unit		Scale		Order No.									
		NTS											

thyssenkrupp

Date	Name	Description
Drawn	15.09.2017 KRP	INSTALLATION STANDARDS – FIRE ALARM SYSTEM MULTI-SENSOR DETECTOR ON STEEL STRUCTURE (FMDS1)
Prepared	15.09.2017 MLD	
Checked	15.09.2017 RPM	
Approved	15.09.2017 RPM	

1	2	3	4	5	6
ITEM	DESCRIPTION	MATERIAL	QTY.	SUPPLY BY	INSTALLATION BY
1	RESPONSE INDICATOR (REFER NOTE-2)	—	1 NO.	CLIENT	ELECTRICAL CONTRACTOR
2	JUNCTION BOX OF SUITABLE SIZE WITH FIXING ACCESSORIES & CABLE ENTRIES (REFER NOTE- 2 & 3)	—	1 NO.	ELECTRICAL CONTRACTOR	ELECTRICAL CONTRACTOR

VARIATION-1 (TYPE V1)
INSTALLATION OF A RESPONSE INDICATOR

VARIATION-2 (TYPE V2)
INSTALLATION OF MULTIPLE RESPONSE INDICATORS

DRAWING NOT TO SCALE

NOTES

1) ALL DIMENSION ARE IN 'mm' UNLESS OTHERWISE SPECIFIED.

2) HARDWARE REQUIRED FOR INSTALLATION OF RESPONSE INDICATOR, JB SHALL BE SUPPLIED & INSTALLED BY ELECTRICAL CONTRACTOR.

3) JB SHALL BE INSTALLED IN CASE OF BRICK WALL. IN CASE OF GYPSUM BOARD, RESPONSE INDICATOR SHALL BE DIRECTLY FIXED.

Code				Contract No.				Document ID				Part		Rev.	
00	15.09.2017	KRP	MLD	15.09.2017	RPM	15.09.2017	RPM	PIN-LEP-ELT-4011						00	
Rev.	Date	Name		Date	Name	Date	Name	Description				Acc. Code	Cat. Code	Acc. Code	Status
Drawn/Prepared								Checked				Approved			

BAR-Code				Store Location: Server/Share			
				Store Location: Folder			
				Store Name FRIC1			
Pro. Unit		TON		Group		Type of Document	
						Sheet 1 / 1	
Con. Unit		Scale		Order No.			
		NTS					

	Date	Name	Description
Drawn	15.09.2017	KRP	INSTALLATION STANDARDS – FIRE ALARM SYSTEM RESPONSE INDICATOR CONCEALED IN WALL/ GYPSUM BOARD (FRIC1)
Prepared	15.09.2017	MLD	
Checked	15.09.2017	RPM	
Approved	15.09.2017	RPM	

1	2	3	4
ITEM	DESCRIPTION	MATERIAL	QTY.
1	RESPONSE INDICATOR (REFER NOTE-2)	-	1 NO.
		SUPPLY BY	INSTALLATION BY
		CLIENT	ELECTRICAL CONTRACTOR

A
B
C

TRUE CEILING

FALSE CEILING

CABLE

①

DRAWING NOT TO SCALE

NOTES

1) ALL DIMENSION ARE IN 'mm' UNLESS OTHERWISE SPECIFIED.

2) HARDWARE REQUIRED FOR INSTALLATION OF RESPONSE INDICATOR SHALL BE SUPPLIED & INSTALLED BY ELECTRICAL CONTRACTOR.

Code	Contract No.	Document ID	Part	Rev.
00	15.09.2017 KRP	MLD	15.09.2017 RPM	15.09.2017 RPM
Rev.	Date	Name	Date	Name
00	15.09.2017	KRP	15.09.2017	RPM
Drawn/Prepared		Checked	Approved	Description
BAR-Code		ISSUED AS STANDARD		
		Cat. Code		
		Acc. Code		
		Status		
		Store Location: Server/Share		
		Store Location: Folder		
		Store Name		
		FRIF1		
Pro. Unit	TON	Group	Type of Document	Sheet
				1 / 1
Con. Unit	Scale	Order No.		
	NTS			

thyssenkrupp

Date	Name	
Drawn	15.09.2017 KRP	
Prepared	15.09.2017 MLD	
Checked	15.09.2017 RPM	
Approved	15.09.2017 RPM	

ISO A4

Description

INSTALLATION STANDARDS – FIRE ALARM SYSTEM

RESPONSE INDICATOR ON FALSE CEILING

(FRIF1)

1		2		3		4		
ITEM	DESCRIPTION				MATERIAL	QTY.	SUPPLY BY	INSTALLATION BY
1	LINEAR HEAT SENSING CABLE WITH FIXING ACCESSORIES				-	-	CLIENT	ELECTRICAL CONTRACTOR

(TOC)

VIEW-A

CEILING/ BEAM

FLOOR LEVEL

TRAY ARRANGEMENT IN CABLE CELLAR (TYP)

1800 (REFER NOTE-2)

CABLE TRAY

VIEW-A

DRAWING NOT TO SCALE

NOTES

1) ALL DIMENSION ARE IN 'mm' UNLESS OTHERWISE SPECIFIED.

2) DISTANCE OF FIXING INDICATED IS TYPICAL. IT SHALL BE VERIFIED WITH VENDOR DRAWING.

Code		Contract No.		Document ID		Part		Rev.	
00	15.09.2017	KRP	MLD	15.09.2017	RPM	15.09.2017	RPM	PIN-LEP-ELT-4011	
Rev.	Date	Name	Date	Name	Date	Name	Description	Acc. Code	Status
		Drawn/Prepared		Checked		Approved			

Store Location: Server/Share		Store Location: Folder		Store Name		Pro. Unit		Group		Type of Document		Sheet	
				FSCT1		TON						1 / 1	
Con. Unit		Scale		Order No.									
		NTS											

Date	Name	Description
15.09.2017	KRP	Drawn
15.09.2017	MLD	Prepared
15.09.2017	RPM	Checked
15.09.2017	RPM	Approved

ISO A4

DESCRIPTION

INSTALLATION STANDARDS – FIRE ALARM SYSTEM
LINEAR HEAT SENSING CABLE ON
CABLE TRAY
(FSCT1)